
Xcingular

JAB & Associates, Inc.

PROPRIETARY INFORMATION

THE INFORMATION CONTAINED IN THIS SET OF CONSTRUCTION DOCUMENTS IS PROPRIETARY BY NATURE. ANY USE OR DISCLOSURE OTHER THAN THAT WHICH RELATES TO CINGULAR WIRELESS, LLC SERVICES IS STRICTLY PROHIBITED.

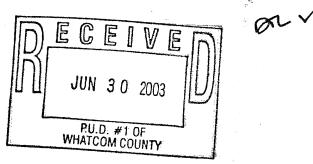

6-24-03 NOT FOT CINGULAR ROUTING

GENERAL LOCATION MAP PROJECT INFORMATION

CINGULAR WIRELESS, LLC.

PARCEL #390124392440 REMEDIES
FERNDALE, WA 98248 DUGUESTON
OF PUT 10005

NE FERNDALE

WA - 322 - 02

REVISED FINAL CONSTRUCTION **DOCUMENTS**

SHEET INDEX APPLICANT: PROPERTY 4. TOWER OWNER

PUBLIC WORKS DEPARTMENT

Exit 263 DRIVING DIRECTIONS: TAKE I-5 NORTH TO VANCOVER, EXIT 262 RIGHT ON RAMP, TURN RIGHT (WEST) ONTO MAIN STREET, TURN RIGHT (NORTH) ON CHURCH ROAD, TURN LEFT (WEST) ONTO HORTON ROAD, SITE LOCATED BY PACIFIC HEIGHTS DRIVE.

VICINITY MAP

APPROVAL/SIGN OFF OF PLANNING/ZONING DRAWINGS CONSULTANT GROUP SIGNOFF DATE CINGULAR SIGNOFF SIGNATURE LANDLORD'S REP note with C4X021 2005 RF ENGINEER ZONING RF ENGINEER MANAGER SITE AQUISITION INTERCONNECT CONSTRUCTION MANAGER EQUIPMENT ENGINEER CONSULTANT PM OPERATIONS CONSTRUCTION MANAGER CINCULAR SITE ACQUISITION MANAGER DEPLOYMENT MANAGER CINGULAR COMPLIANCE COORD. A&E COORDINATOR

SEATTLE, WA 98040 TEL: (206) 230 6648 FAX: (206) 230 6647 CONTACT: ALLEN WYTTENBACH

CODE INFORMATION: ZONING CLASSIFICATION: (RS 10.5

UBC

N/A

N/A

BUILDING CODE: CONSTRUCTION TYPE:

OCCUPANCY:

JURISDICTION: FERNDALE, WA. PROPOSED BUILDING USE: TELECOMMUNICATIONS

SITE LOCATION: (GARMIN GPS) LATITUDE: 48' 51' 39.2" N LONGITUDE: 122' 37' 22.09" W TOP OF STRUCTURE AGL: 116' EXISTING

BASE OF STRUCTURE AMSL: 196 PROJECT AREA: 162 S.F.

GENERAL INFORMATION:

PARKING REQUIREMENTS ARE UNCHANGED.

2. TRAFFIC IS UNAFFECTED.
3. NO SIGNAGE IS PROPOSED

CINQULAR WIRELESS LLC. PROPOSES TO CONSTRUCT AN UNSTAFFED RADIO
TELECOMMUNICATIONS FACILITY CONSISTING OF CINQULAR PCS ANTENNA ARRAY MOUNTED ON [E] SELF-SUPPORTING BO' MONOPOLE. (TYP. 3 SECTORS). PROPOSED CINCULAR RADIO BASE STATION (RBS) ON ACCESORY EQUIPMENT SLAB-ON-GRADE IN 9'x18' LEASE CAREA WITHIN FENCED 25'x25' PARIS UTILITY DISTRICT UTILITY AREA.

PROJECT CONSULTANTS:

JAB & ASSOCIATES 2445 140TH AVENUE NE, S.202 BELLEVUE, WA 98005 PH: (425) 753 6404 FAX: (425) 895 7099

TEAM LEAD: MARC LAMOUREUX PH: (425) 753 6404

SITE AQUISITION JIM POLLOCK PH: (206) 427 4059

ZONING AGENT: TED MCLEAN PH: (425) 753 6409

CONSTRUCTION MANAGER: ROLLA PUTNAM PH: (425) 753 6406

CONSTRUCTION COORDINATOR

SITE MANAGER KELLY SWENSEN (503) 306 7812 PARCEL NUMBER(S): 390124392440

AREA OF PARCEL: ±625 S.F.

NEW IMPERVIOUS AREA 91 S.F.

RADIO PLAN

+_1 TITLE CUEET

ANTENNA SWEEP TEST & COAX COLOR CODING ELECTRICAL & TELEPHONE DETAILS

GROUNDING PLAN

GROUNDING DETAILS & NOTES

QUALITY CONTROL CHECKLIST

LEGAL DESCRIPTION

A subdivision of the northwest quarter of the northeast quarter of Section 24, Township 39 North, Range 1 east of W.M., described as follows:

Commencing at the northeast corner of said Section 24; thence south 89'29'11" west along the north line of sold section a distance of 1325.07 feet to the northeast corner of this subdivision; thence south 00'02'37" west along the east line of soid subdivision a distance of 20.00 feet to the true point of beginning on the south line of Thornton Road (County Road No. 239); thence continue 00'02'37" west along said east line a distance of 1288.51 feet to the southeast corner of said subdivision; thence south 89'50'10" west along the south line of said subdivision a distance of 331.48 feet to the southwest carner of the east half of the southeast quarter of said subdivision a distance of 753.72; thence north 89'44'41" east parallel with the north line of the southeast quarter of said subdivision a distance of 301.36 feet; thence north 00°02'37" east; parallel with the east line of said subdivision a distance of 534.20 feet to the south line of said county road; thence north 89'39'11" the south line of soid county road a distance of 30.00 feet to the true point of beginning. Except that right-of-way lying along the northerly line thereof, commonly referred to as Thornton Road.

Situate in Whatcom County, Washington

JAB & Associates, Inc.

DATE: 03-24-03 DRAWN BY: SAM CHECKED BY: WYTT

REVISIONS DESCRIPTION 4/03 PCD SET

4/16 FCD SET 5/3 P.U.D. REVISION

6/24 P.U.D. REVISION

SITE NUMBER

WA-322-02 NE FERNDALE PARCEL #390124392440 FERNDALE, WA. 98248

LPN #03051

GEHERAL NOTES

- 1. DRAWINGS ARE NOT TO BE SCALED, WRITTEN DIMENSIONS TAKE PRECEDENCE, THIS SET OF DOCUMENTS IS INTENDED TO BE USED FOR DIAGRAMMATIC PURPOSES ONLY, UNLESS NOTED OTHERWISE. THE GENERAL CONTRACTOR'S SCOPE OF WORK SHALL INCLUDE FURNISHING ALL MATERIALS, EQUIPMENT, LABOR, AND ANY REQUIREMENTS DEEMED NECESSARY TO COMPLETE INSTALLATION AS DESCRIBED IN THE DRAWINGS AND OWNER'S PROJECT MANUAL.
- 2. DRAWINGS WERE PREPARED FROM STANDARDIZED DETAILS DEVELOPED AND PROVIDED BY W. KNOX FITZPATRICK III AND ASSOCIATES, AND CINGULAR WIRELESS, LLC.. STANDARDIZED DETAILS ARE TO BE CONFIRMED AND CORRELATED AT THE SITE BY THE CONTRACTOR. THE CONTRACTOR IS RESPONSIBLE FOR ALL DIMENSIONS. STANDARDIZED DETAILS THAT REQUIRE MODIFICATIONS DUE TO ACTUAL FIELD CONDITIONS AND REQUIREMENTS MUST BE SUBMITTED TO, AND APPROVED BY, CINGULAR WIRELESS, LLC. PRIOR TO START OF WORK.
- 3. PRIOR TO THE SUBMISSION OF BIDS, CONTRACTORS INVOLVED SHALL VISIT THE JOB SITE TO FAMILIARIZE THEMSELVES WITH ALL CONDITIONS AFFECTING THE PROPOSED PROJECT. CONTRACTORS SHALL VISIT THE CONSTRUCTION SITE WITH THE CONSTRUCTION/CONTRACT DOCUMENTS TO VERIFY FIELD CONDITIONS AND CONFIRM THAT THE PROJECT WILL BE ACCOMPLISHED AS SHOWN, PRIOR TO PROCEEDING WITH CONSTRUCTION, ANY ERRORS, OMISSIONS, OR DISCREPANCIES SHALL BE BROUGHT TO THE ATTENTION OF THE ARCHITECT/ENGINEER VERBALLY AND IN WRITING:
- 4. THE GENERAL CONTRACTOR SHALL RECEIVE WRITTEN AUTHORIZATION TO PROCEED WITH CONSTRUCTION PRIOR TO STARTING WORK ON ANY ITEM NOT CLEARLY DEFINED BY THE CONSTRUCTION DRAWINGS/CONTRACT DOCUMENTS.
- 5. THE CONTRACTOR SHALL SUPERVISE AND DIRECT THE PROJECT DESCRIBED IN THE CONTRACT DOCUMENTS. THE CONTRACTOR SHALL BE SOLELY RESPONSIBLE FOR ALL CONSTRUCTION MEANS, METHODS, TECHNIQUES, SEQUENCES, AND PROCEDURES FOR COORDINATING ALL PORTIONS OF THE WORK UNDER THE CONTRACT.

CONTRICTOR COLLECTION OF THE COLLECTION OF THE COLLECTION

STATE JURISDICTIONAL CODES BEARING ON THE PERFORMANCE OF

8. GENERAL CONTRACTOR SHALL PROVIDE, AT THE PROJECT SITE, A FULL SET OF CONSTRUCTION DOCUMENTS UPDATED WITH THE LATEST REVISIONS AND ADDENDA OR CLARIFICATIONS FOR USE BY ALL PERSONNEL INVOLVED WITH THE PROJECT. THIS SET IS A VALID CONTRACT DOCUMENT ONLY IF THE TITLE SHEET IS STAMPED

"FOR CONSTRUCTION" AND EACH SUCCESSIVE SHEET BEARS THE

9. THE STRUCTURAL COMPONENTS OF ADJACENT CONSTRUCTION OR FACILITIES ARE NOT TO BE ALTERED BY THIS CONSTRUCTION

10. SEAL ALL PENETRATIONS THROUGH FIRE-RATED AREAS WITH U.L.

11.CONTRACTOR TO PROVIDE A PORTABLE FIRE EXTINGUISHER WITH A RATING OF NOT LESS THAN 2-A OR 2-A10BC WITHIN 75 FEET TRAVEL DISTANCE TO ALL PORTIONS OF PROJECT AREA DURING

EXISTING IMPROVEMENTS, EASEMENTS, PAVING, CURBING, ETC.
DURING CONSTRUCTION. UPON COMPLETION OF WORK, CONTRACTOR
SHALL REPAIR ANY DAMAGE THAT MAY HAVE OCCURRED DUE TO

HAZARD FREE DURING CONSTRUCTION AND DISPOSE OF ALL DIRT.

DEBRIS, AND RUBBISH. CONTRACTOR SHALL REMOVE EQUIPMENT NOT SPECIFIED AS REMAINING ON THE PROPERTY OR PREMISES. SITE SHALL BE LEFT IN CLEAN CONDITION AND FREE FROM PAINT SPOTS, DUST, OR SMUDGES OF ANY NATURE.

12.CONTRACTOR SHALL MAKE NECESSARY PROVISIONS TO PROTECT

13. CONTRACTOR SHALL KEEP GENERAL WORK AREA CLEAN AND

CONSTRUCTION ON OR ABOUT THE PROPERTY.

LISTED OR FIRE MARSHALL APPROVED MATERIALS IF APPLICABLE TO THIS FACILITY AND OR PROJECT SITE.

ARCHITECT'S SIGNED WET STAMP.

PROJECT UNLESS NOTED OTHERWISE.

- 14. THE ARCHITECTS/ENGINEERS HAVE MADE EVERY EFFORT TO SET FORTH IN THE CONSTRUCTION AND CONTRACT DOCUMENTS THE COMPLETE SCOPE OF WORK. CONTRACTORS BIDDING THE JOB ARE NEVERTHELESS CAUTIONED THAT MINOR OMISSIONS OR ERRORS IN THE DRAWINGS AND OR SPECIFICATIONS SHALL NOT EXCUSE SAID CONTRACTOR FROM COMPLETING THE PROJECT AND IMPROVEMENTS IN ACCORDANCE WITH THE INTENT OF THESE DOCUMENTS. THE BIDDER SHALL BEAR THE RESPONSIBILITY OF NOTIFYING (IN WRITING) THE ARCHITECT/ENGINEER OF ANY CONFLICTS, ERRORS. OR OMISSIONS PRIOR TO SUBMISSION OF CONTRACTOR'S PROPOSAL. IN THE EVENT OF DISCREPANCIES THE CONTRACTOR SHALL PRICE THE MORE COSTLY OR EXTENSIVE WORK, UNLESS DIRECTED OTHERWISE.
- 15. THE CONTRACTOR SHALL PERFORM WORK DURING OWNER'S PREFERRED HOURS TO AVOID DISTURBING NORMAL BUSINESS.
- 16. THE CONTRACTOR SHALL PROVIDE CINGULAR WIRELESS, LLC. PROPER INSURANCE CERTIFICATES NAMING CINGULAR WIRELESS. LLC., P.U.D. NO.1 OF WHATCOM COUNTY AND CITY IF FERNDALE AS ADDITIONAL INSURED, AND CINGULAR WIRELESS, LLC. PROOF OF LICENSE(S) AND PE & PD INSURANCE.
- 17.CONTRACTOR SHALL BE RESPONSIBLE FOR SCHEDULING AND COORDINATING ALL INSPECTIONS.
- 18.CAUTION! CALL BEFORE YOU DIG! BURIED UTILITIES EXIST IN THE AREA AND UTILITY INFORMATION SHOWN MAY NOT BE COMPLETE. CONTACT THE ONE-CALL UTILITY LOCATE SERVICE A MINIMUM OF 48 HOURS PRIOR TO CONSTRUCTION. 1-800-424-5555
- 19.CONTRACTOR TO DOCUMENT ALL WORK PERFORMED WITH PHOTOGRAPHS AND SUBMIT TO CINGULAR WIRELESS, LLC. AND P.U.D. NO.1 OF WHATCOM COUNTY ALONG WITH REDLINED CONSTRUCTION SET.
- 20.CONTRACTOR TO DOCUMENT ALL CHANGES MADE IN THE FIELD BY MARKING UP (REDLINING) THE APPROVED CONSTRUCTION SET AND SUBMITTING THE REDLINED SET TO CINGULAR WIRELESS, LLC. & P.U.D. NO.1 OF WHATCOM COUNTY UPON COMPLETION.

23.ANY SUBSTITUTIONS OF MATERIALS AND/OR EQUIPMENT, MUST BE APPROVED BY CINGULAR CONSTRUCTION MANAGER

25 ELECTRICAL SERVICE TO EXISTING EQUIPMENT SHALL NOT BE INTERUPED. IN THE EVENT OF SERVICE INTERUPTION NOTIFY P.U.D. NO.1 OF WHATCOM COUNTY IMMEDIATLEY (DOUG LISSER (360) 384 4288 EXT.17)

24.IN THE CASE OF ROOFTOP SOLUTIONS FOR EQUIPMENT AND/OR ANTENNA FRAMES WHERE PENETRATION OF EXISTING ROOFING MATERIALS OCCURE, THE GENERAL CONTRACTOR SHALL COORDINATE WITH BUILDING OWNER AND BUILDING ROOFING CONTRACTOR OF RECORD FOR INSTALLATION, PATCH, REPAIR OR ANY AUGMENTATION TO THE ROOF, AND HAVE THE WORK GUARANTEED UNDER ROOFING CONTRACTORS WARRANTY FOR MOISTURE PENETRATION OR AND OTHER FUTURE BREACH OF ROOFING INTEGRITY.

SYMBOLS & ABBREVIATIONS

POWER & TELCO LINE

- TELEPHONE

---- POWER

CHAINLINK FENCE

WOOD FENCE

D 40

Α1

ANTENNA

ANTENNA MARK NO. CENTERLINE

[E] **EXISTING**

[N] NEW W/ WITH


PB0 PROVIDED BY OWNER

 $\begin{pmatrix} x \\ x-x \end{pmatrix}$ DETAIL NUMBER SHEET NUMBER V.I.F. VERIFY IN FIFI D

Ш WIREL

00


JAB & Associates, Inc

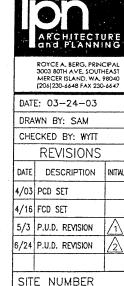



WA-322-02


LPN #03051

NE FERNDALE PARCEL #390124392440 FERNDALE, WA. 98248

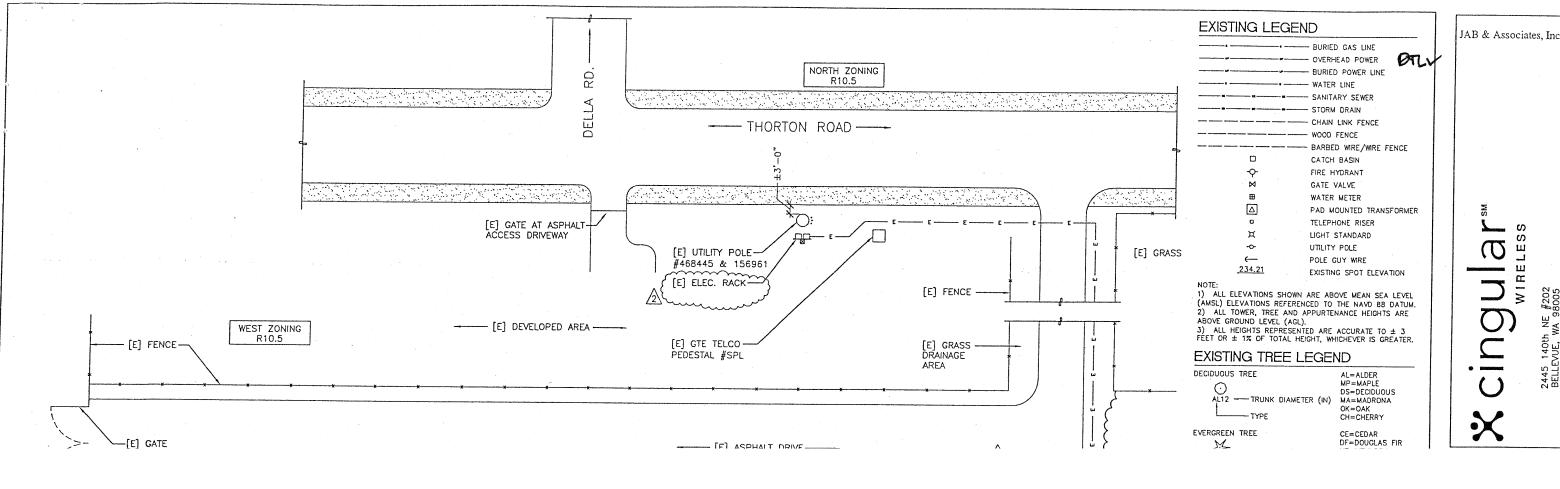

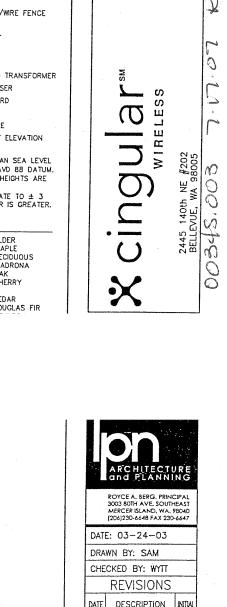


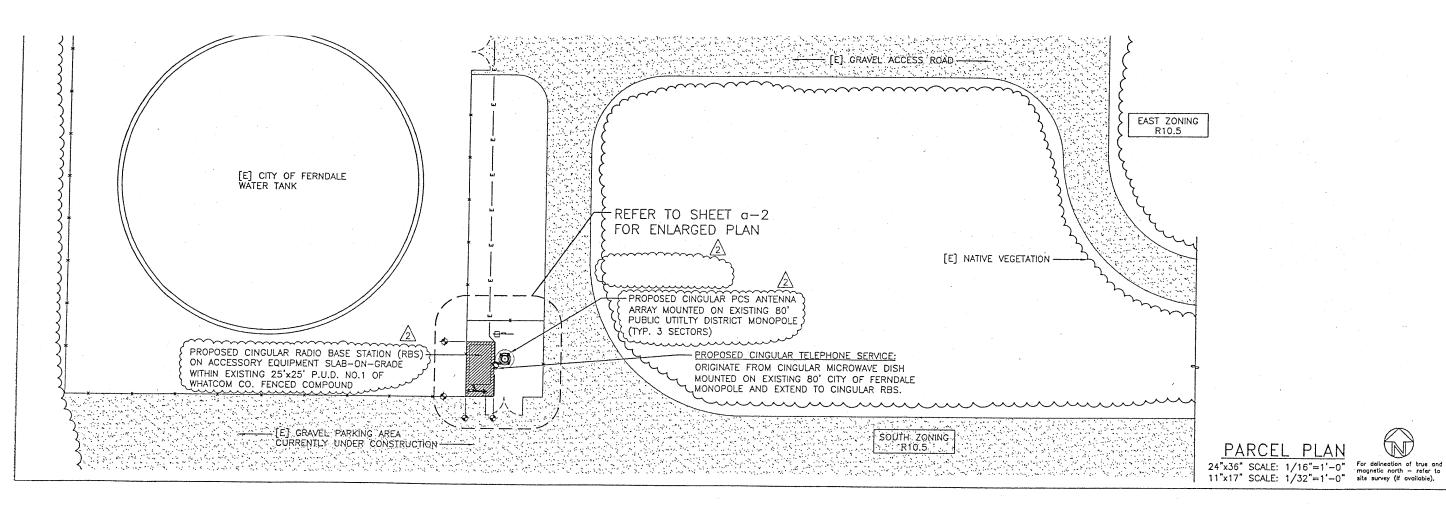

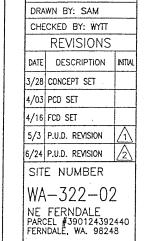

LPN #03051

a-1

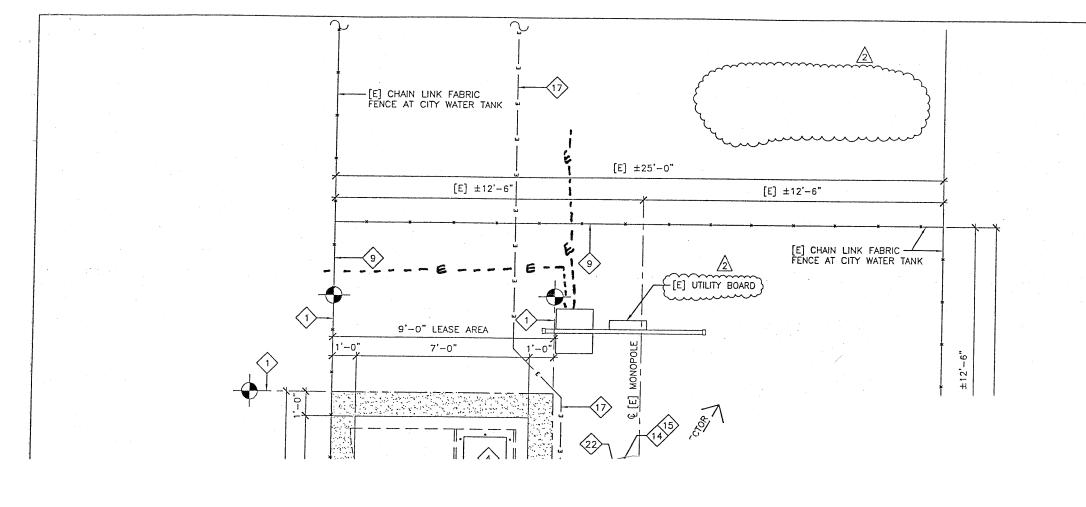

CONSTRUCTION PLAN KEYED NOTES

- CINGULAR LEASE AREA LINE.
- ACCESSORY EQUIPMENT CONCRETE SLAB ON GRADE (PROVIDED BY CONTRACTOR).

 SEE DETAILS 1 & 3/0-4.
- 3> PRIMARY RADIO BASE STATION (PROVIDED BY CINGULAR) SEE DETAILS 2, 3, & 4/0-3.
- (4) EXPANSION CABINET (PROVIDED BY CINGULAR).
- \$\\ \text{3} \quad \text{BIAS FILTER ON SUPPORTS & PLATFORM MOUNTED JUMPER TRAY.} \\ \text{5} \quad \text{SEE DETAILS 8 & 11/a-4.} \end{array}
- 6 NEW ANTENNA SUPPORT STRUCTURE (PROVIDED BY CONTRACTOR)
 MOUNTED ON EXISTING 80' MONOPOLE.


 SEE DETAILS 16/a-5
- SITE TO BE FILLED WITH 6" OF 3/4" MINUS CRUSHED ROCK ON WEED BARRIER ON 95% COMPACTED FILL COORD, WITH EXISTING COMPOUND SURFACE MATERIAL SEE DETAIL 18/0-4.
- EXISTING 7'-4" GALVANIZED CHAINLINK FABRIC FENCE
- (10) EXISTING 12'-0" WIDE CHAIN LINK FABRIC GATE AT EXISTING ENCLOSURE. (CONTRACTOR PROVIDED) LOCK PROVIDED BY CINGULAR. COORD. LOCKS W/P.U.D. & CITY OF FERNDALE.
- PCS ANTENNAS (MOUNTING HARDWARE PROVIDED WITH ANTENNAS)
 (PROVIDED BY CINGULAR)
 SEE SCHEDULE ON SHEETS 0-6, 0-7 & DETAILS 5/0-3 & 3/0-5.
- COAXIAL CABLES TO ANTENNAS (PROVIDED BY CINGULAR).

 SEE SCHEDULE ON 0-2, 0-6 & SHEET 0-7.
- PEDESTAL MOUNTED ICE BRIDGE W/ COAX SUPPORT BLOCKS (PROVIDED BY CONTRACTOR). SEE DETAIL B/0-4.
- 16 SEE SHEETS e-2 & e-3 FOR GROUNDING TYPICAL.
- 17) NEW ELECTRICAL TRENCH. SEE DETAIL 5/--

WIRELESS

140th NE #202

VUE, WA 98005

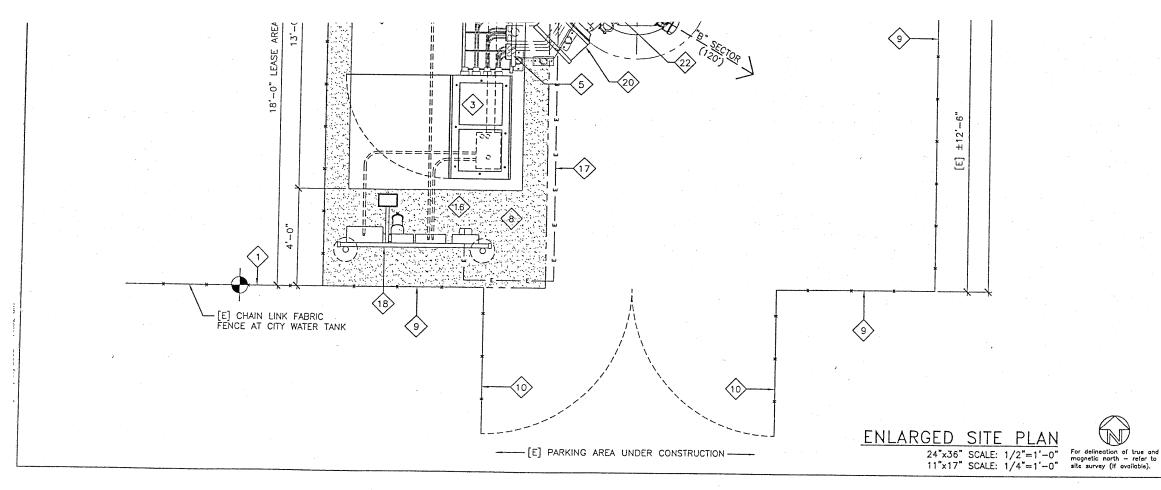

SIIE NOIES

- 1. VERIFY ANTENNA RAD CENTER AND AZIMUTHS PER FINAL RADIO PLAN. SHEET FROM RF ENGINEER.
- 2. OPTIONAL MICROWAVE REQUIREMENT SHALL BE DETERMINED BY CINGULAR MICROWAVE ENGINEER.
 CONTACT: MR. JOHN HUNTER
 PH: (206) 240-9020
 THROUGH CINGULAR CONSTRUCTION MANAGER.

COAX LENGTH SCHEDULE

į			
-	SECTOR	LENGTH	DIAMETER
	SECTOR "A"	±88'	7/8"
	SECTOR "B"	±88'	7/8"
	SECTOR "C"	±88'	7/8"



ROYCE A. BERG, PRINCIPAL 3003 BOTH AVE. SOUTHEAST MERCER ISLAND, WA. 98040 (206)230-6648 FAX 230-6647

DATE: 03-24-03
DRAWN BY: SAM

CHECKED BY: WYTT REVISIONS

DATE DESCRIPTION INITIAL
3/28 CONCEPT SET
4/03 PCD SET
4/16 FCD SET


5/3 P.U.D. REVISION
6/24 P.U.D. REVISION


SITE NUMBER

WA-322-02 NE FERNDALE PARCEL #390124392440 FERNDALE, WA. 98248


LPN #03051


a-2

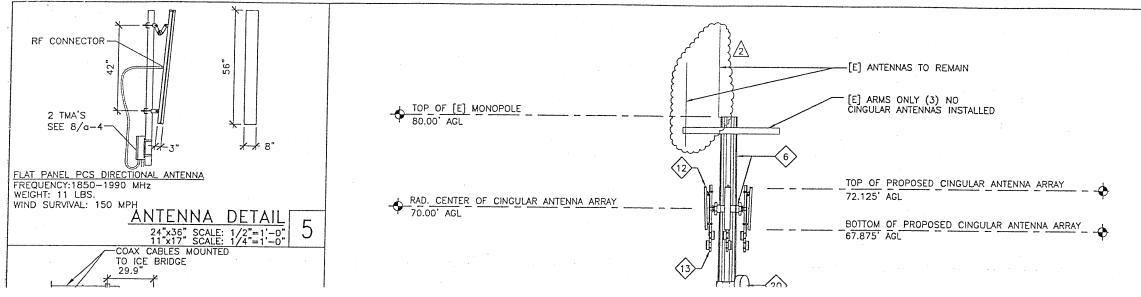


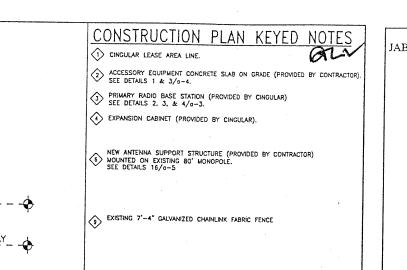

PCS ANTENNAS (MOUNTING HARDWARE PROVIDED WITH ANTENNAS)

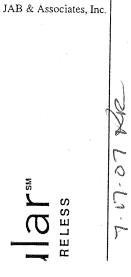

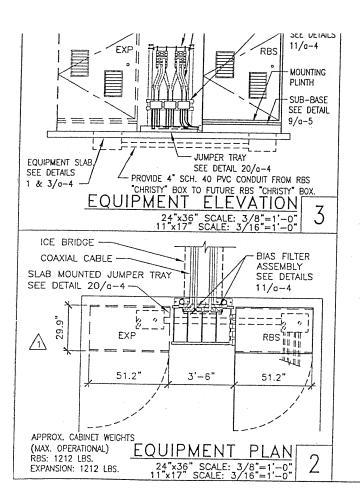

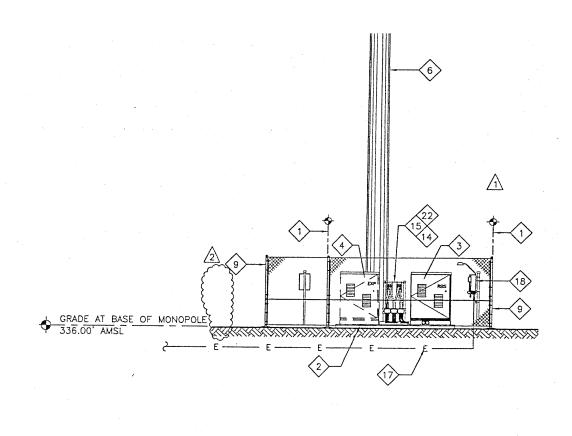


DILE MOTED

(PROVIDED BY CINGULAR)


- VERIFY ANTENNA RAD CENTER AND AZIMUTHS
 PER FINAL RADIO PLAN. SHEET FROM RF
 ENGINEER.
- 2. OPTIONAL MICROWAVE REQUIREMENT SHALL BE DETERMINED BY CINGULAR MICROWAVE ENGINEER.
 CONTACT: MR. JOHN HUNTER


PH: (206) 240-9020 THROUGH CINGULAR CONSTRUCTION MANAGER.

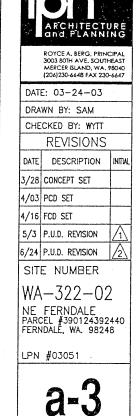



EAST ELEVATION PLAN


24"x36" SCALE: 3/16"=1'-0"
11"x17" SCALE: 3/32"=1'-0"

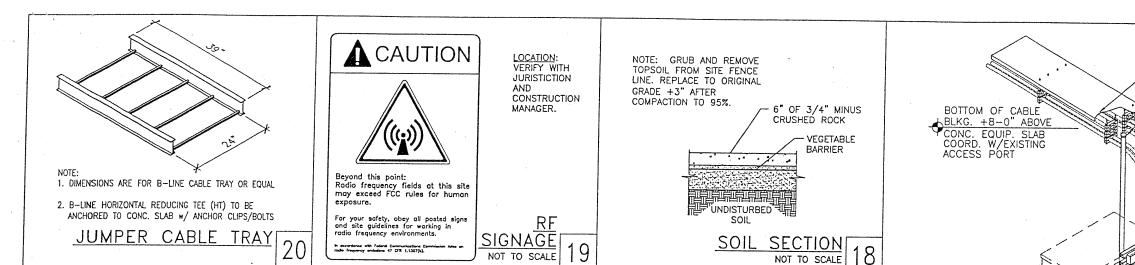


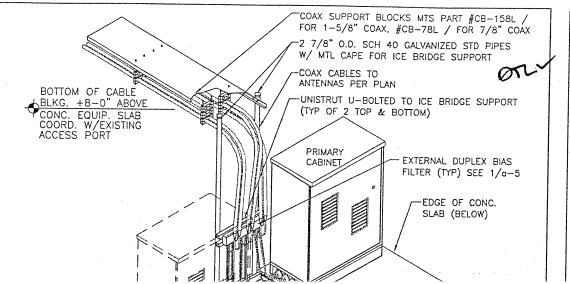


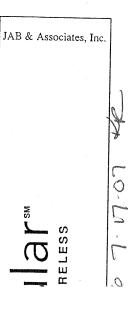


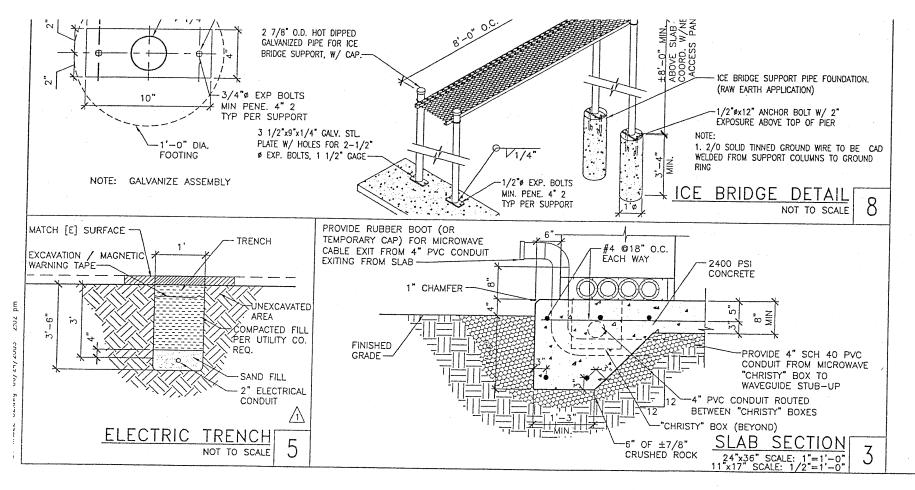

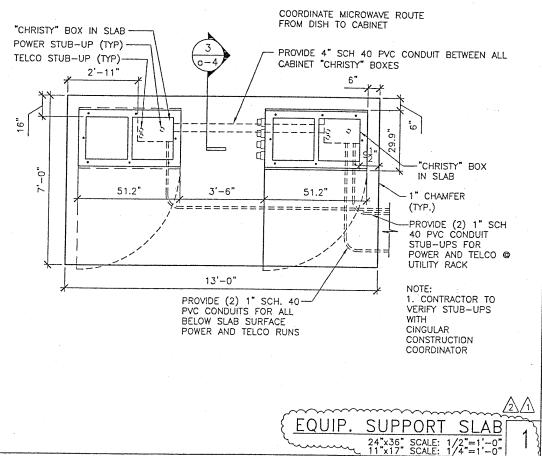

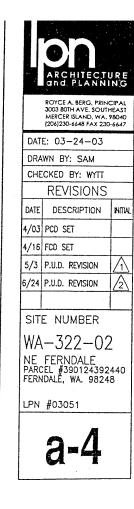

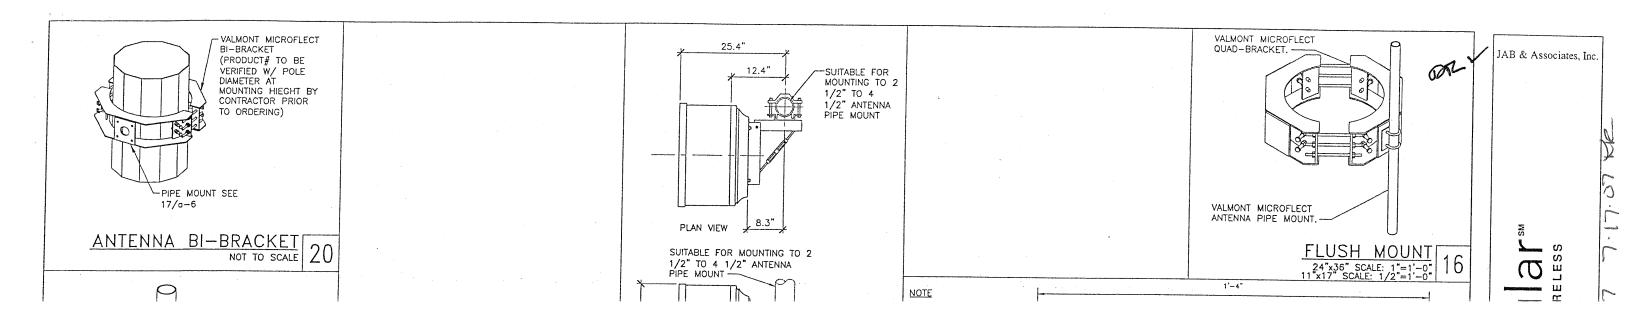

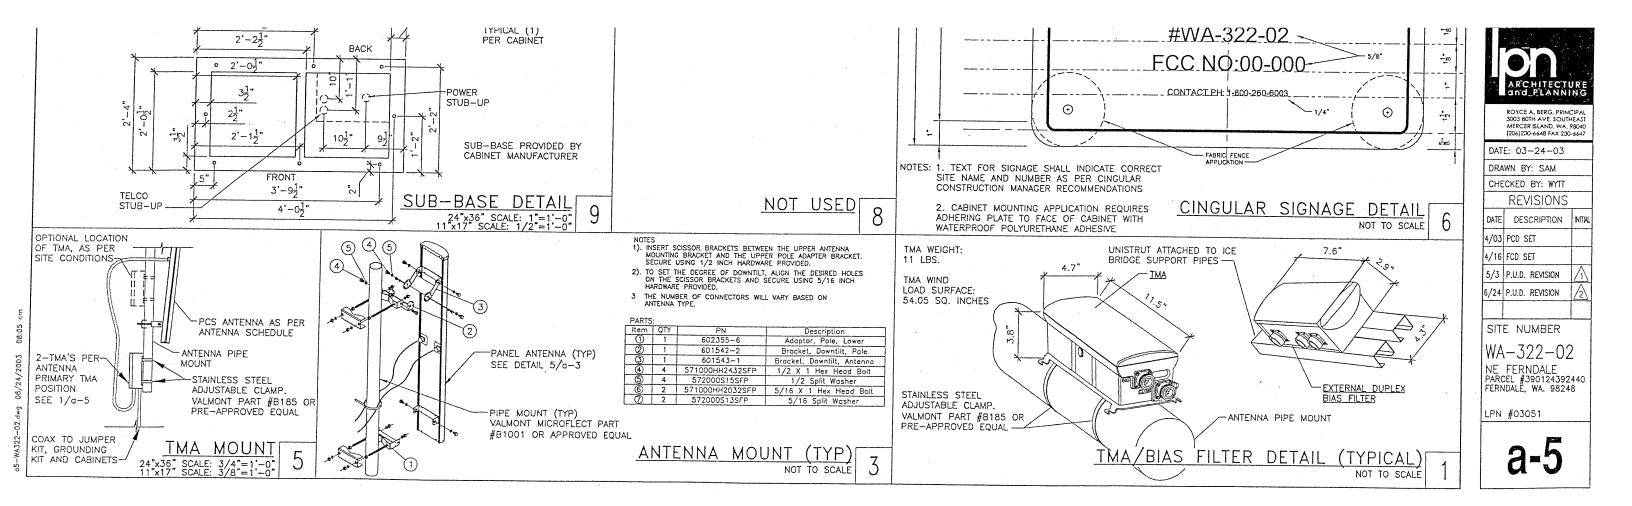

OIL

JAB & Associates, Inc.

Site Name	NE Ferndale	RF Engineer Hasan, Md. Shamiul	Paga Bate 4x8/2003			
Site Number	WA322 - 0Z	Phone Number 425-753-2515	Revision @9M-02			
Market	Seattle	Comments:	2011-22			
		1. One BTS cabinet for now and additional one for future				
		2. LDF 7 if Coax length is more than 125', otherwise LDF 5.				
		3. Implement variable electrical tilts as mentioned in the s				
Latitude (NAD 83) N	48 51 39.2"	Site Address	P			
Lucitude IIIAD 651 II	100100.2	[Outal World as a selection of the sele	Structure Owner			
	122 37' 22 09"					
Longitude (NAD 83) W	122 37' 22.09" 361	Water Tower / BELICER Properties	P.O. No. 1 OF Description			
Longitude (NAD 83) W Ground Elevation (AMSL) (ft)	122 37' 22.09" 361					

RF Antenna Gain (dBi)	17.8	17.8	17.8	EDB EDB EDB ECB ECB
RF Antenna (H+V Beamwidth) (deg)	65+7	65+7	65+7	In the metal metal metal metal
RF Downtilt Mechanical	0	0	0	
RF Antenna Dimensions (LXWXD) (in)	51X7X3	51X7X3	51X7X3	CDNY CONY CONY
RF Antenna Weight (lbs.)	11	11	11	16 SEARTH TO THE TANK TO THE PROPERTY OF
RF TMA (Number/Type/Location)	2 /2 Port/ top	2 /2 Port/ top	2 /2 Port/ top	
RF EDB (Number/Type/Location)	2 /3 port/bottom	2 /3 port/bottom	2 /3 port/boltom	
RF Number of TRUs	1	2	1	URI E URI DE URI DE URI
RF CDU Type	CDU-A	CDU-A	CDU-A	
RF Feeder Cable Type	LDF 5 (7/8")	LDF 5 (7/8")	LDF 5 (7/8")	
RF Number of Cables from BTS to Antenna	2	2	2	
CC Specific Cable Length	88 Feet	88 Feet	88 Feet	The second second of the second secon
RF Cabinet Type		Low Cap	- And the state of	
RF Number of Cabinets		1 Now + 1 Future		
RF Frequency Band	Downlink: 1930.2 - 1939.6	MHz Uplink: 1850.2 - 1859.	6 MHz	
Authorization Signatures				
Equipment Engineer;	RF Engineer: /	The state of the contract of the state of th	Real Estate and Construct	fion Manager:
				The state of the s
Sub Todd 6/10/13	x MHON	ew		6/12/13
month bushed belond through the best broken direct plants bushed plants private private private private bushed belond bushed bus	a beginn where these busines where the beginning where the same of			
se solely by Cingular Wireless employees and affiliate employee	ontained herein are preliminary and/o	rtentative and should not be relied up	pon unless approved by an appropria	ate Cingular Wireless governing body. Proprietary information for

ROYCE A. BERG, PRINCIPAL 3003 BOTH AVE. SOUTHEAST MERCER ISLAND, WA. 98040 (206)230-6648 FAX 230-6647 DATE: 03-24-03


DRAWN BY: SAM CHECKED BY: WYTT REVISIONS DATE DESCRIPTION INTIM 4/03 PCD SET 4/16 FCD SET 5/3 P.U.D. REVISION 6/24 P.U.D. REVISION

SITE NUMBER

WA-322-02 NE FERNDALE PARCEL #390124392440 FERNDALE, WA. 98248

LPN #03051

NGULAR CONSTRUCTION QUALITY CONTROL CHECKLIST	C = Complete NC = Not Complete		Ranfton Daghouse: Galvanized Grounded Weatherproof / Flashing			JAB & Associates, Inc.
	NA = Not Applicable		ANTENNA & HELIAX			OF 4
<u>MINISTRATION</u>	C / NC / NA	COMMENTS		C / NC / NA	COMMENTS	4
lined Construction Drawings			Antennas: Installation			
anties			Moke / Model #			
nd Resistivity Test Report (5 OHMS or less) crete Cylinder Tests Report			Quantity Azimuth	****		
ficate of Occupancy (or equivalency)			Same Horizontal Plane (per sector)			
ection Signoff Card Release of Lien (conditional)	***		Plumbness of Mount Downtilt Bracket (confirm ea. panel antenna has one)			
ling Permit (original)			Measure of Downtilt (if applicable)			
	Printed State of the Park of the State of th		Coox:			
WORK	C / NC / NA	COMMENTS	Size			
ss Road			Support @ 3'-0" Max. Bend Radius (20")	***		Σ
Gradina & drainage			Jumper Flows Directly into Antenna			
Grade ation Control			Hangers @ 3'-0" O.C. (no plastic devices)			S S
scaping			Weatherproofing (Connectors & Grounding Kits)	-		ii o
ation System			Color Coding (3 Places Minimum) Drip Loop			
ing: . Stile & Podlock			Grounding (3 Ground Kits) Tight Connection (At Bus Bars)			CC
			right connection (At bus burs)	-		

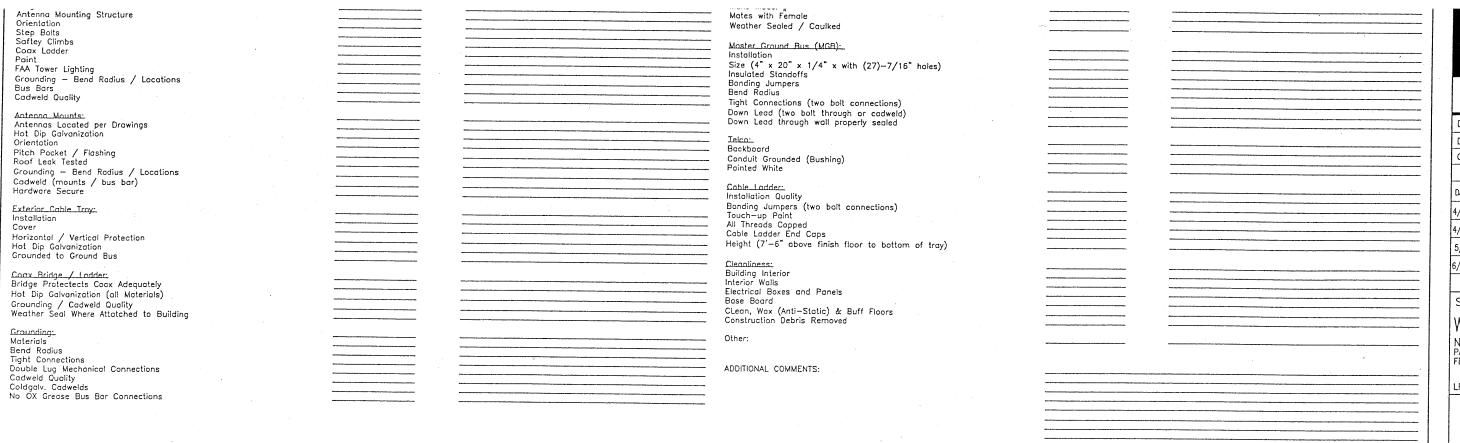

Mates with Female Weather Sealed / Caulked



ROYCE A. BERG, PRINCIPAL 3003 BOTH AVE. SOUTHEAST MERCER ISLAND, WA. 98040 (206)230-6648 FAX 230-6647

DATE: 03-24-03 DRAWN BY: SAM CHECKED BY: WYTT

REVISIONS DATE DESCRIPTION INITIAL

4/03 PCD SET 4/16 FCD SET

5/3 P.U.D. REVISION 6/24 P.U.D. REVISION

SITE NUMBER

WA-322-02 NE FERNDALE PARCEL #390124392440 FERNDALE, WA. 98248

LPN #03051

d-1