BONKILMER

MORTH BEUILAH SUBDIVISIO

ROADWAY AND UTILITY IMPROVEMENTS FERNDALE, WASHINGTON

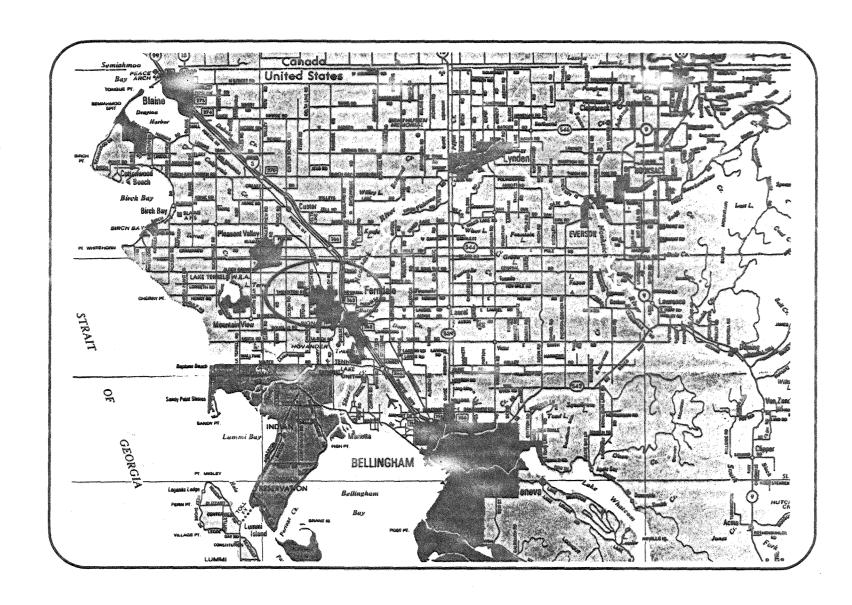



TABLE OF SHEETS

COVER SHEET

SHEET 2 COMPOSITE SHEET

VIEW COURT ROAD AND DRAINAGE

VIEW COURT WATER AND SEWER

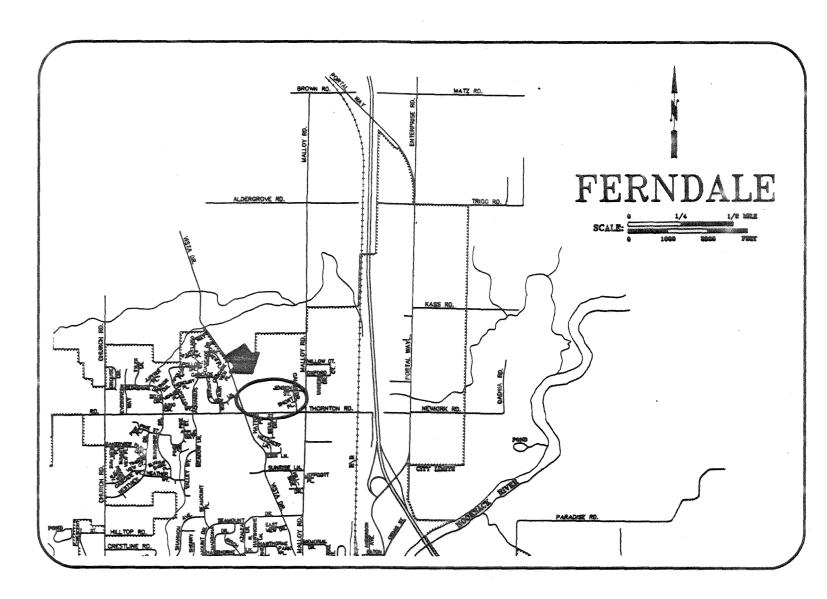

VICINITY MAP (NOT TO SCALE)

OCATION MAP (SCALE: 1" = 200')

SPECIFICATIONS

All work and materials shall conform to the 1991 Edition of the Standard Specification for Road, Bridge and Municipal Construction as prepared by the Washington State Department of Transportation (DOT) and the Washington State Chapter of American Public Works Association (APWA), the City of Ferndale's Ordinance No. 676 and according to the instructions and recommendations of the manufacturer of the materials involved. In case of a conflict between the above standards and recommendations, the more stringent one will apply.

References hereinafter to Division and Sections shall refer to the Standard Specification mentioned above.

DIVISION 2: EARTHWORK

- 1. Clearing, Grubbing and Roadside Cleanup Clearing, grubbing and roadside cleanup shall conform to Section 2-01 using disposal Method No.
- 2. Roadway Excavation and Embankment Roadway excavation and embankment shall conform to Section 2-03, using compaction method B. Compaction layers for granular materials shall not exceed 12 inches in depth. Layers for non-granular materials shall not exceed 4 inches in depth.
- Subgrade Preparation Subgrade preparation shall conform to Section 2-06.

- 4. Ditch and Channel Excavation Ditch and channel excavation shall conform to Section 2-10.
- 5. Trimming and Cleanup Trimming and Cleanup shall conform to Section 2-11.

DIVISION 3: (NOT USED)

DIVISION 4: BASES

1. Asphalt Treated Base Asphalt treated base shall conform to Section 4-06.

DIVISION 5: SURFACE TREATMENT AND PAVEMENT

1. Asphalt Concrete Pavement Asphalt concrete pavement shall conform to Section 5-04. Material shall be Class B.

DIVISION 6: STRUCTURES

1. Concrete Structures Concrete weirs and miscellaneous structures shall conform to Section 6-02. Concrete shall be Class DIVISION 7: DRAINAGE STRUCTURES, STORM SEWER. SANITARY SEWER. WATER MAINS AND CONDUITS

1. Storm Sewers

Storm sewers shall conform to Section 7-04. Pipe material shall be Concrete conforming to Section 9.05.7(1) or PVC conforming to Section 9-05.12. Exfiltration or pressure testing may be required by the Engineer.

- Manholes, Inlets and Catch Basins Manholes, inlets and catch basin shall conform to Section 7-05.
- 3. Water System

All water pipe materials and installation shall conform to the applicable portions of Section 7-09 to 7-11, AWWA C600 and C651. In addition, the following provisions apply:

- a. Pipelines shall be Ductile Iron Class 50, and shall meet the requirements of Section 9-30.1(1), with Cement Lining according to AWWA Standard H3-71 C151-71, and Cement Lining C104-71.
- b. All fittings shall have a minimum pressure rating of 350 psi and shall conform to Section 9-03.2.
- c. Excavation shall be in accordance with Section 7-10.3(7) and shall include all materials of whatever nature encountered, including solid rock excavation

d. The Contractor shall make all arrangements and pay all applicable fees to the City of Ferndale prior to connecting to the existing water system.

- e. Pavement shall be cut ahead of the excavating machine to prevent excessive tearing up of the surfacing and to eliminate ragged edges. The roadway or driveway surfaces shall be removed only in locations as indicated by the plans and specifications or by the approval of the Engineer.
- f. All water line and appurtenances shall be pressure tested at 200 psi in accordance with Section 7-11.3(11) and City of Ferndale requirements. All purification acceptance testing shall be according to City of Ferndale requirements.
- g. All backfill shall be bankrun gravel backfill and shall meet the requirements of Section 9-30.7(3).
- h. All work must be inspected and approved by a representative of the City of Ferndale Engineering Division, and Twenty-four (24) hours notice must be given prior to starting work or to Schedule inspection.

AS A RESULT.

4. Valves for Water Mains Valves for water mains shall conform to Section 7-12. Gate valves shall have screw type cast iron valve boxes. Valves shall be resilient seat gate valves meeting C509-87 and/or C504-877, C550-81 and all City of Ferndale Requirements and suitable for installation with the type and class or pipe used. All valves shall have nonrising stems and shall open counter clockwise and shall be equipped with a 2" square operating nut. Valves will be flange or M.J.

Fire hydrants shall conform to AWWA C502 and City of Ferndale Standard. Installation shall be in accordance with Section 7-14. A blue reflector will be placed in the street across from each hydrant installed.

- Service Connections Service connections shall conform to Section 7-15.
- 7. Sanitary Sewers Sanitary sewers shall conform to Section 7-17. Pipe material shall be PVC conforming to Section 9-

Pipe material shall be PVC conforming to Section

DIVISION 8: MISCELLANEOUS CONSTRUCTION

Side Sewer

1. Erosion Control Temporary erosion and sedimentation control facilities (TESCF) shall conform to Section 8-01 and City of Ferndale Standards. These facilities shall be maintained during construction and removed only after all exposed surfaces subject to erosion have been stabilized by landscaping elements or hydroseeding.

Sanitary side sewer shall conform to Section 7-18.

- 2. Curbs and Gutters Curbs and gutters shall conform to Section 8-04.
- 3. Cement Concrete Sidewalks Cement concrete sidewalks shall conform to Section 8-14. Provide curb ramps where shown.
- Riprap shall conform to Section 8-15.
- 5. Permanent Signing Permanent signing shall conform to Section 8-21.
- 6. Pavement Markings Pavement marking shall conform to Section 8-22.

NOTE: THIS RECORD DRAWING HAS BEEN PREPARED ON THE BASIS OF INFORMATION COMPILED AND FURNISHED BY OTHERS. THE ENGINEER WILL NOT BE RESPONSIBLE FOR ANY ERRORS OR OMISSIONS WHICH HAVE BEEN INCORPORATED INTO THIS DOCUMENT RECORD DRAWING

				Same
1	RECORD DRAWINGS	DRH	DEC 92	
100		The state of the s		
				Angeles and a
			and and an angles of the state of the state	
NO.	REVISIONS	BY	DATE	

CONSULTING ENGINEERS & SURVEYORS

805 DUPONT STREET #7 BELLINGHAM, WA 98225 (206) 733-6100

FAX: (206) 647-9061





	DES
ich i	CHE


SIGNED BY: RAWN BY: ECKED BY:

RON KILMER - RECORD DRAWINGS NORTH BEULAH SUBDIVISION COVER SHEET AND NOTES

B: \92021A01.DWC SHEET DATE DEC 92 SCALE AS SHOWN OF JOB NUMBER 92021

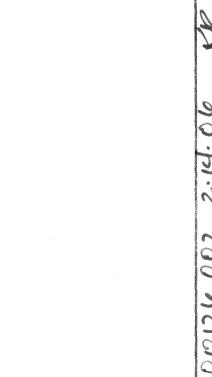

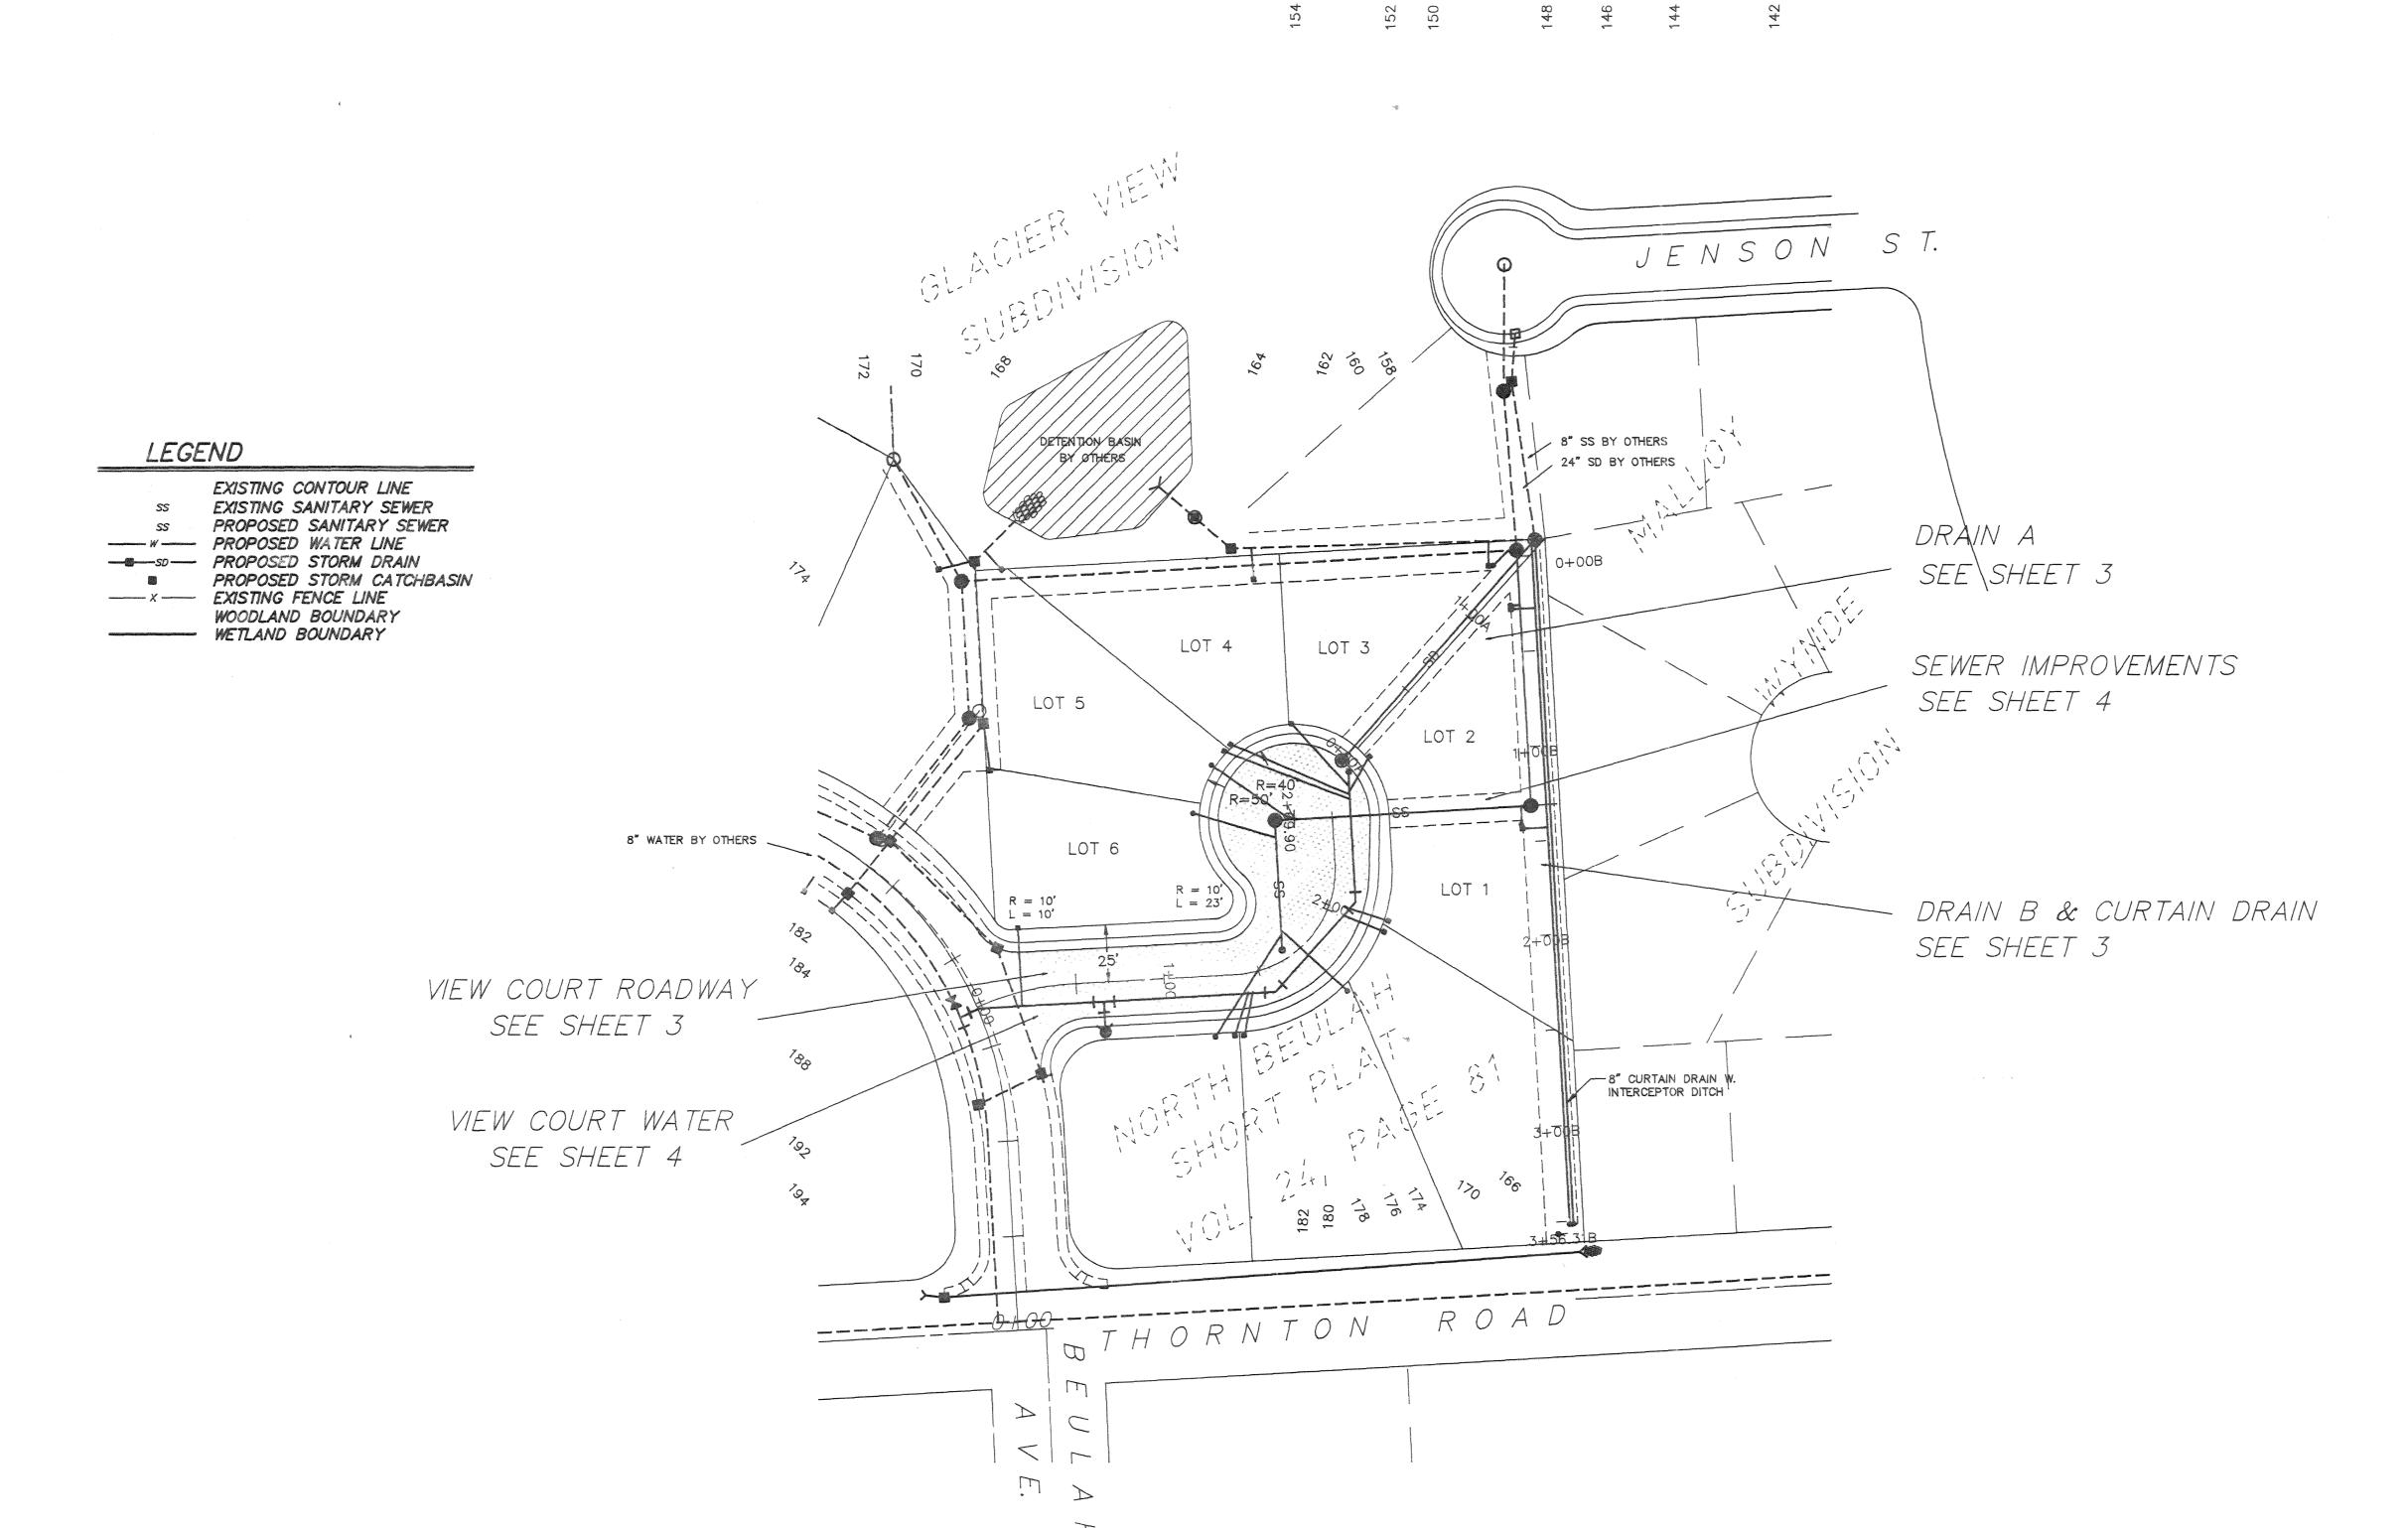

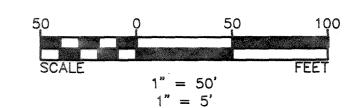

CAUTION !!! UG and OH Utilities are known to exist in the area. Not all are shown.

LEGEND


-35 - EXISTING CONTOUR LINE ----SD-- PROPOSED STORM DRAIN EXISTING WATER PROPOSED WATER LINE EXISTING SANITARY SEWER
PROPOSED SANITARY SEWER

NOTE: THIS RECORD DRAWING HAS BEEN PREPARED ON THE BASIS OF INFORMATION COMPILED AND FURNISHED BY OTHERS. THE ENGINEER WILL NOT BE RESPONSIBLE FOR ANY ERRORS OR OMISSIONS WHICH HAVE BEEN INCORPORATED INTO THIS DOCUMENT AS A RESULT.

RECORD DRAWING

		termony and a second se	Communication of the Communica	-
1	RECORD DRAWINGS	DRH	DEC 92	
			Normal Control of the	
			,	
NO.	REVISIONS	BY	DATE	


805 DUPONT STREET #7 BELLINGHAM, WA 98225 (206) 733-6100

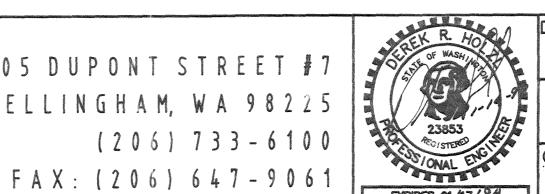



	DESIGNED BY:	
	DH	
E	DRAWN BY:	
	DH	
,	CHECKED BY:	
	17	


RON KILMER - RECORD DRAWIN NORTH BEULAH SUBDIVISION COMPOSITE SHEET

	<i>B:</i> \92	021A02.DWG
	DATE	SHEET
VGS	DEC 92	2
	SCALE	-
	AS SHOWN	OF
	JOB NUMBER	5
	92021	

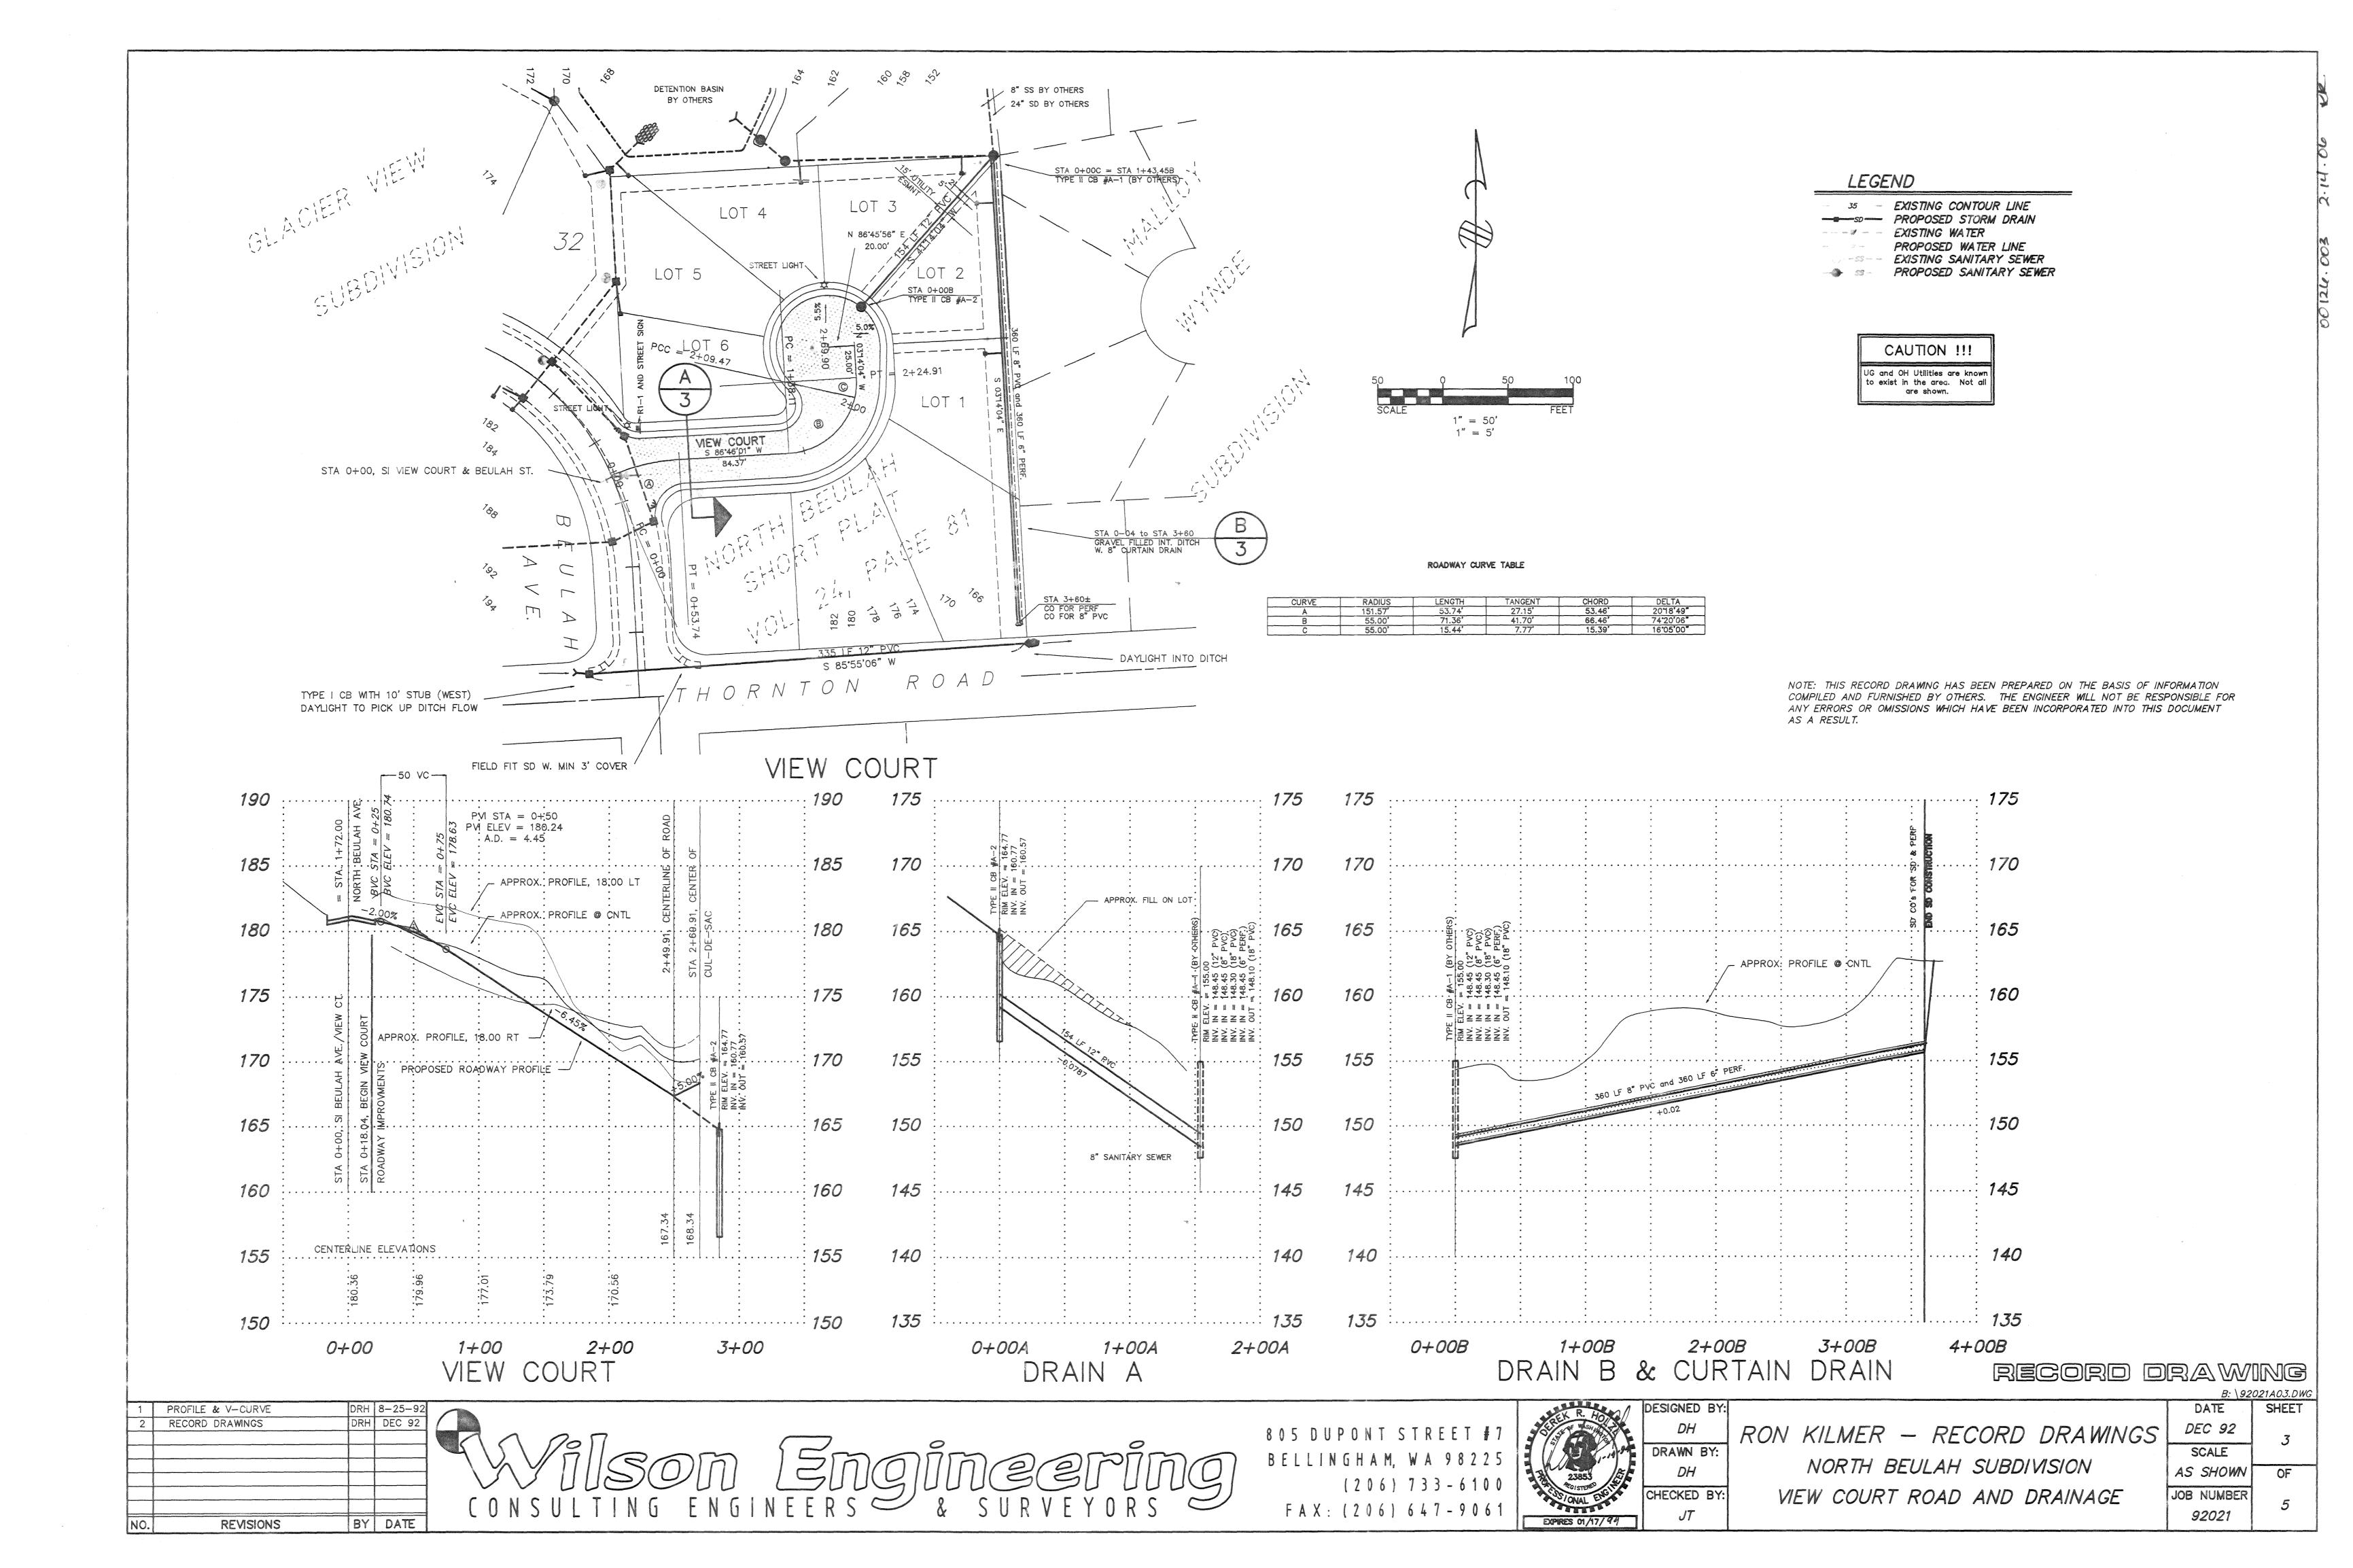

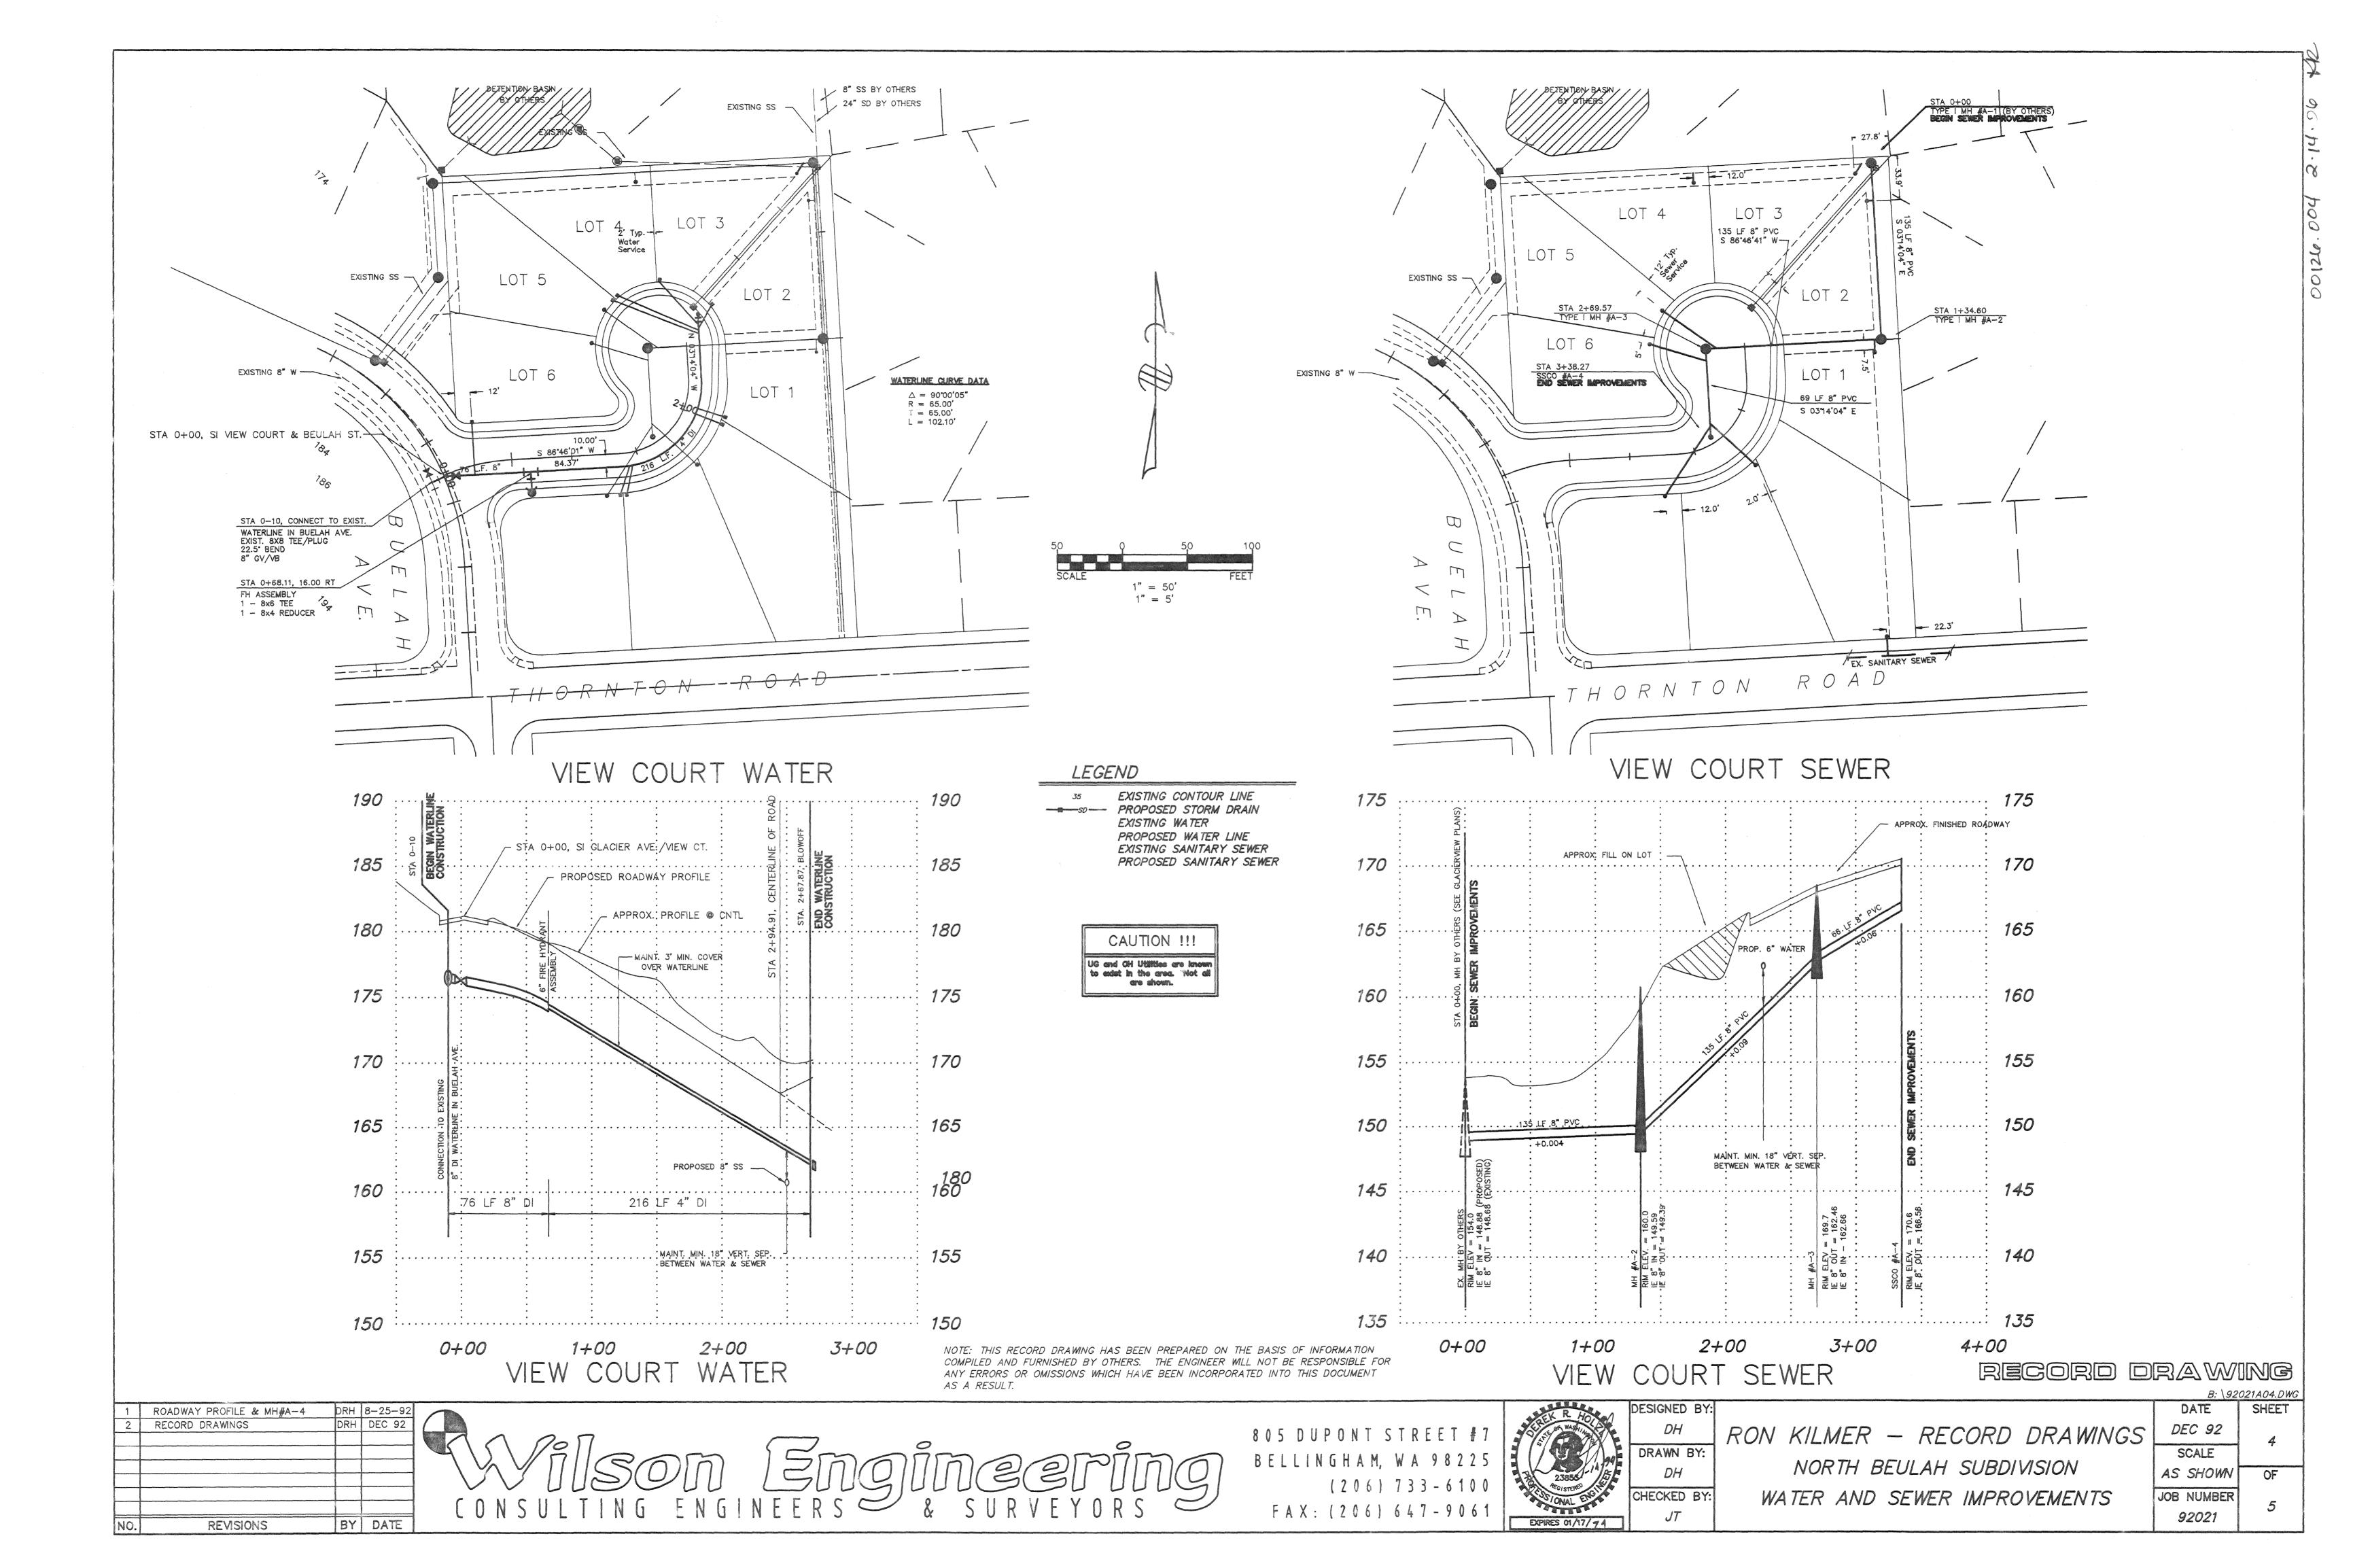


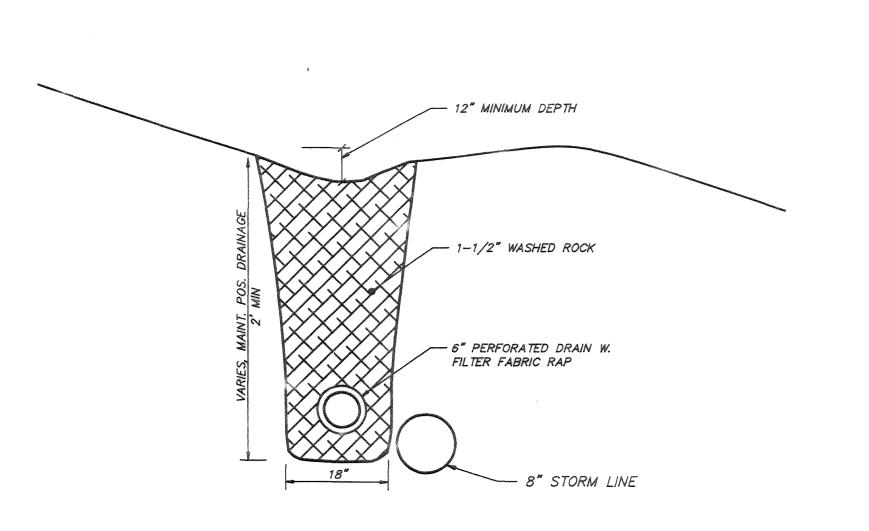

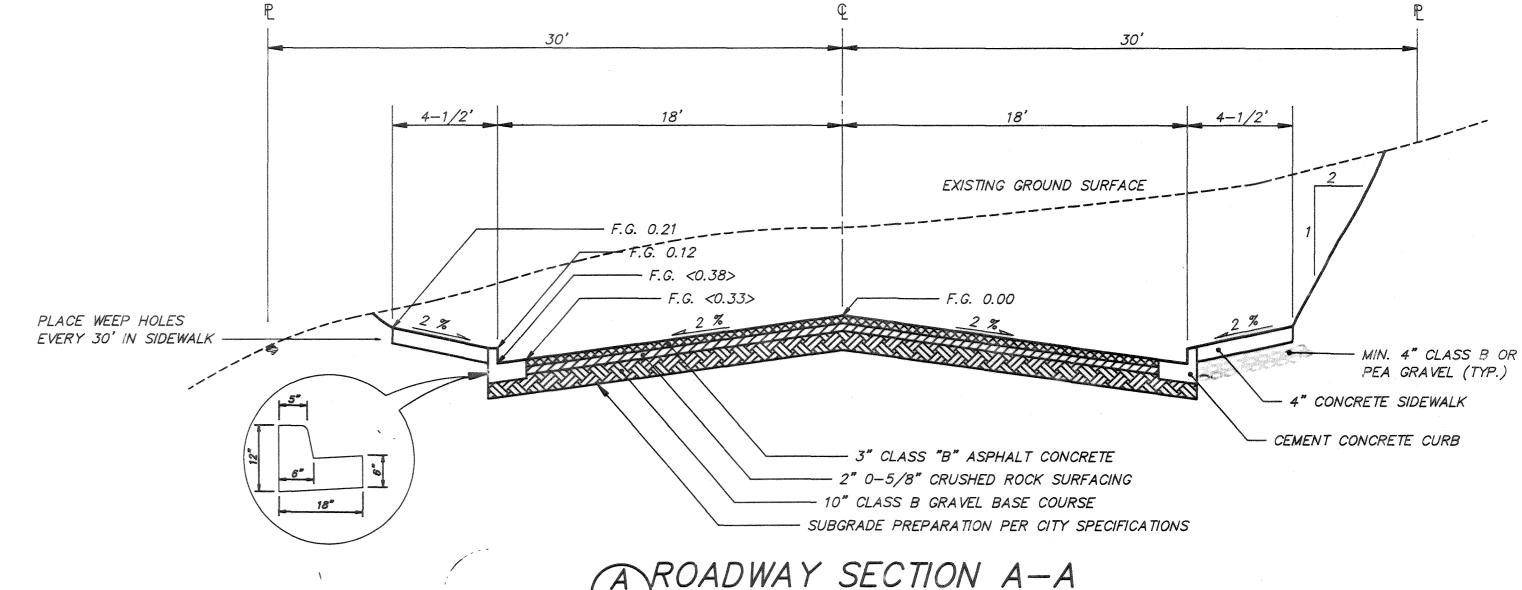


BYNTERCEPTOR DRAIN

(NOT TO SCALE)

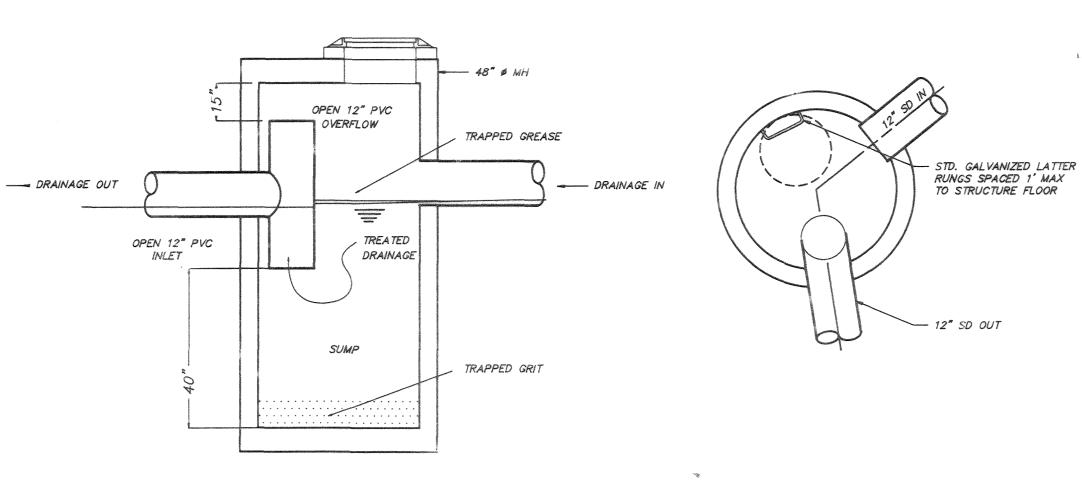

A ROADWAY SECTION A-A

(NOT TO SCALE)

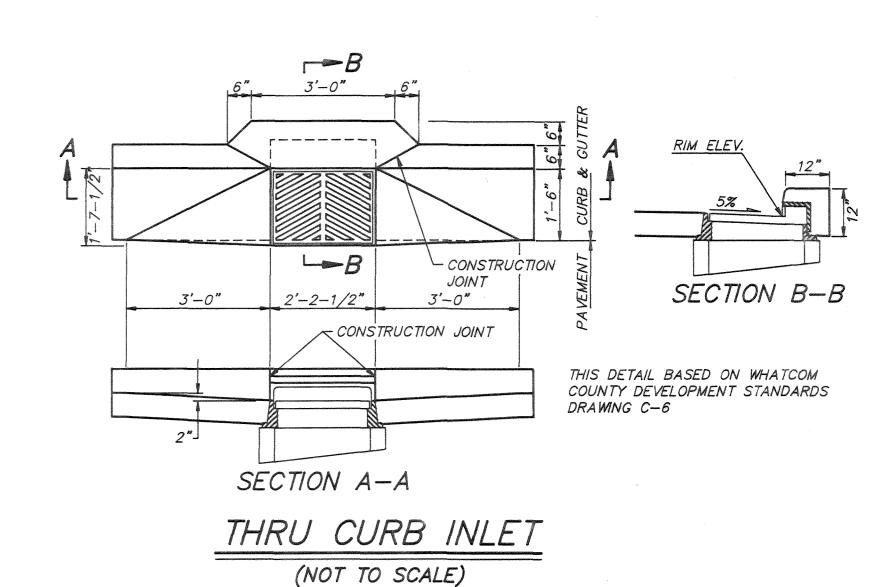


POLLUTION CONTROL MANHOLE

(NOT TO SCALE)

- EXIST. OR PROPOSED SURFACE - DETECTABLE MARKING TAPE - NATIVE BACKFILL (OUTSIDE OF ROAD PRISM) 1111111 BANKRUN GRAVEL, CLASS B (IN ROAD PRIŚM) 1111111 COMPACTED TO 95% AS PER 1111111 ASTM D-1557 ////// 11111. 11111 6" WATER, SEWER OR STORM LINE BEDDING MATERIAL PER DOT APWA SECTION 9-03.15 FOR RIGID PIPE AND 9-03.16 FOR FLEXIBLE PIPE

(NOT TO SCALE)

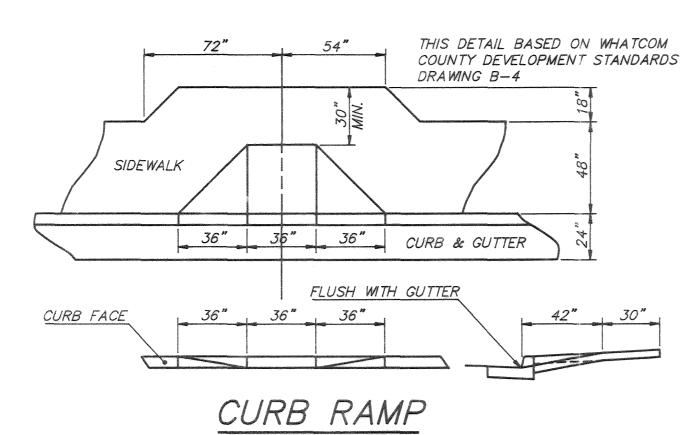

(NOT TO SCALE)

NOTE: THIS RECORD DRAWING HAS BEEN PREPARED ON THE BASIS OF INFORMATION COMPILED AND FURNISHED BY OTHERS. THE ENGINEER WILL NOT BE RESPONSIBLE FOR ANY ERRORS OR OMISSIONS WHICH HAVE BEEN INCORPORATED INTO THIS DOCUMENT AS A RESULT.


RECORD DRAWING

1 RECORD DRAWINGS DRH DEC 92

ONSULTING ENGINEERS & S

ON SULTING ENGINEERS & S

805 DUPONT STREET #7
BELLINGHAM, WA 98225
(206) 733-6100
FAX: (206) 647-9061

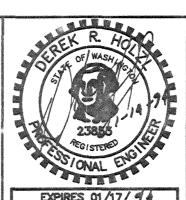

	DESIGNED BY:
	DH
是	DRAWN BY:
	DH
	CHECKED BY:

RON KILMER — RECORD DRAWINGS

NORTH BEULAH SUBDIVISION

DETAILS

DATE SHEET

DEC 92

SCALE

AS SHOWN OF

JOB NUMBER

92021