
# **MOUNTAIN VIEW APARTMENTS - AS-BUILTS**

2373 MAIN STREET

SITUATE IN A PORTION OF THE NE 1/4, NW 1/4 OF SECTION 30, T. 39 N., R. 2 E., W.M. CITY OF FERNDALE, WHATCOM COUNTY, WASHINGTON

# **LEGEND**

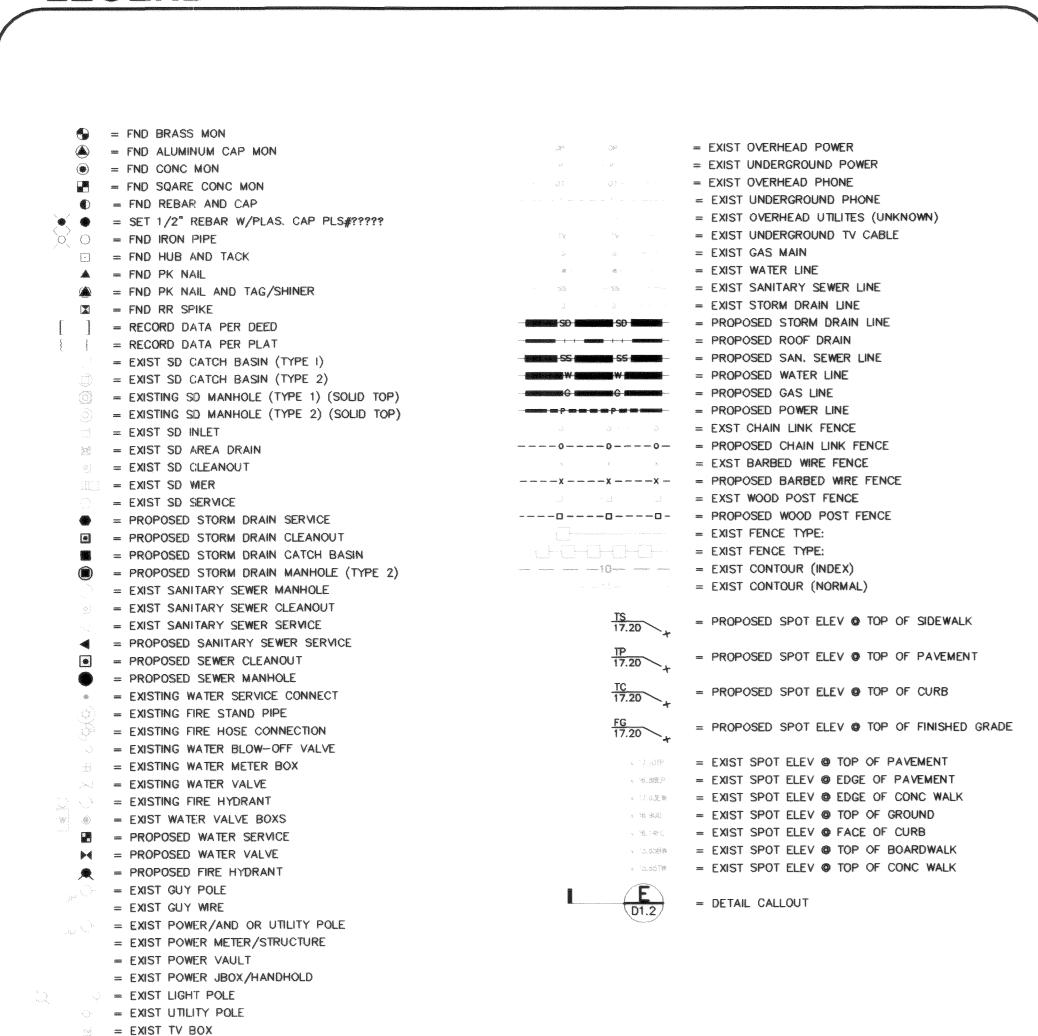


# **SHEET INDEX**

- C1) COVER SHEET
- **C2) EXISTING CONDITIONS**
- C3) TEMPORARY EROSION CONTROL & SEDIMENTATION PLAN
- C4) PHASED SITE PLAN
- C5) PAVING, GRADING & DRAINAGE PLAN
- C6) WATER & SEWER PLAN
- C7) SANITARY SEWER PLAN & PROFILE
- 28) MT. VIEW ROAD PLAN & PROFILE
- **C9) EROSION CONTROL DETAILS**
- C10) ROAD DETAILS
- C11) POND CROSS SECTION
- C12) STORMWATER DETAILS
- C13) GENERAL NOTES

# **ABBREVIATIONS**

A STATE OF THE PARTY OF THE PAR				
	WL	= WATER LINE	IE	= INVERT ELEVATION
	PVC	= POLY VINYL CHLORIDE	INV	= INVERT
	D.I.	= DUCTILE IRON	SSCO	= SANITARY SEWER CLEANOUT
	LF	= LINEAR FEET	SSMH	= SANITARY SEWER MANHOLE
	FH/F.HYD.	= FIRE HYDRANT	EG	= EXISTING GRADE
	MJ	= MECHANICAL JOINT	STA	= STATION
	FL	= FLANGE/FLOWLINE	AF NO.	= AUDITORS FILE NUMBER
	во	= BLOWOFF ASSEMBLY	ALIGN	= ALIGNMENT
	CPLG	= COUPLING	RW/ROW	= RIGHT OF WAY
	ADAPT	= ADAPTER	TR	= TRACT EASEMENT LINE
	L/LT	= LEFT	MB	= MAIL BOX
	R/RT	= RIGHT	UTIL	= UTILITY
	TYP	= TYPICAL	REQ	= REQUIRED
	EX, EXST	= EXISTING	LOC	= LOCATION
	EXIST	= EXISTING	APPROX	= APPROXIMATE
	CL/C.L.	= CENTERLINE	CONC	= CONCRETE
	FF/FFE	= FINISH FLOOR	PLNTR	= PLANTER
	EP, EOP	= EDGE OF PAVING	WLK	= WALKWAY
	EL, ELEV	= ELEVATION	FLD	= FIELD
	FGE/FG	= FINISHED GRADE ELEVATION	PC	= POINT OF CURVE
	RAD	= RADIUS	PT	= POINT OF TANGENCY
	R	= RADIUS OR RIGHT	TYP./TYP	= TYPICAL
	L	= LENGTH OR LEFT	SDCB	= STORM DRAIN CATCH BASIN
	HDPE	= HIGH DENSITY POLYETHYLENE	SDMH	= STORM DRAIN MANHOLE
	SCH.	= SCHEDULE	FM	= SANITARY FORCE MAIN
	SMMWW	= STORMWATER MANAGEMENT MANUAL	MH	= MANHOLE
		FOR WESTERN WASHINGTON.	SS	= SANITARY SEWER
	SF	= SILT FENCE	SD	= STORM DRAIN
	WSDOE	= WASHINGTON STATE	Δ	= DELTA ANGLE
		DEPARTMENT OF ECOLOGY	POC	= POINT ON CURVE
	C.O.F./COF	= CITY OF FERNDALE	PRC	= POINT OF REVERSE CURVE
	SW	= SIDEWALK	PCC	= POINT OF COMPOUND CURVE
	CR	= CURVE RETURN		
-				

# **VICINITY MAP**

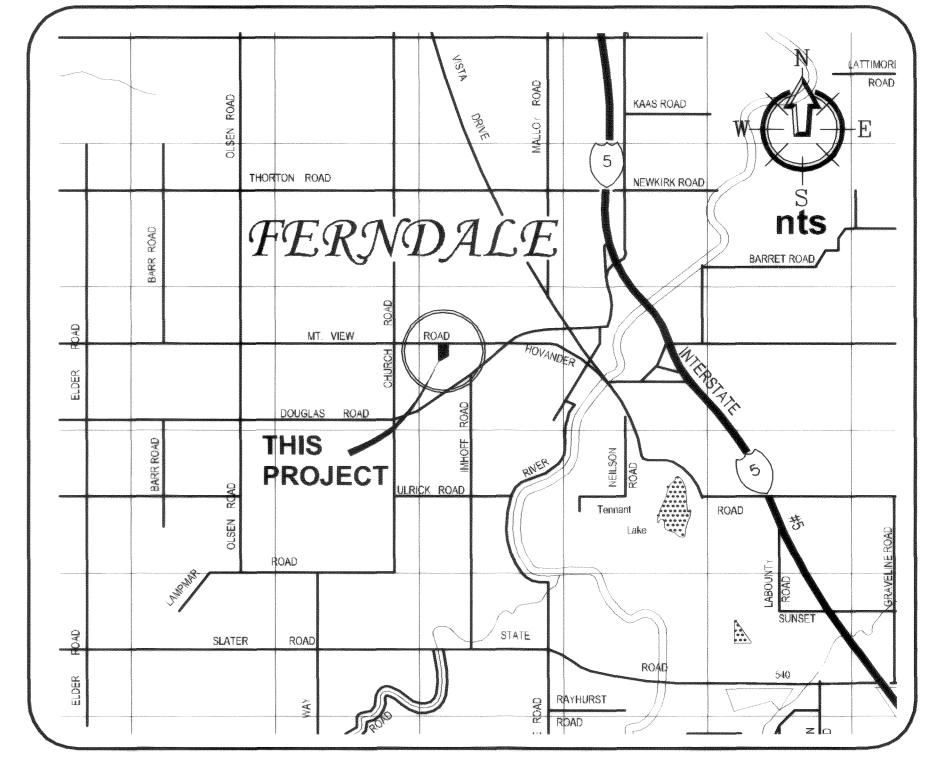

# **PROJECT CONTACTS**

### <u>OWNER</u>

MOUNTAIN VIEW RDM, LLC CONTACT PERSON: DANNY FINKELSTIEN 910 HARRIS STREET, UNIT 502 BELLINGHAM, WA, 98225 PHONE: (360) 354-0333 FAX: (360) 354-7022

# CIVIL ENGINEER

(360) 650-1401 (FAX)

FREELAND & ASSOCIATES, INC. TONY FREELAND, PE 1408 NORTH GARDEN STREET BELLINGHAM, WA 98225 (360) 650-1408

## SURVEYOR

CHRISTIE AND CHRISTIE LAND SURVEYING, INC. BRIAN CHRISTIE, PLS 22 GRAND AVE, SUITE D BELLINGHAM, WA 98225 (360) 671-8855 (360) 671-8823 (FAX)

### **ARCHITECT**

JWR PROFESSIONAL BUILDING DESIGN, INC. SEAN HEGSTAD 104 FRONT STREET, SUITE 201 LYNDEN, WA 98264 (360) 354-0333

### Asbuilt Drawing Certification

I HEREBY CERTIFY THAT THE IMPROVEMENTS IN MOUNTAIN VIEW APARTMENTS HAVE BEEN INSPECTED BY FREELAND & ASSOCIATES, INC. AND CONSTRUCTED IN CONFORMANCE WITH THE PLANS APPROVED BY THE PUBLIC WORKS DIRECTOR FOR SAID DEVELOPMENT AND THE GENERAL SPECIFICATIONS ADOPTED BY THE CITY OF FERNDALE PUBLIC WORKS.

Une a f Date: 1-15-08



CALL BEFORE YOU DIG
FOR BURIED UTILITY LOCATIONS
1-800-424-5555



1408 North Garden Street f:
Bellingham, WA 98225 f:

t: 360.650.1408 f: 360.650.1401 DA TE: 01-07-08 JOB #: 05097 SHEET:

CITY OF FERNDALE PROJECT #DE 2006-04

= EXIST TELEPHONE PEDESTAI = EXIST TELEPHONE MANHOLE

= EXIST MAIL BOX


= EXIST SIGN

= PROPOSED SIGN

े 🎨 📁 EXIST LANDSCAPING

= EXIST GAS METER

0.355.001 1.24.08

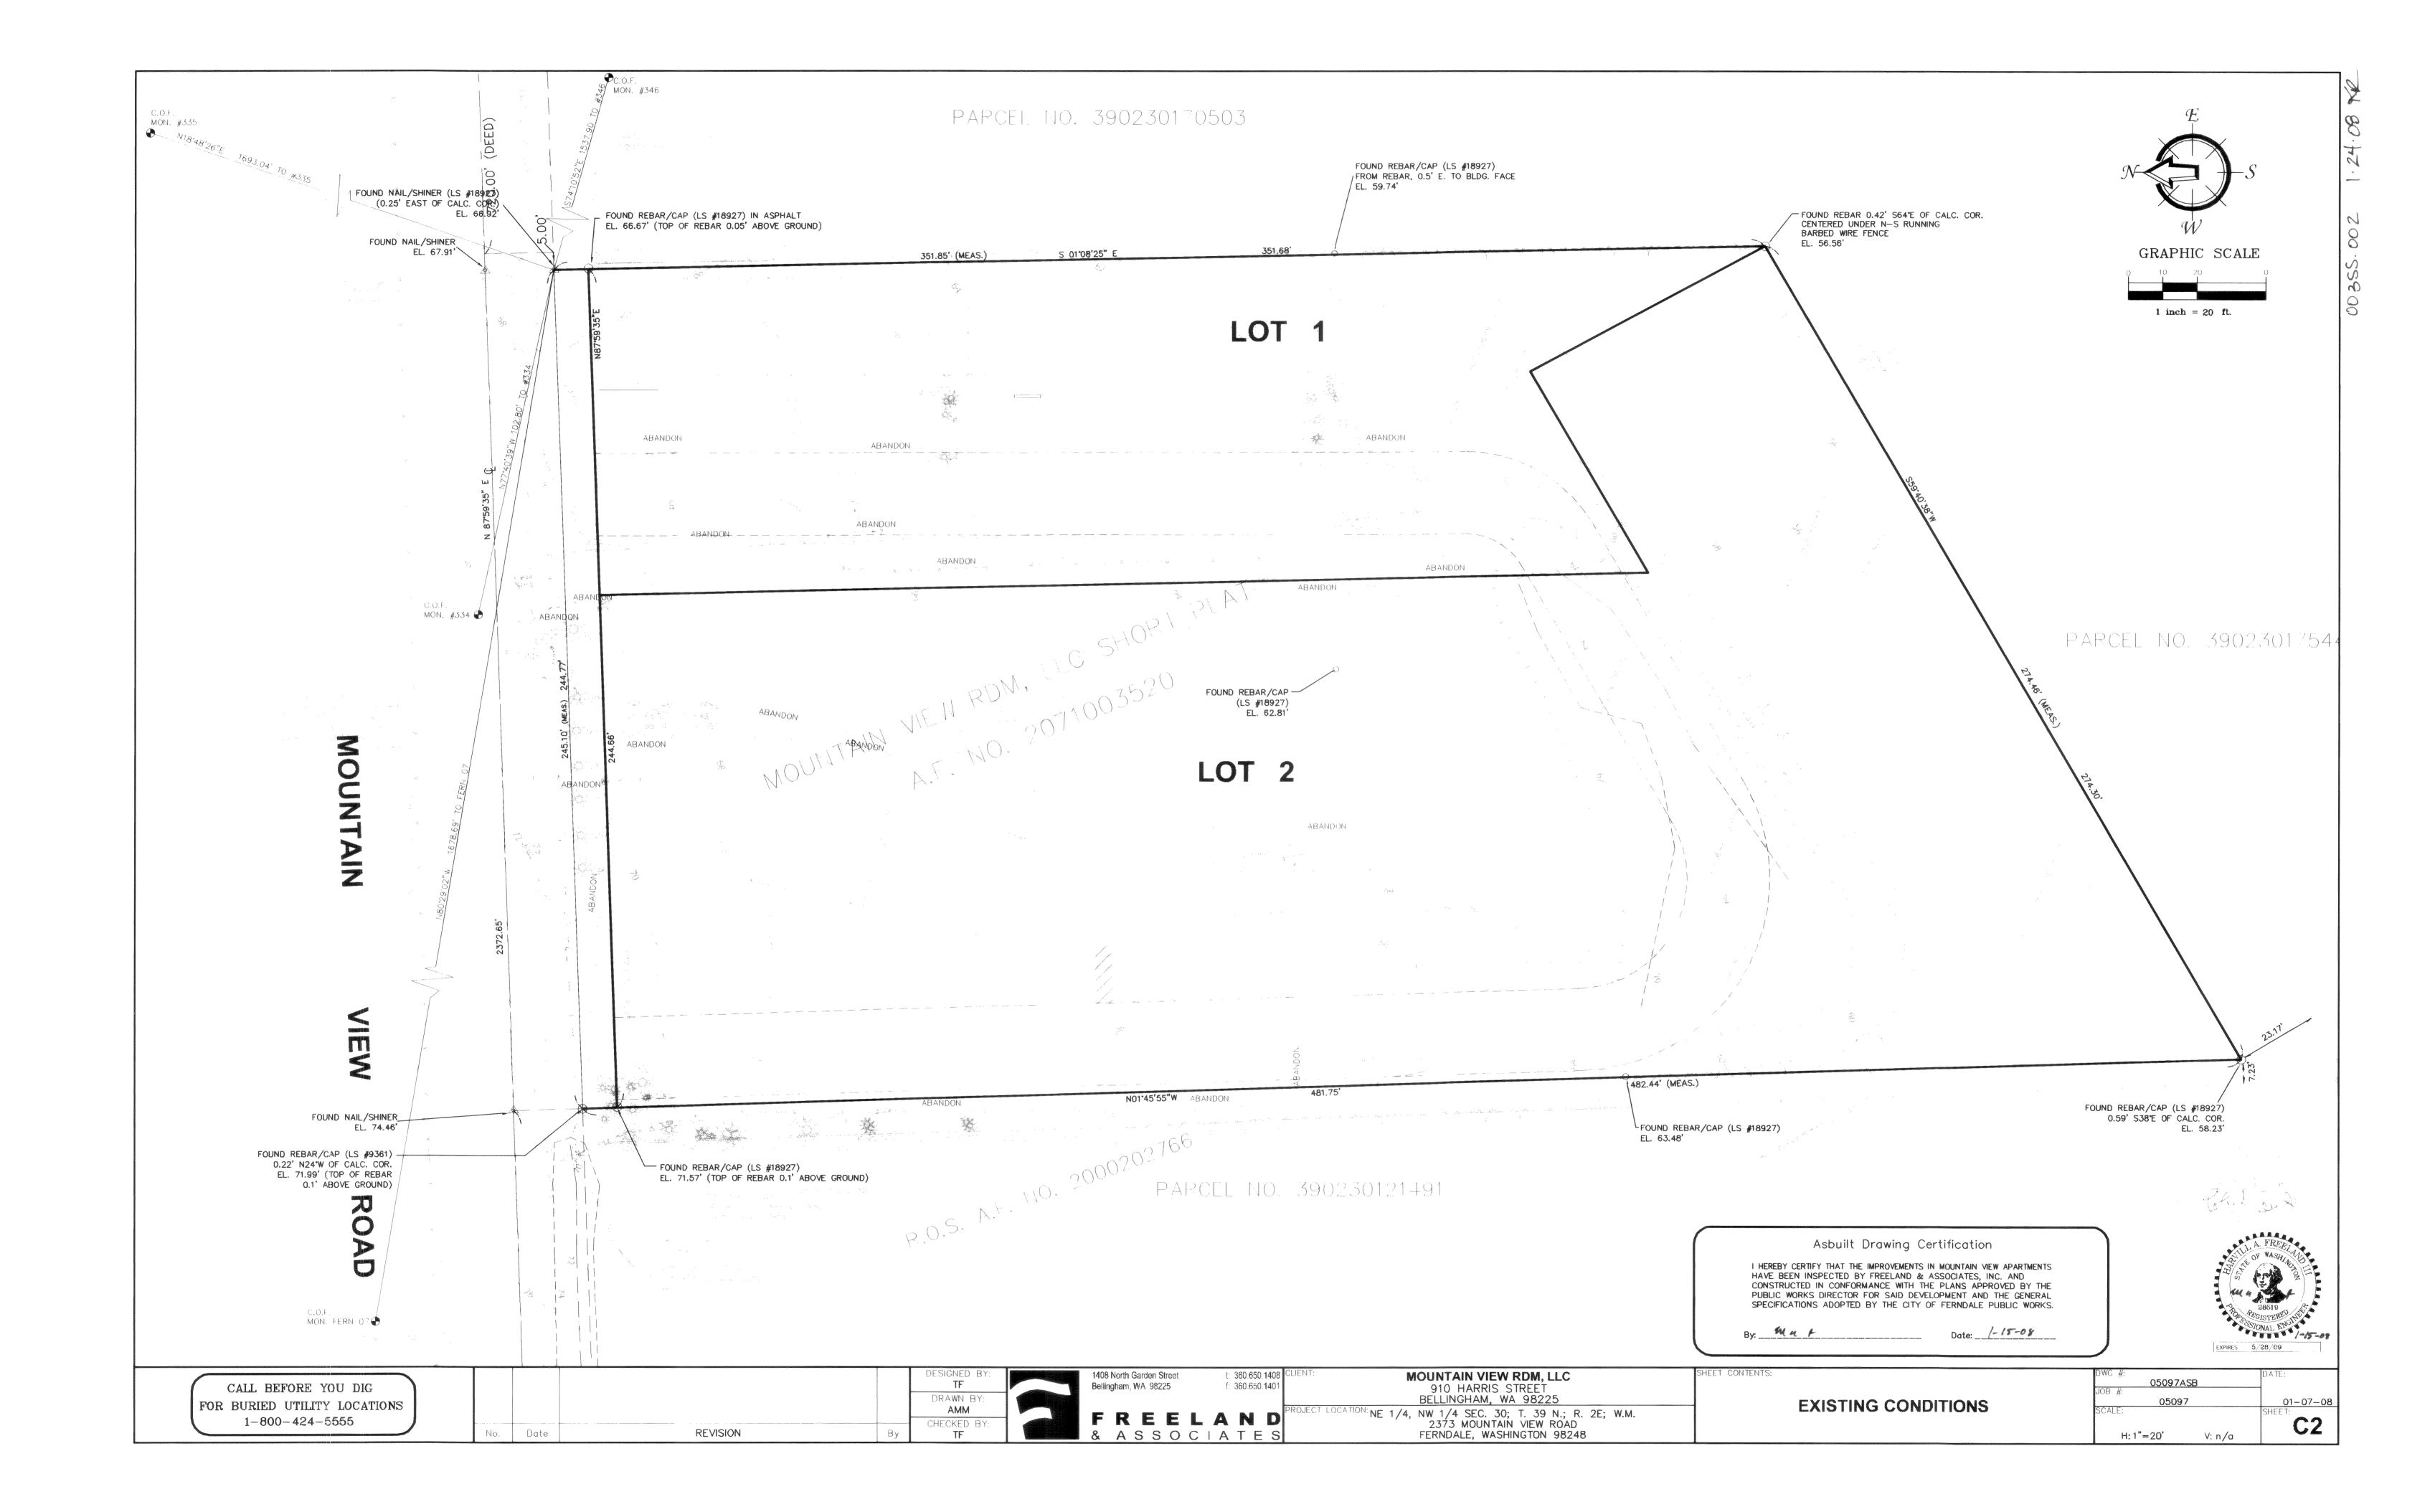


FERNDALE, WASHINGTON 98248


H: 1" = 20'


V: n/a


No. Date

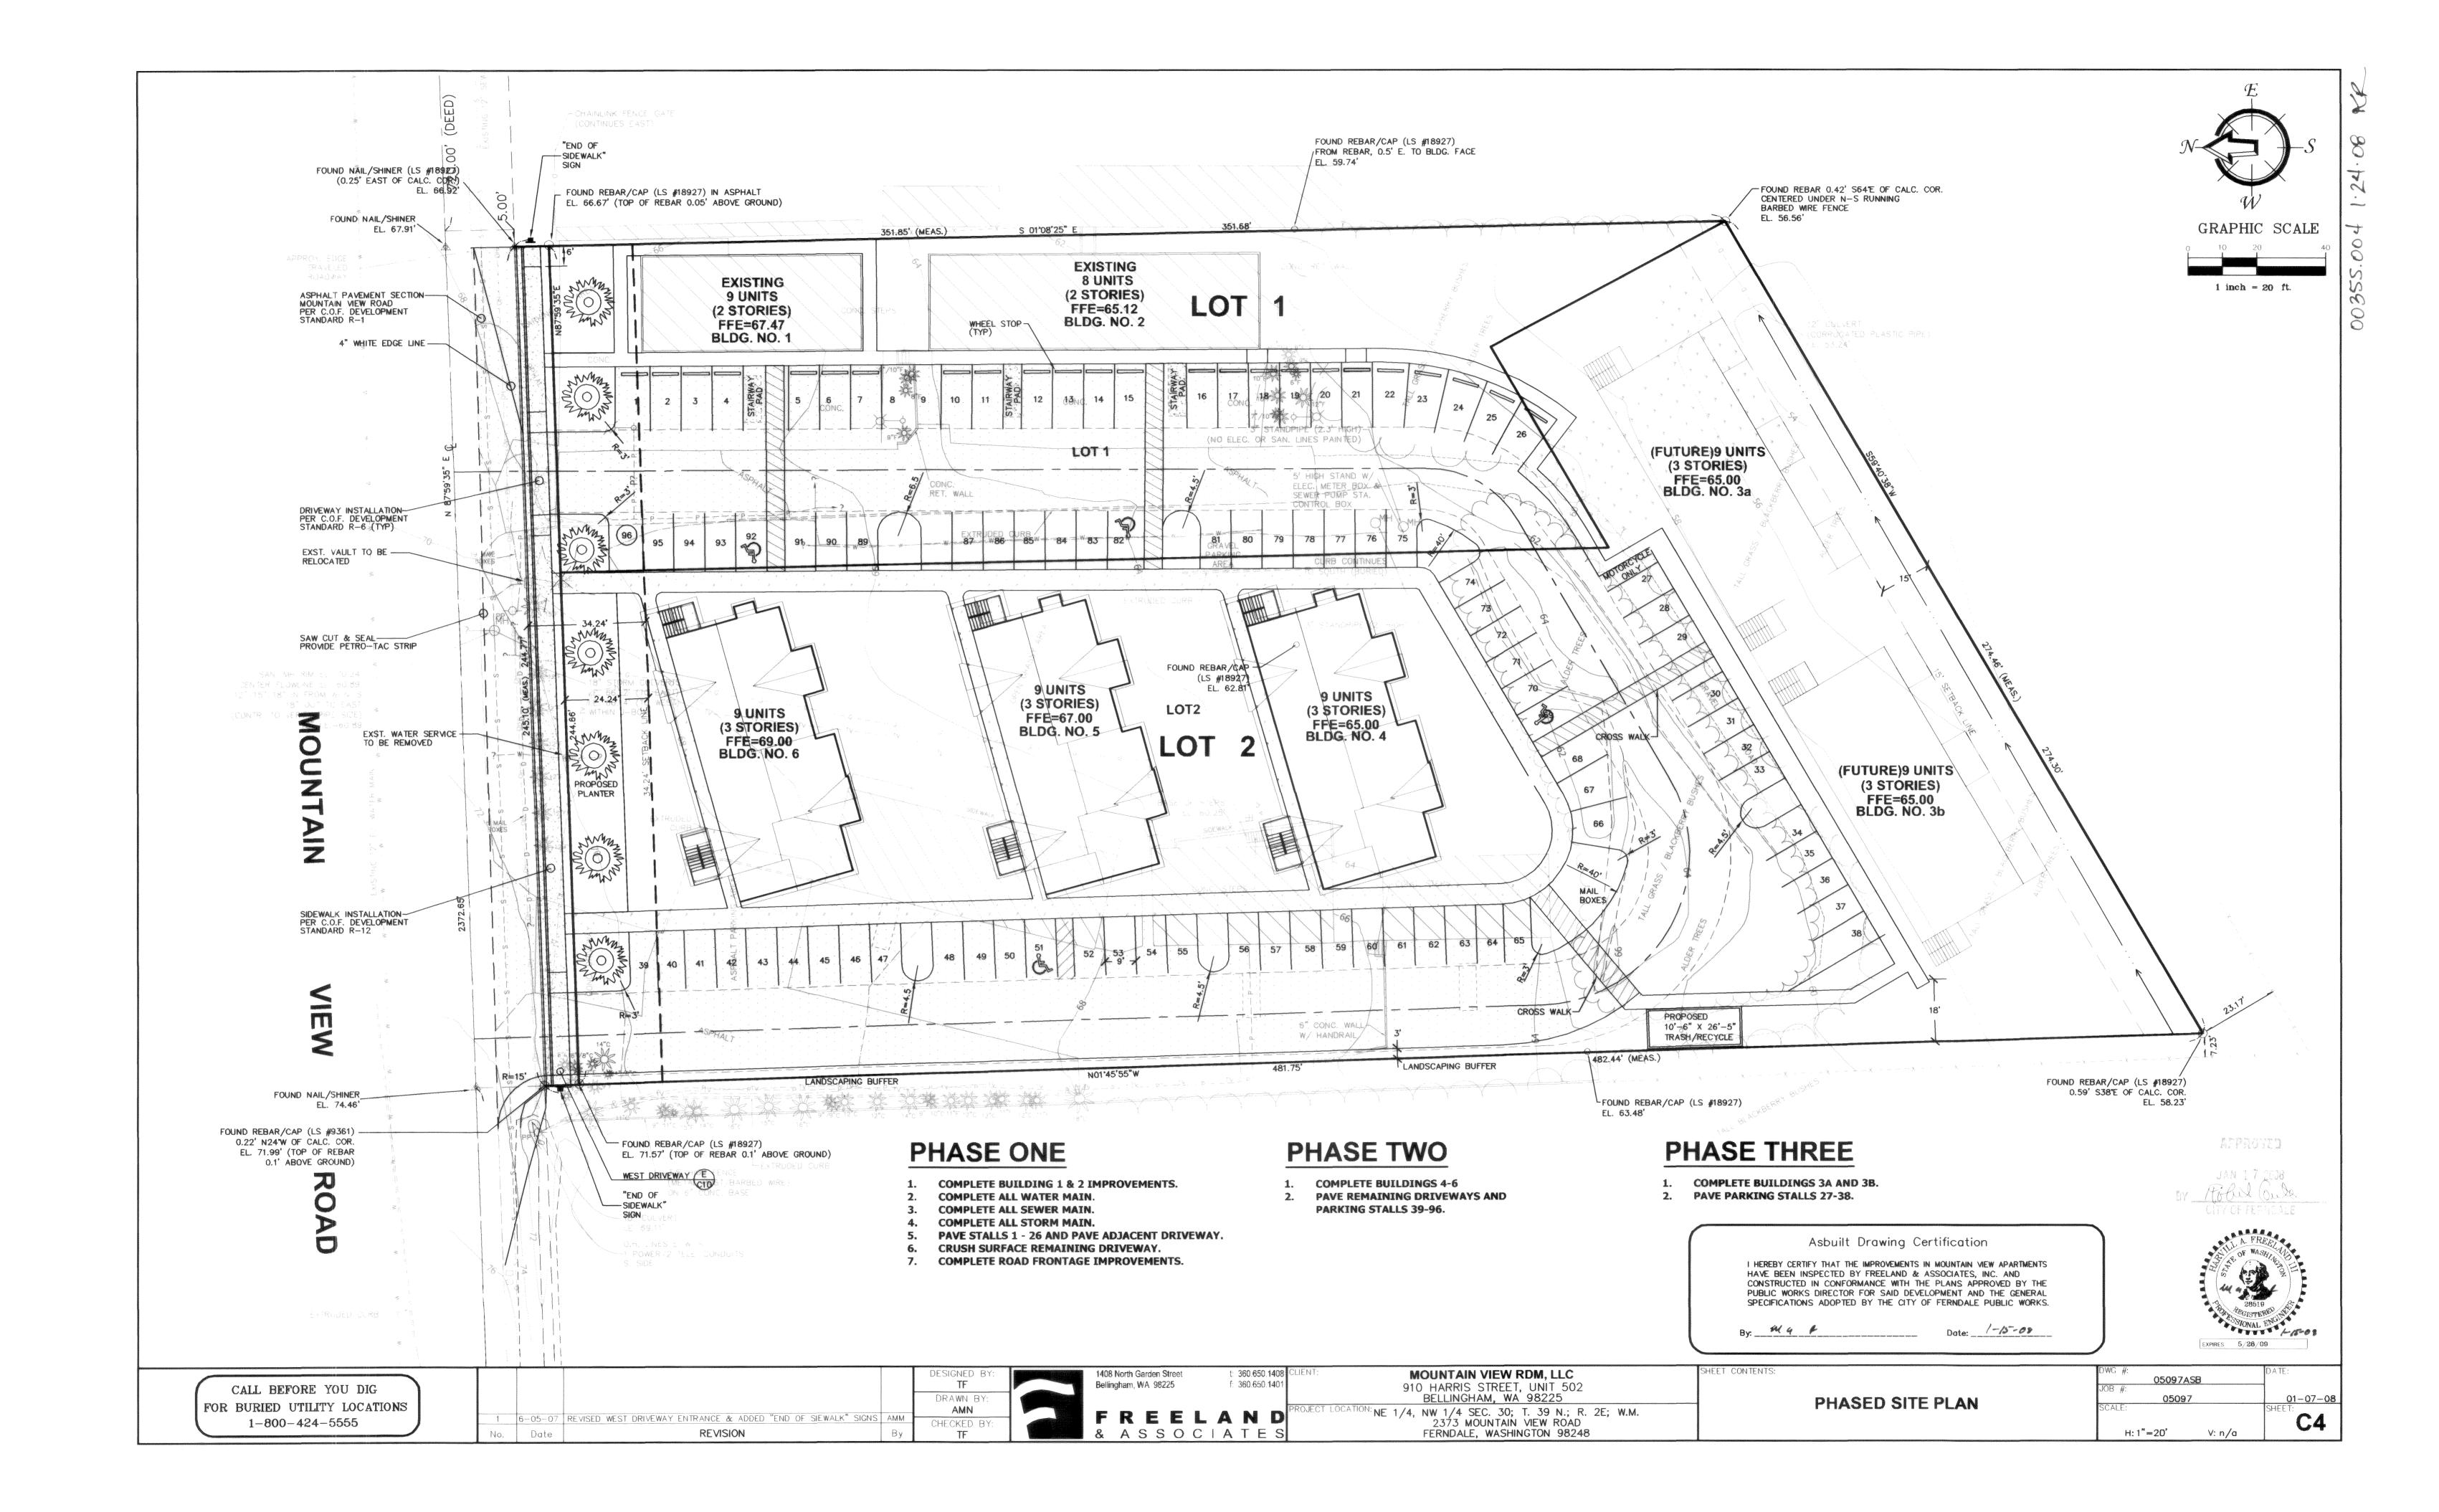





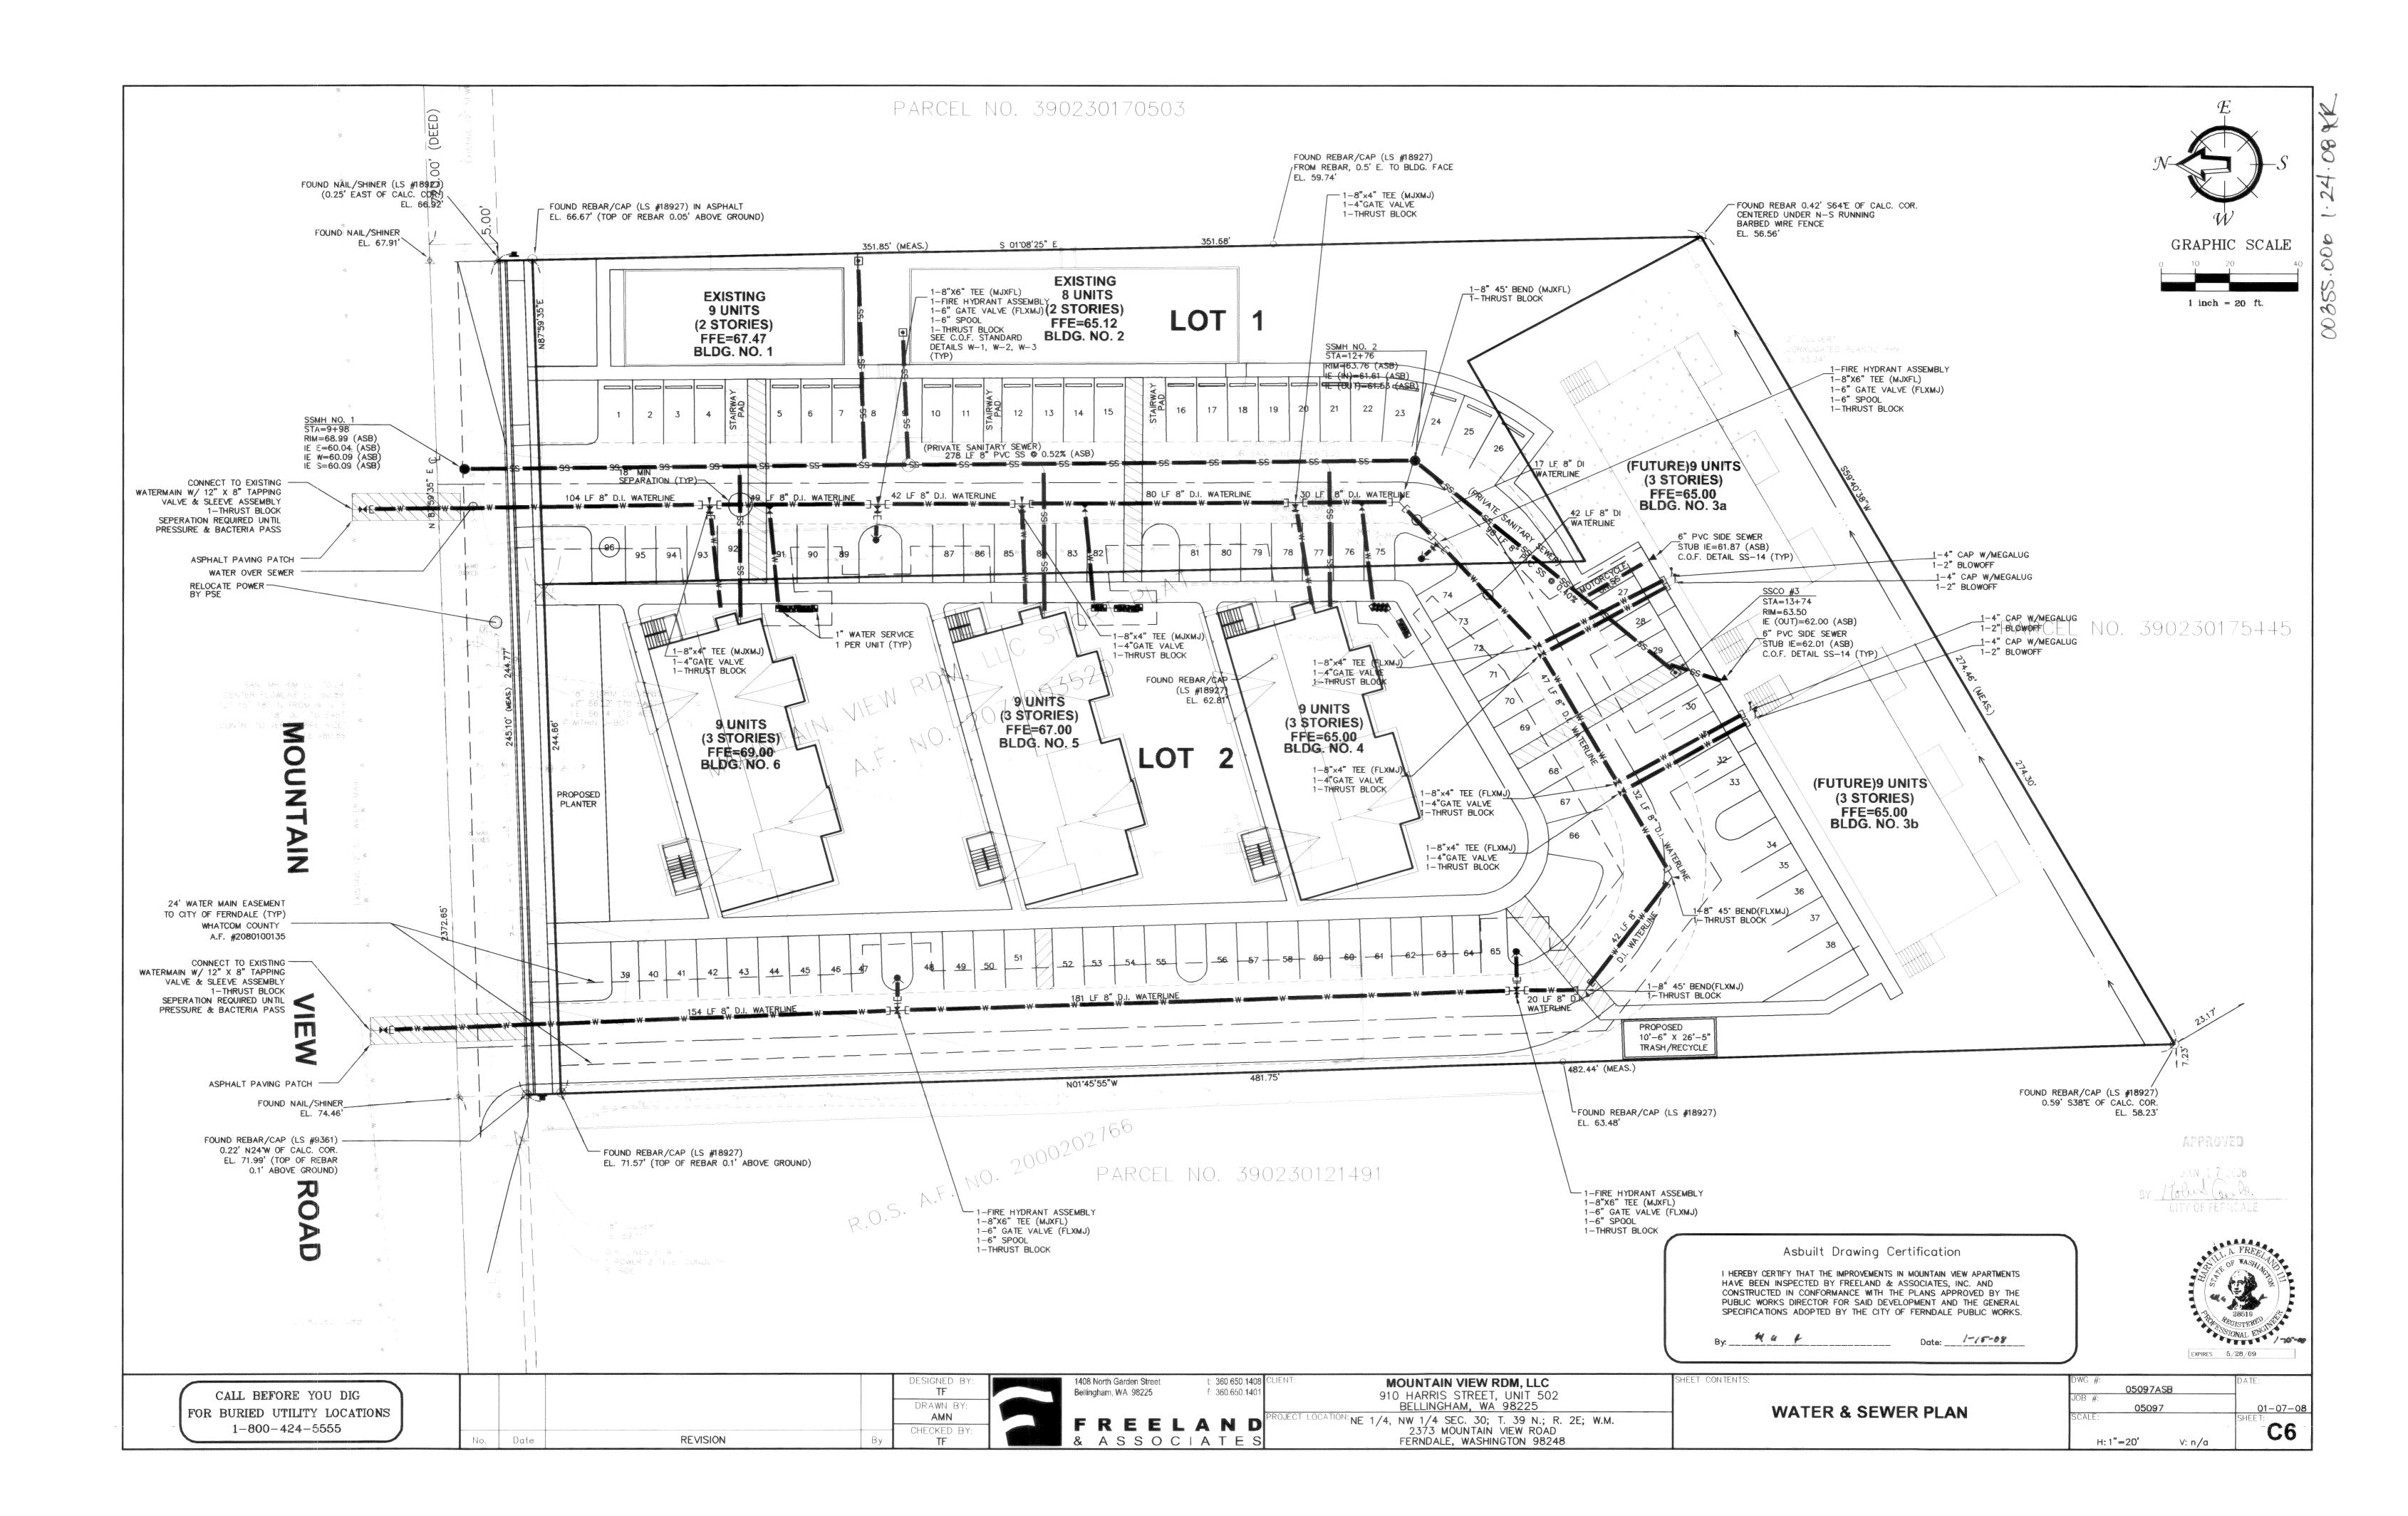


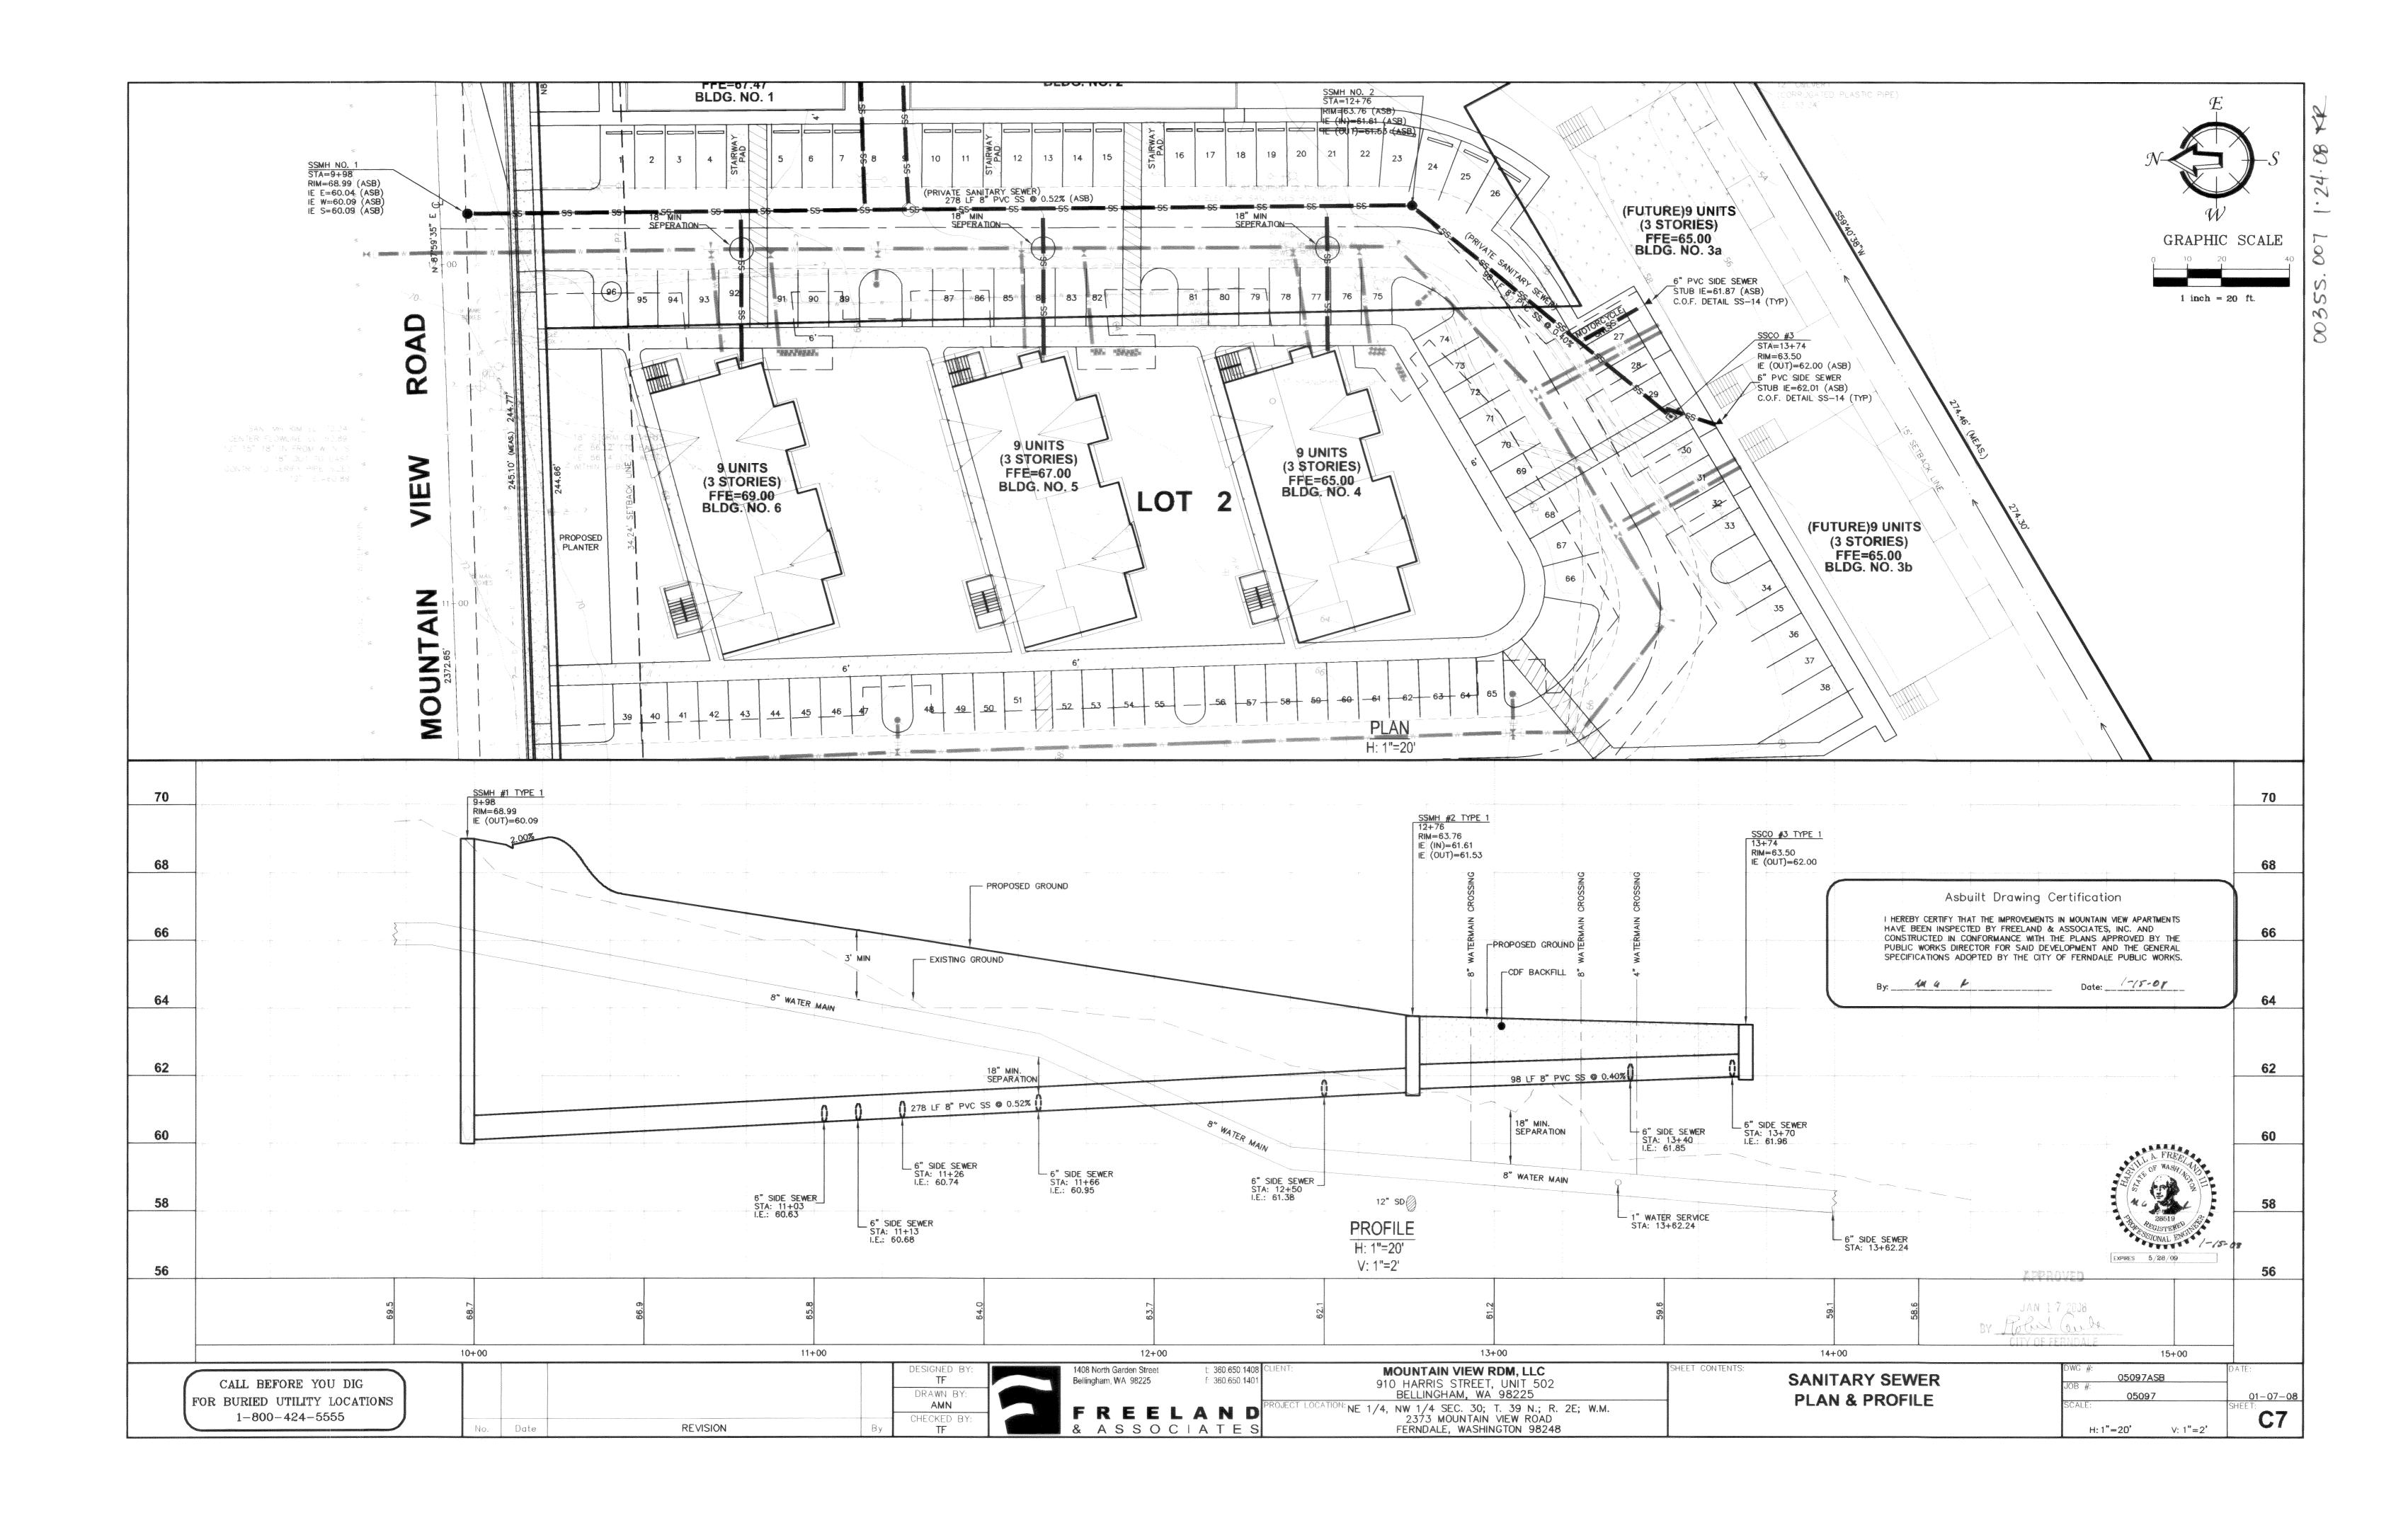

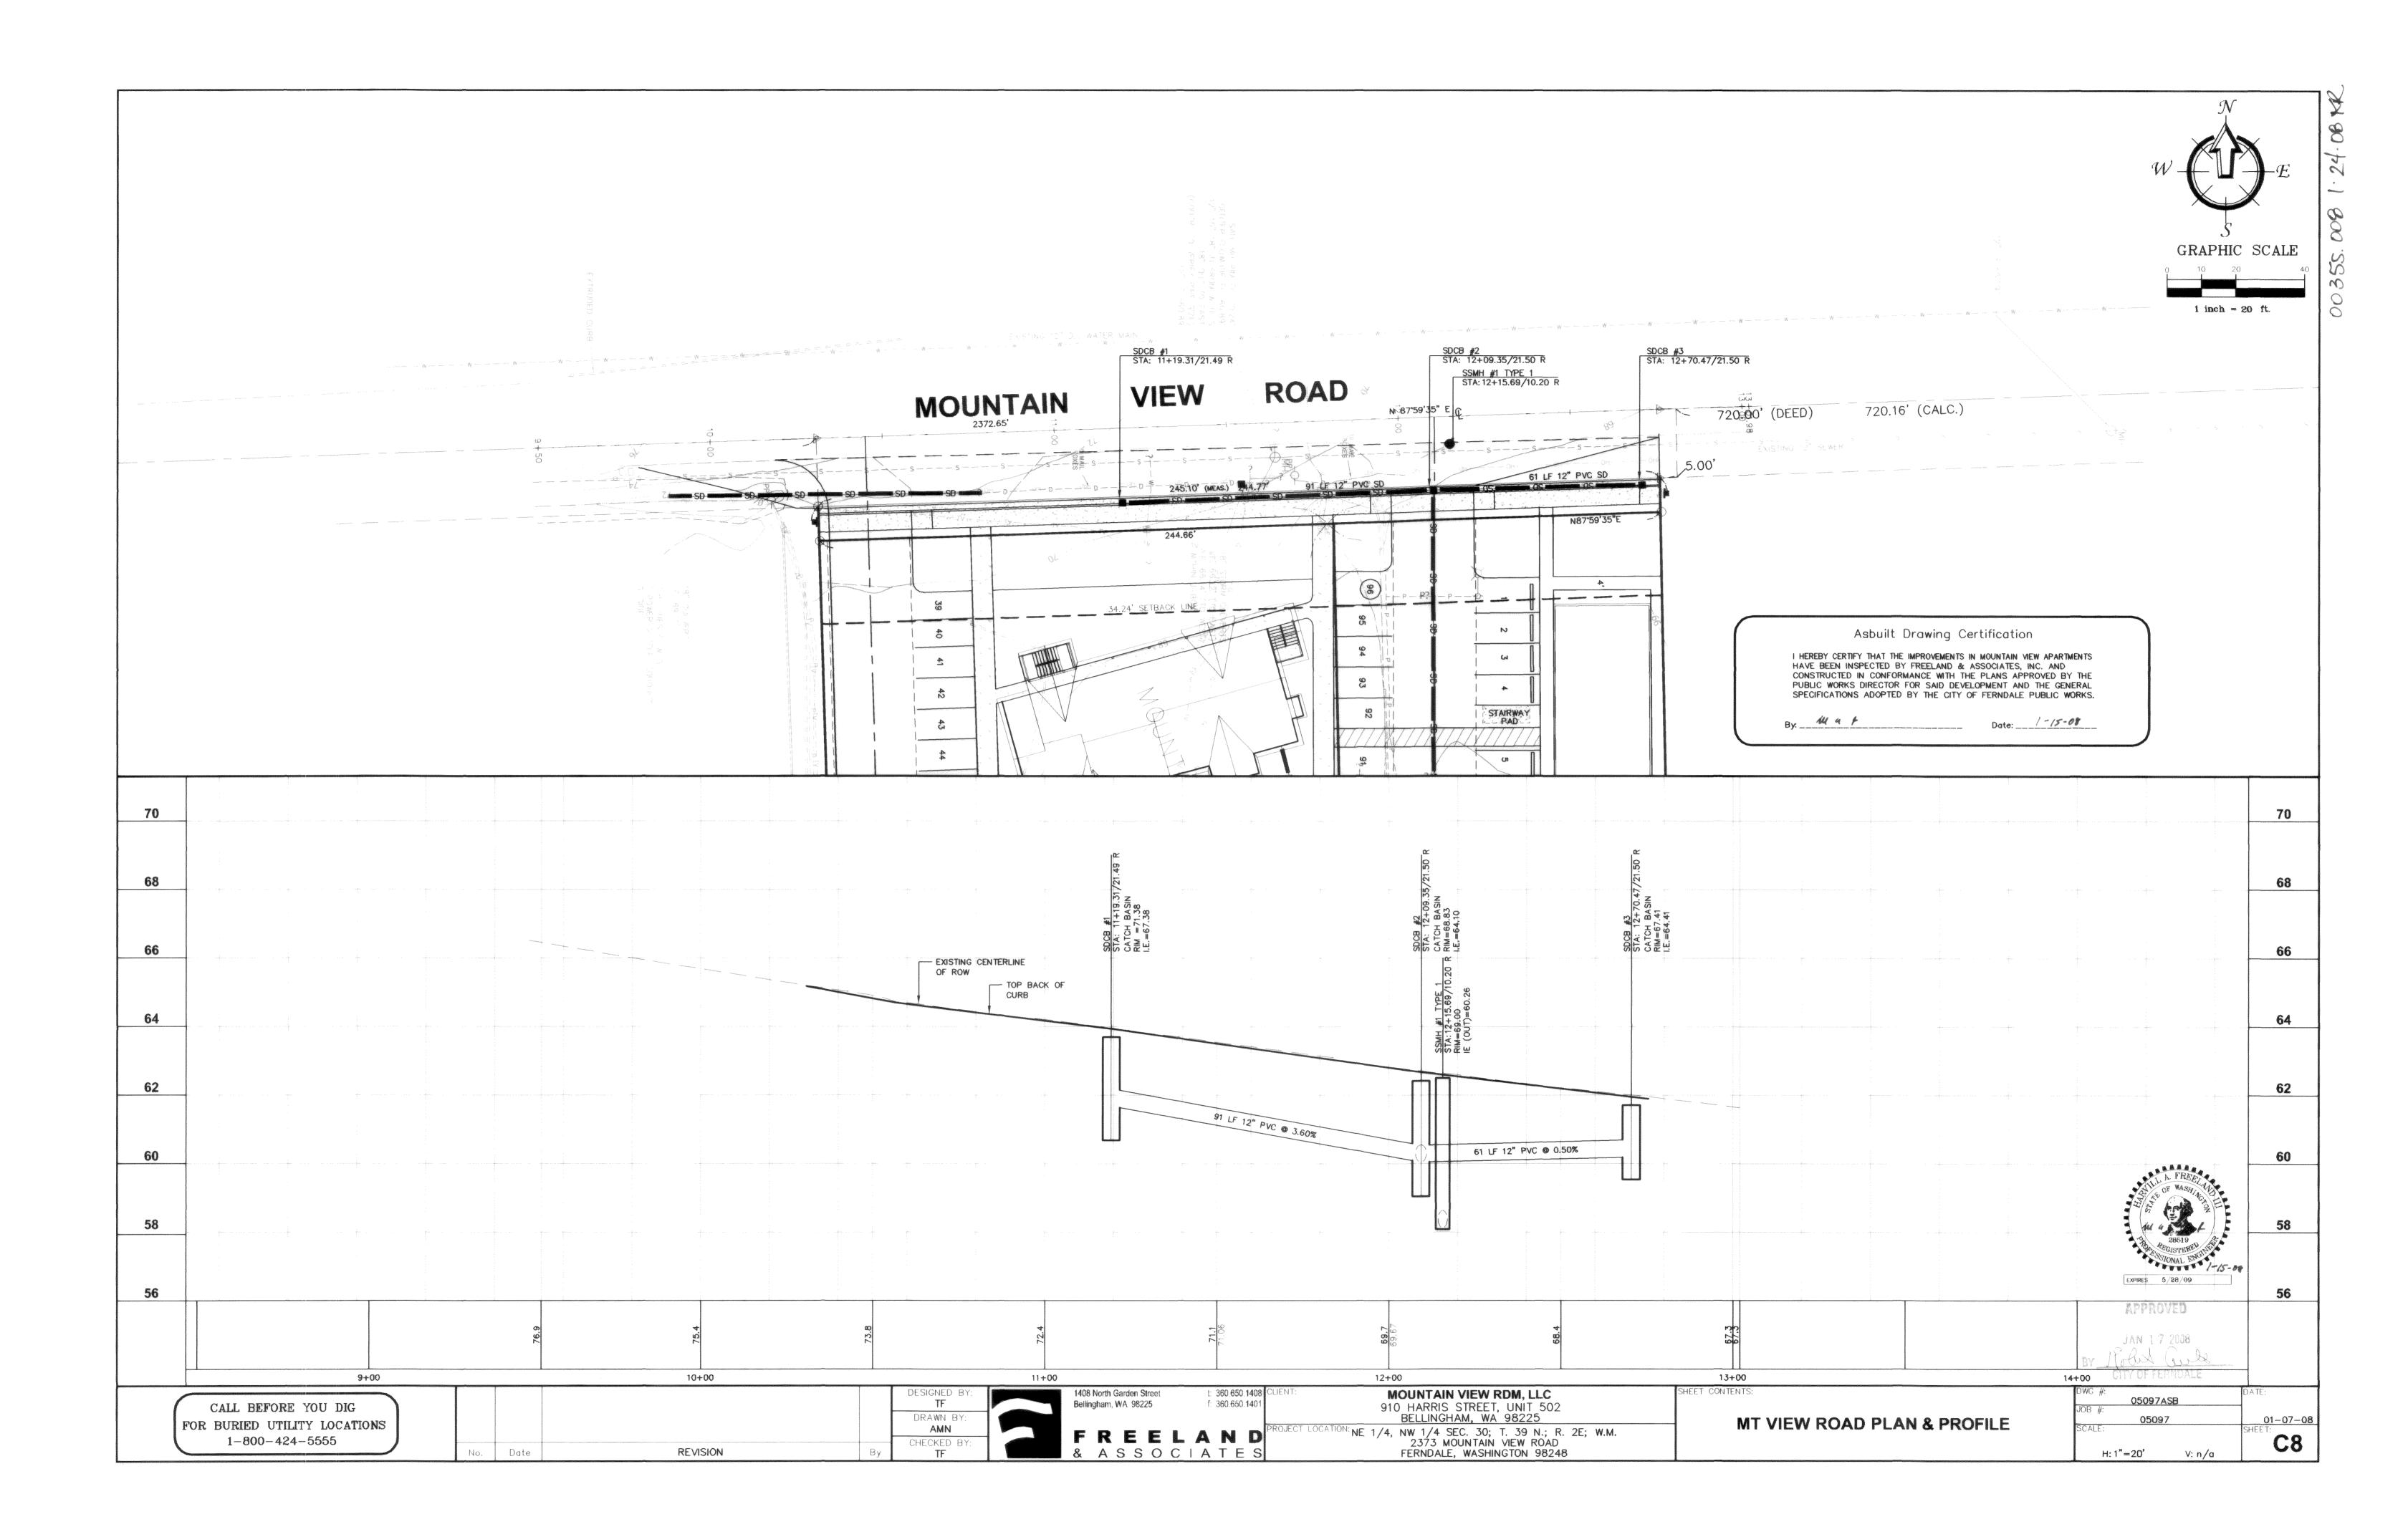

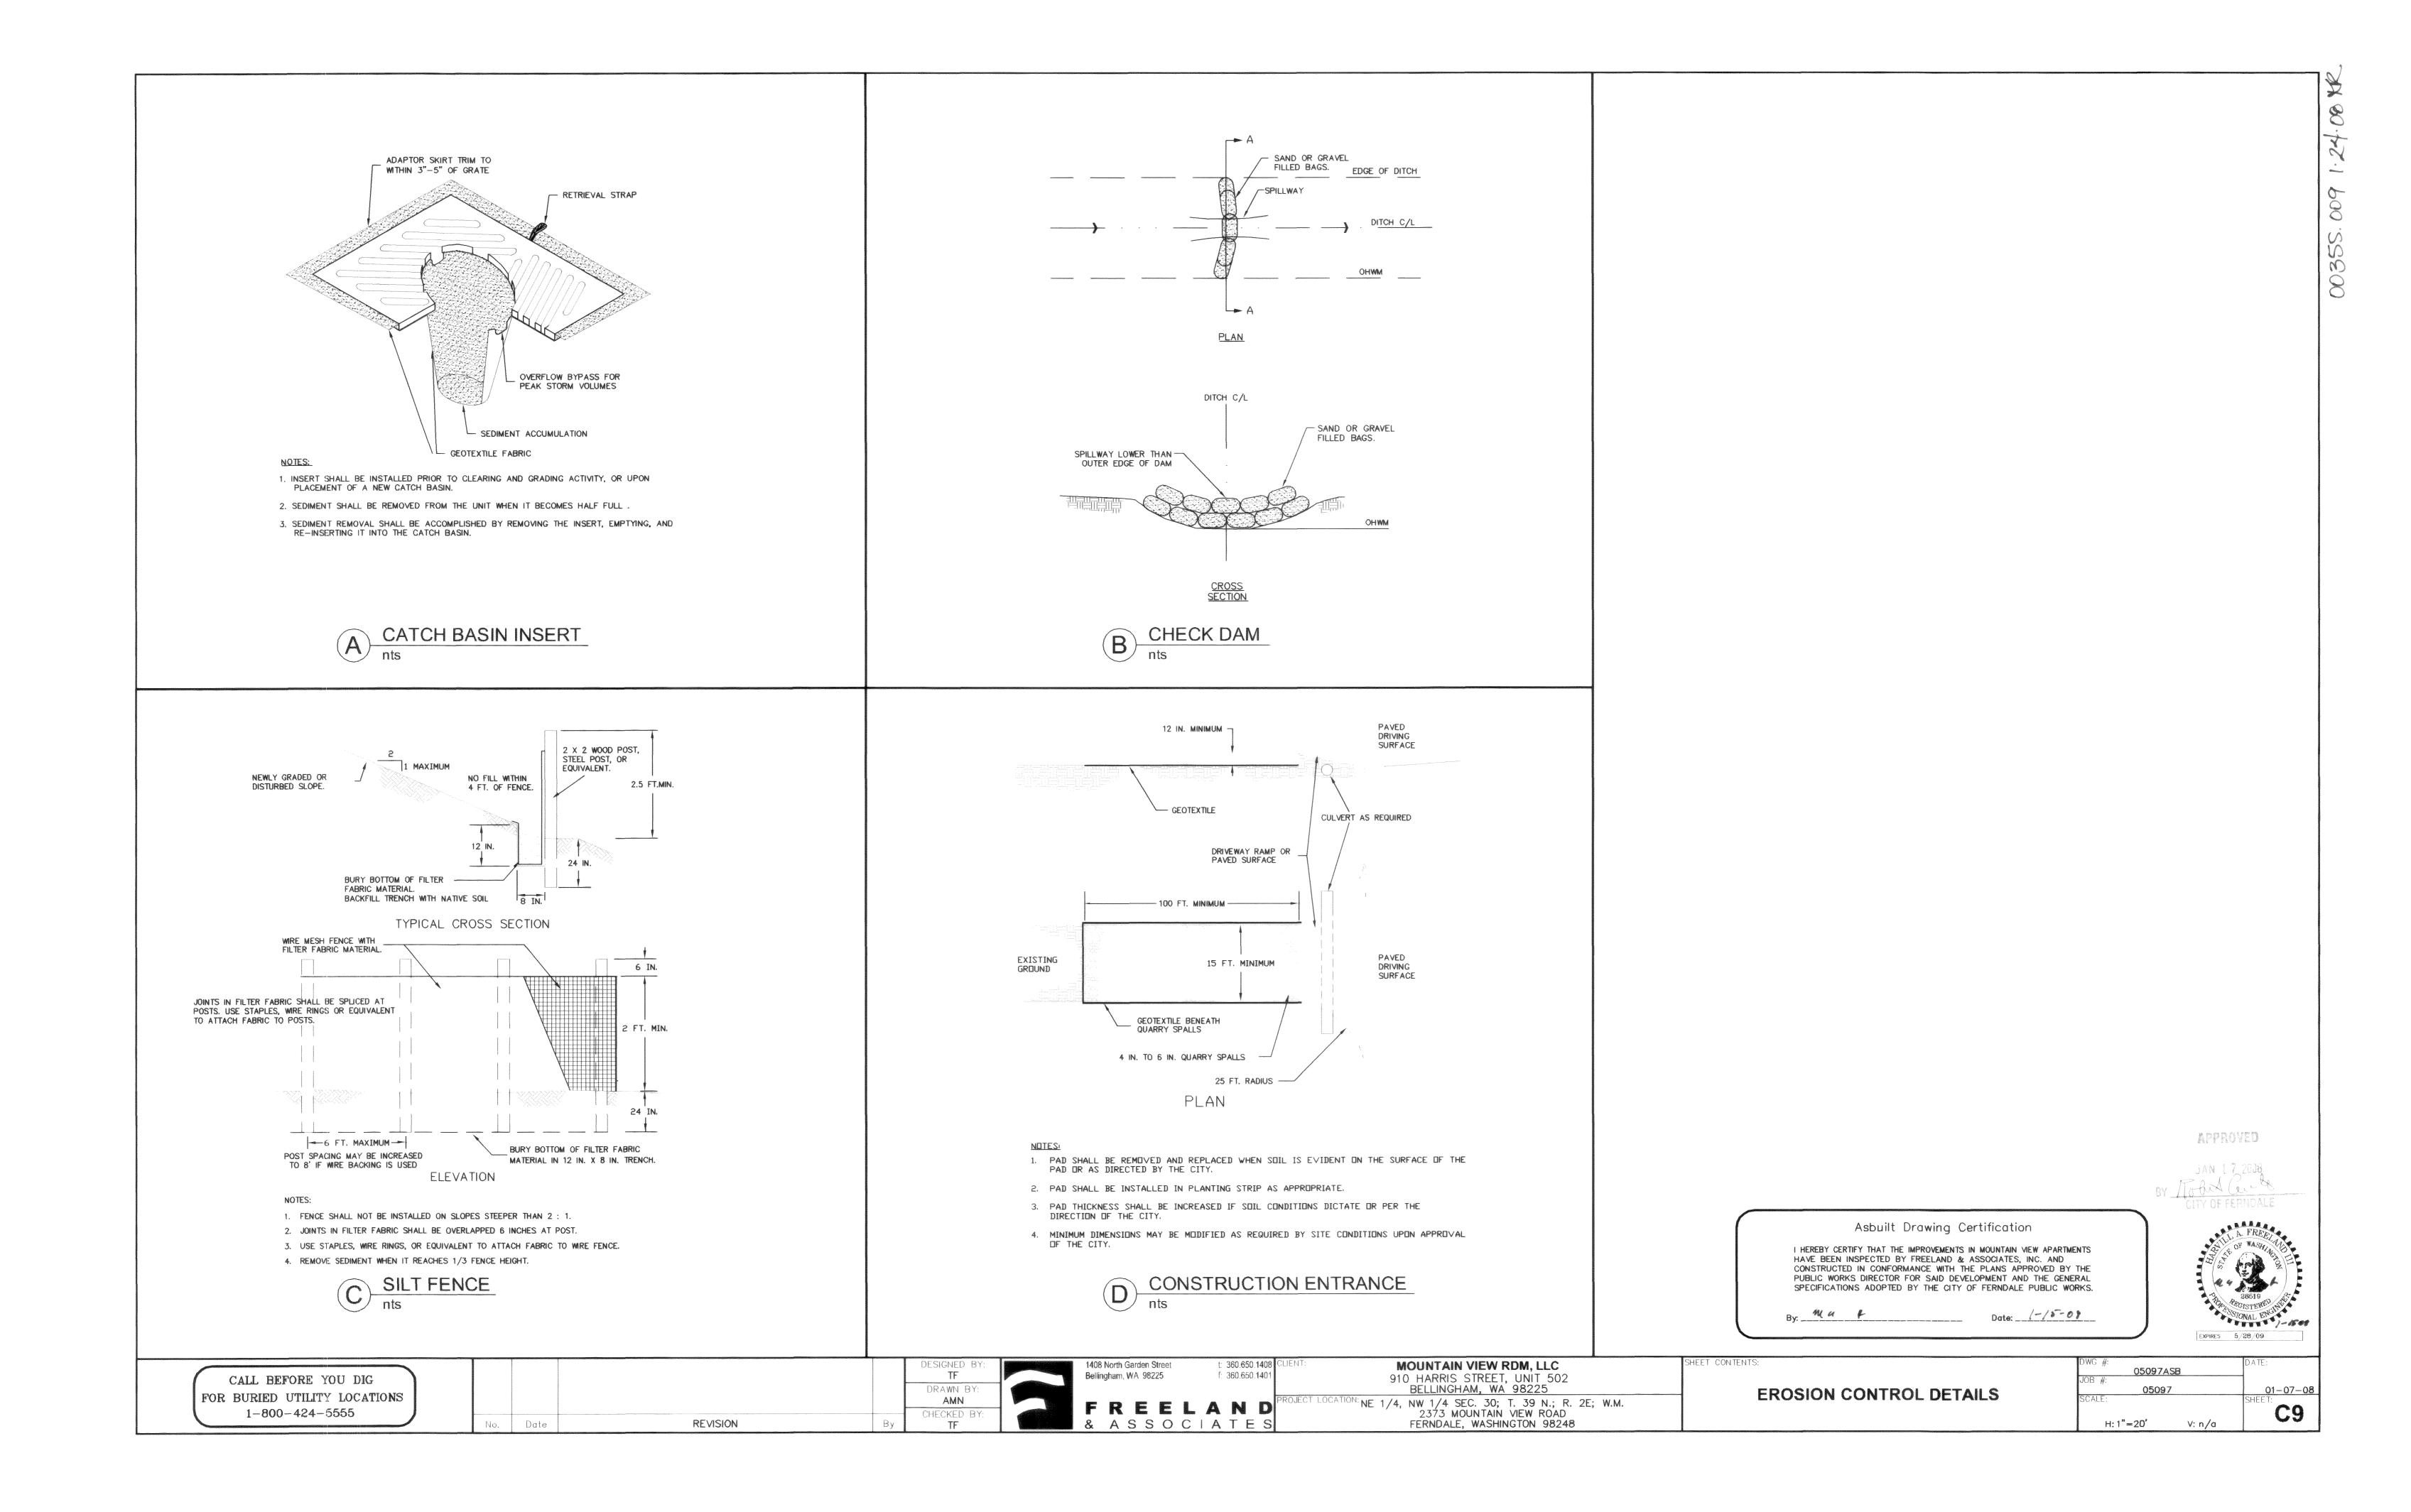

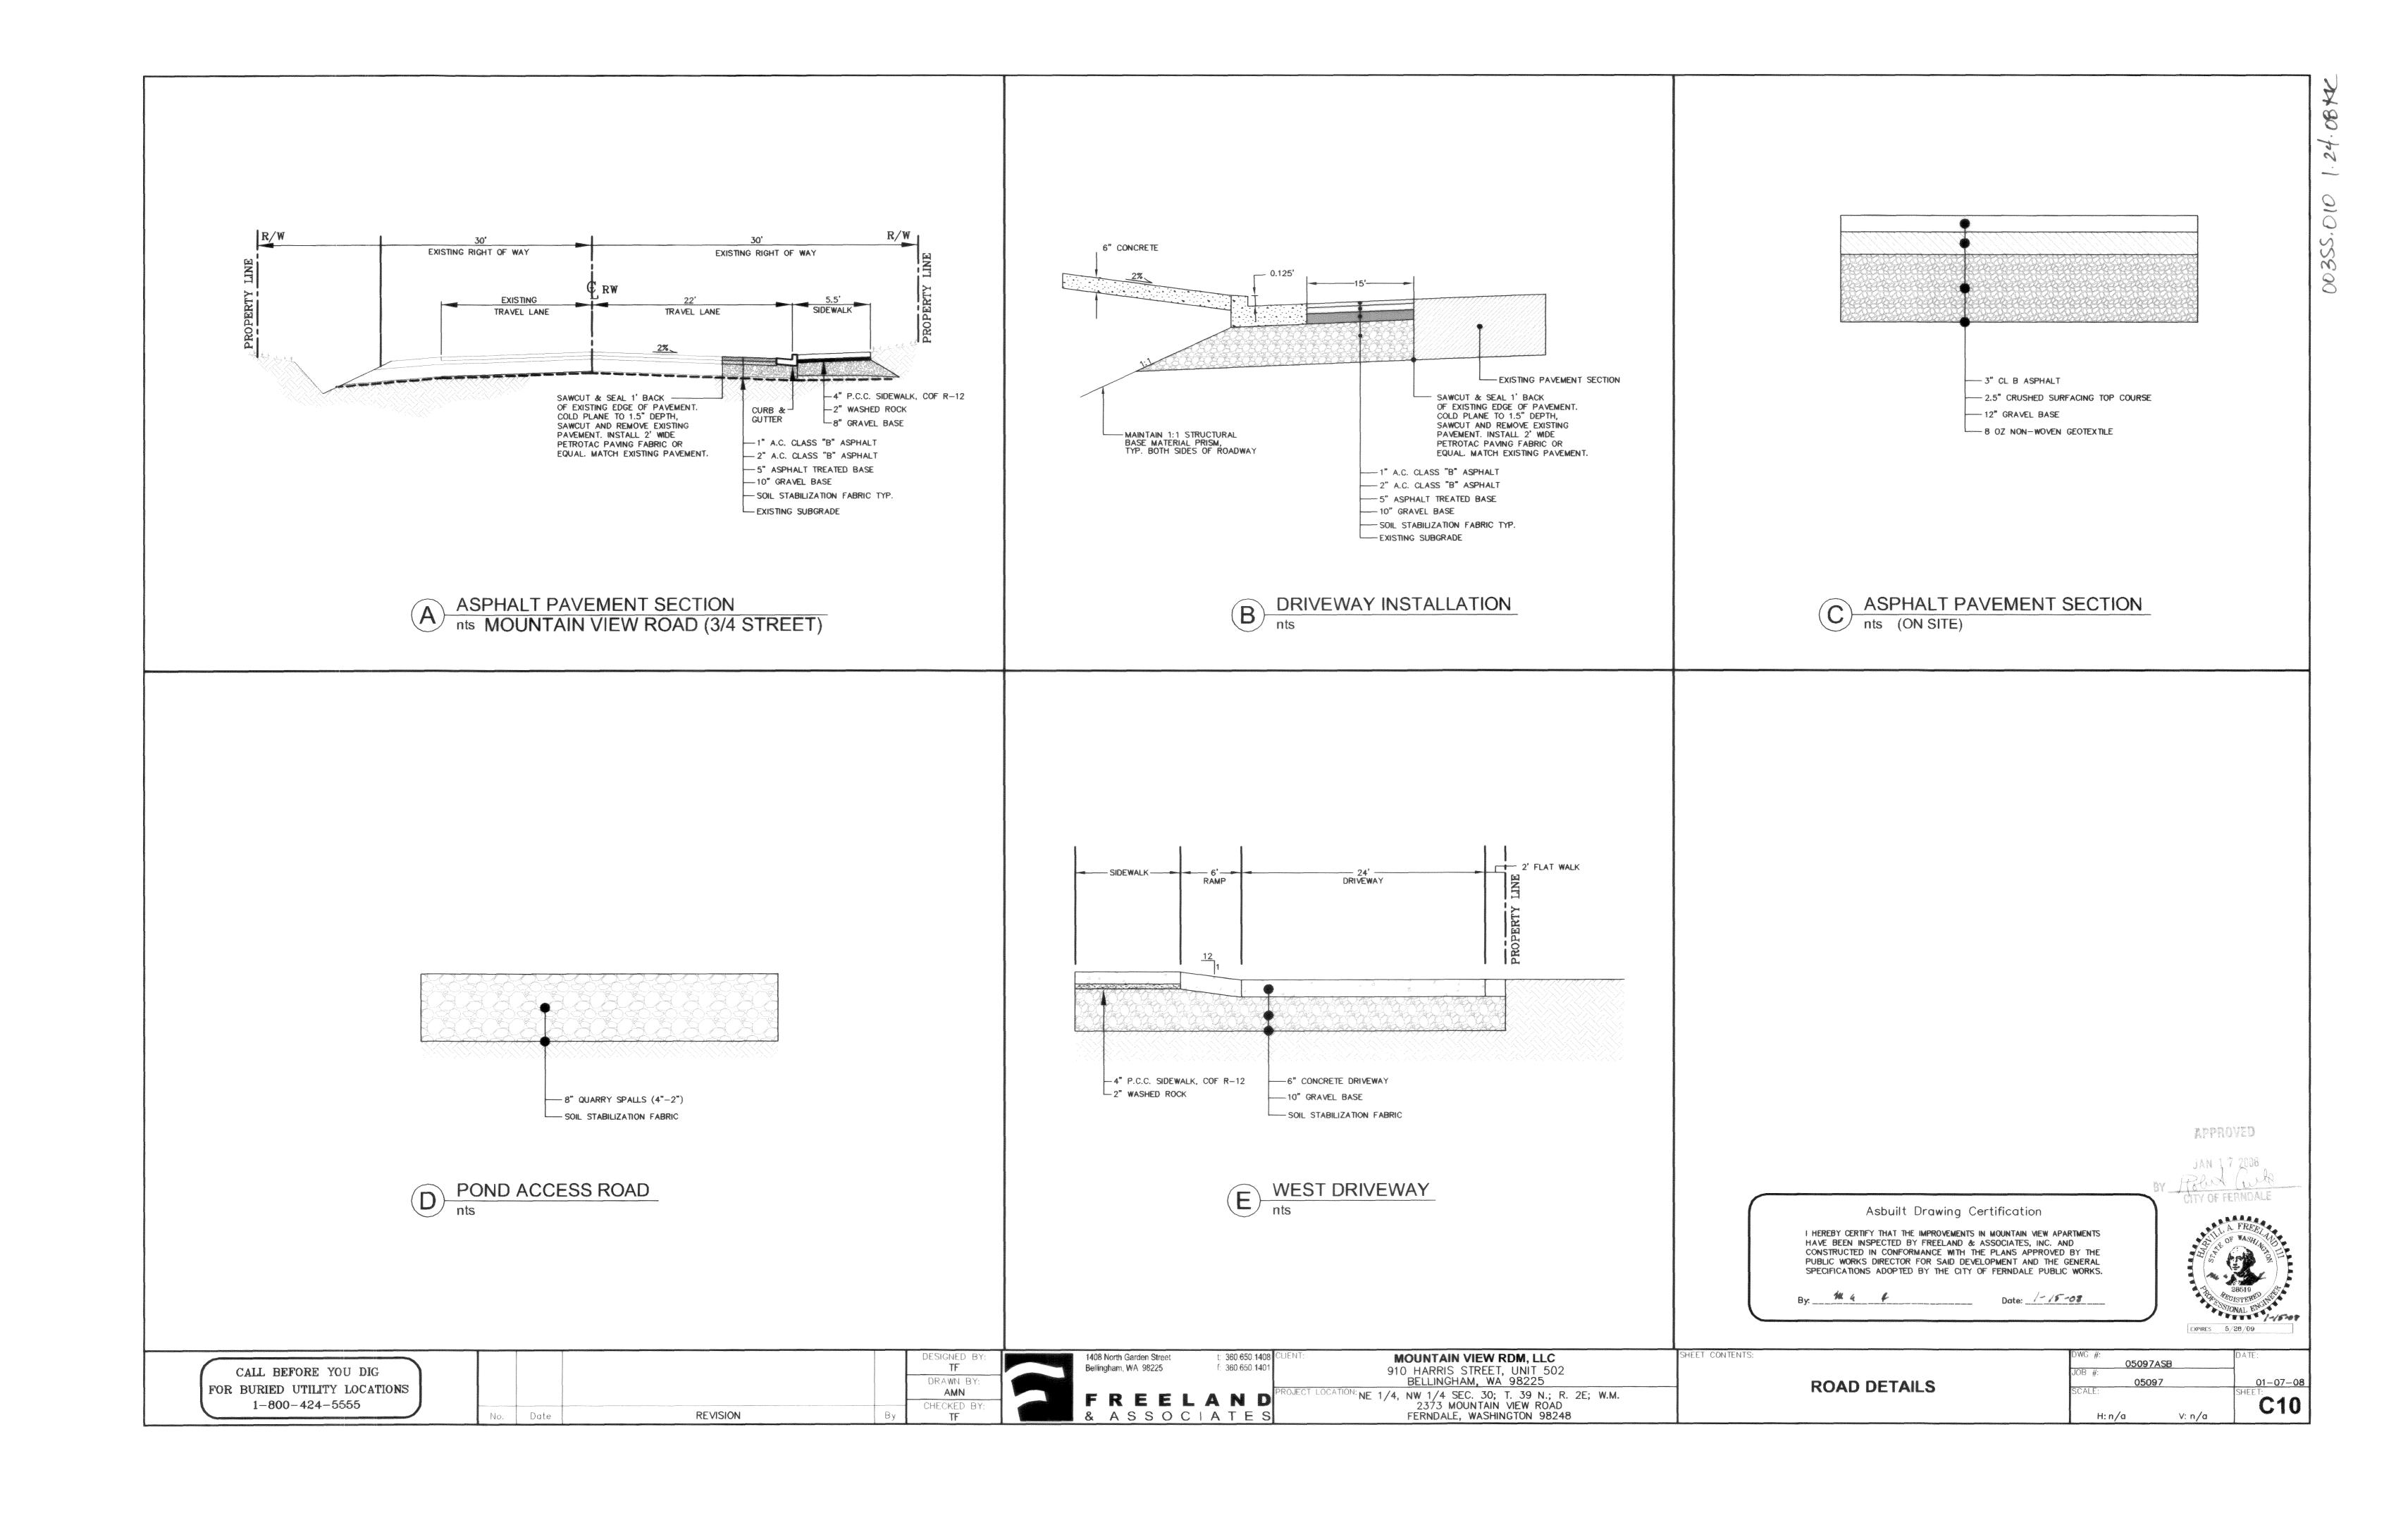

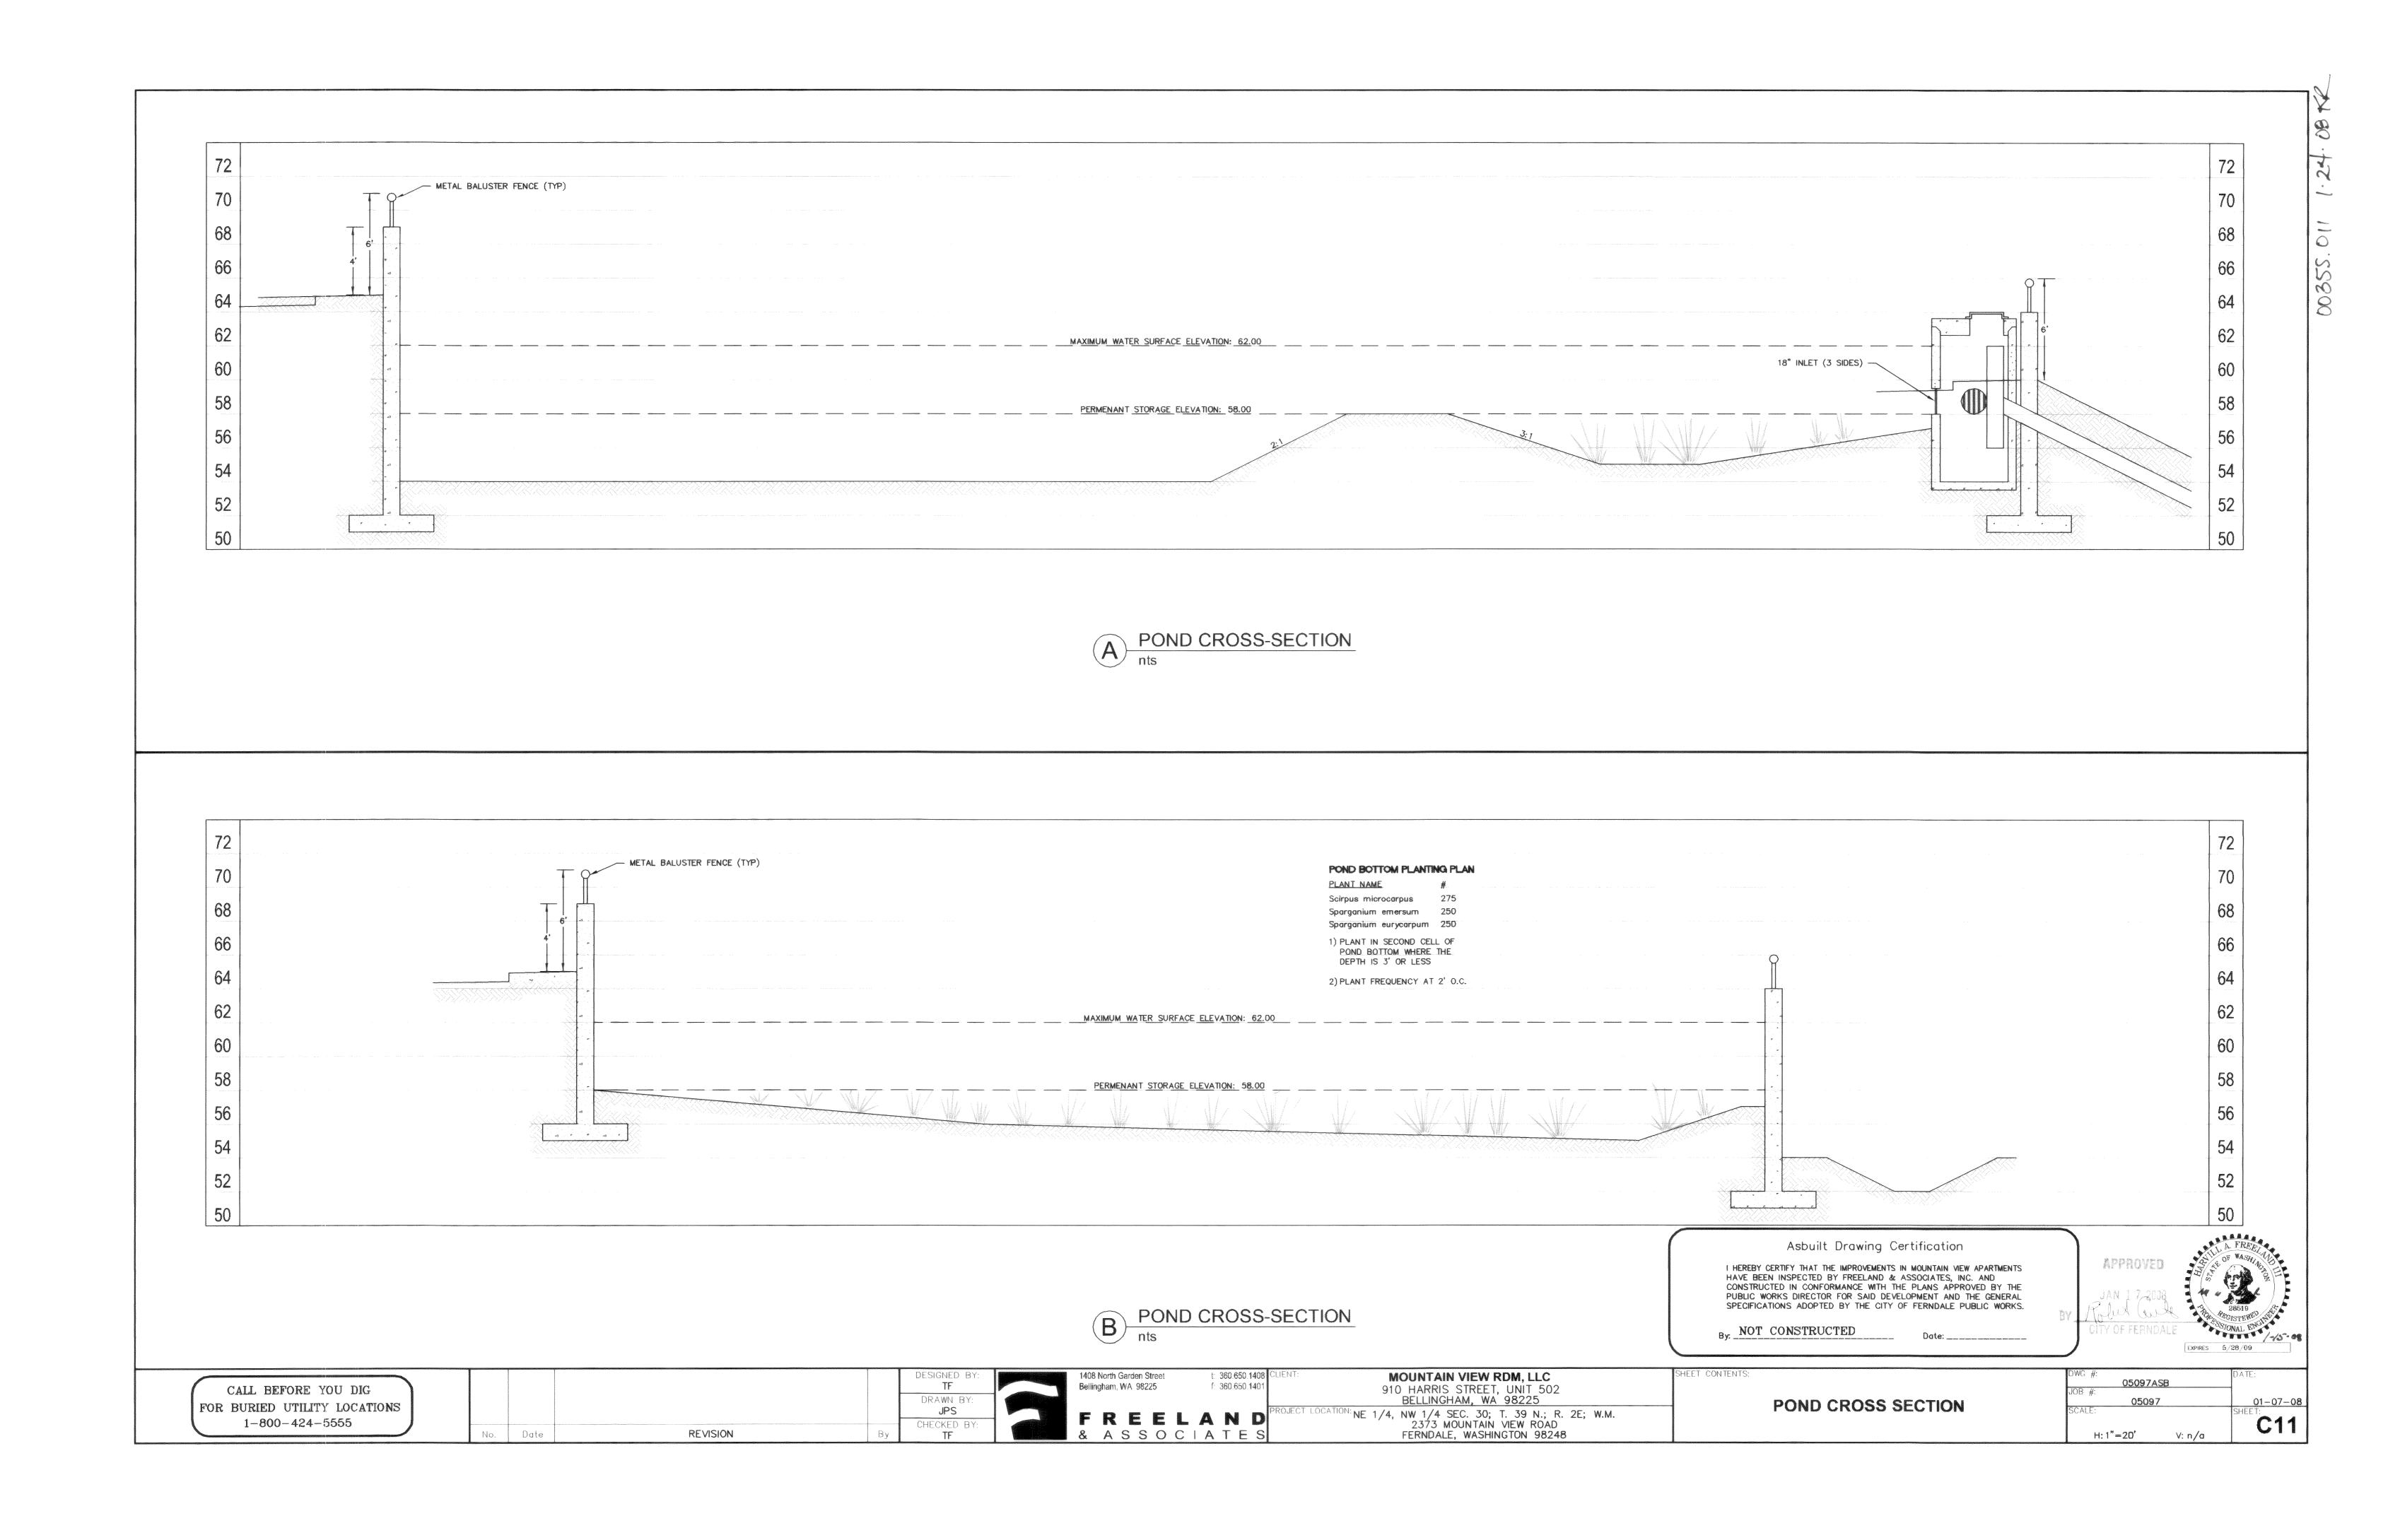



# NOTES:

- 1. USE A MINIMUM OF A 54" DIAMETER TYPE 2 CATCH BASIN.
- 2. OUTLET CAPACITY: 100-YEAR DEVELOPED PEAK
- FLOW.
  3. METAL PARTS: CORROSION RESISTANT. NON-GALVANIZED PARTS PREFERRED. GALVANIZED PIPE PARTS TO HAVE ASPHALT TREATMENT 1. 4. FRAME & LADDER OR STEPS OFFSET SO:
- A. CLEANOUT GATE IS VISIBLE FROM TOP.
- B. CLIMB-DOWN SPACE IS CLEAR OF RISER AND CLEANOUT GATE.
- C. FRAME IS CLEAR OF CURB.


  5. IF METAL OUTLET PIPE CONNECTS TO CEMENT CONCRETE PIPE: OUTLET PIPE TO HAVE SMOOTH O.D. EQUAL TO CONCRETE PIPE I.D. LESS 1/4".
- 6. PROVIDE AT LEAST ONE 3" X .090 INCHES SUPPORT BRACKET ANCHORED TO CB WALL (MAX. 3'-0" VERTICAL SPACING).
- 7. LOCATE ELBOW RESTRICTOR(S) AS NECESSARY TO PROVIDE MIN. CLEARANCE ÀS SHOWN. 8. LOCATE ADDITIONAL LADDER RUNGS IN STRUCTURES USED AS ACCESS TO TANKS OR VAULTS TO ALLOW ACCESS WHEN CATCH BASIN IS FILLED WITH WATER.

12" RISER ORIFICE SCHEDULE ELEVATION DIAMETER DIAMETER 56.00 0.79" N/A 62.04 1.28" 62.45 0.77"

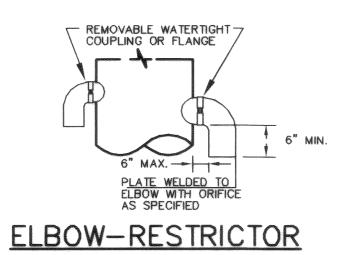

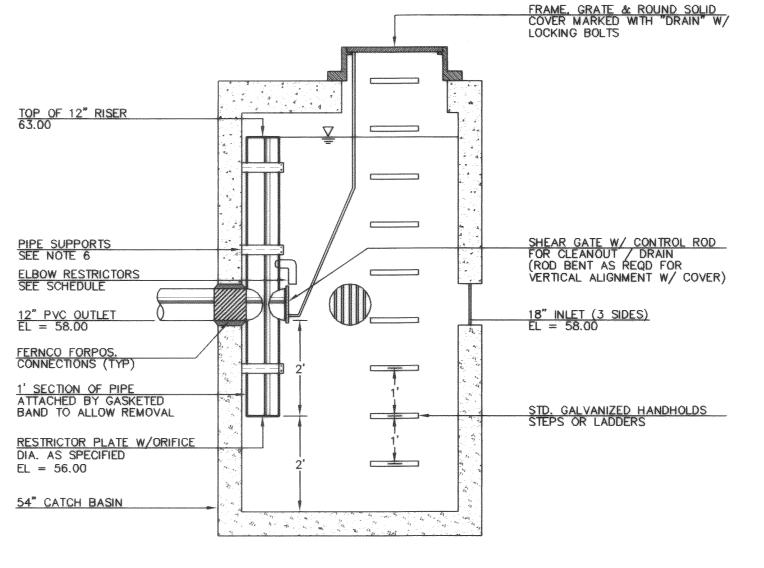


# SECTION A-A

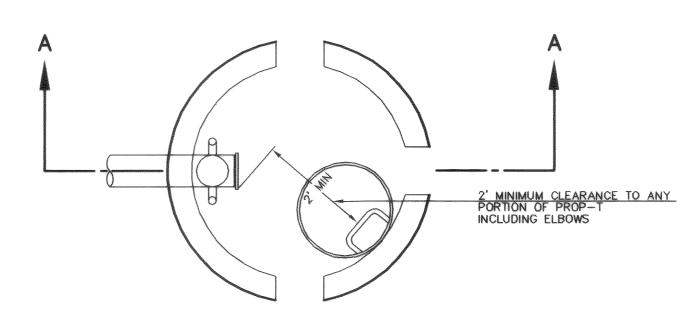

PLAN VIEW

A CONTROL MANHOLE nts



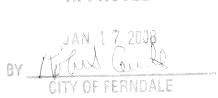



Asbuilt Drawing Certification

I HEREBY CERTIFY THAT THE IMPROVEMENTS IN MOUNTAIN VIEW APARTMENTS HAVE BEEN INSPECTED BY FREELAND & ASSOCIATES, INC. AND CONSTRUCTED IN CONFORMANCE WITH THE PLANS APPROVED BY THE PUBLIC WORKS DIRECTOR FOR SAID DEVELOPMENT AND THE GENERAL SPECIFICATIONS ADOPTED BY THE CITY OF FERNDALE PUBLIC WORKS.

By: NOT CONSTRUCTED

		DESIGNED BY:	1408 North Garden Stree	t: 360.650.1408 C	MOUNTAIN VIEW RDM, LLC	SHEET CONTENTS:	DWG #:	DATE:
CALL BEFORE YOU DIG		TF	Bellingham, WA 98225	f: 360.650. <b>14</b> 01	910 HARRIS STREET, UNIT 502		<b>05097ASB</b> JOB #:	Westparantening
FOR BURIED UTILITY LOCATIONS		DRAWN BY:		15	BELLINGHAM, WA 98225	STORMWATER DETAILS	05097	01-07-08
1-800-424-5555		JPS '	FREE	LAND	PROJECT LOGATION: NE 1/4, NW 1/4 SEC. 30; T. 39 N.; R. 2E; W.M.	J. J. G.	SCALE:	SHEET:
1-000-424-3333	No Date REVISION By	TE CHECKED BY:		CLATES	2373 MOUNTAIN VIEW ROAD FERNDALE WASHINGTON 98248		H: 1"-20' V: n /a	C12

#### GENERAL REQUIREMENTS

1. ALL WORK SHALL BE PERFORMED IN ACCORDANCE WITH THE STANDARD SPECIFICATIONS FOR ROAD, BRIDGE AND MUNICIPAL CONSTRUCTION, CURRENT EDITION AND THE CITY OF FERNDALE DEVELOPMENT STANDARDS AND SHALL BE SUBJECT TO APPROVAL BY THE CITY OF FERNDALE. IN THE EVENT OF A CONFLICT, THE MORE STRINGENT REQUIREMENT

2. THE CONTRACTOR SHALL BE RESPONSIBLE FOR DETERMINING SUB-SURFACE CONDITIONS

3. THE SURVEYOR SHALL LAY OUT AND SET ANY CONSTRUCTION STAKES AND MARKS NEEDED TO ESTABLISH THE LINES, GRADES, SLOPES OR CROSS-SECTIONS AS SHOWN ON THE PLANS OR AS STAKED BY THE ENGINEER.

4. THROUGHOUT THE WORK, THE CONTRACTOR SHALL COMPLY WITH ALL PERMITS.

5. THE CONTRACTOR SHALL PROTECT ALL PRIVATE AND PUBLIC UTILITIES FROM DAMAGE RESULTING FROM THE WORK.

6. WHEN THE CONTRACTOR CONSIDERS THE WORK PHYSICALLY COMPLETE AND READY FOR FINAL INSPECTION, THE CONTRACTOR SHALL REQUEST THAT CITY INSPECTOR TO SCHEDULE A FINAL INSPECTION. THE INSPECTOR WILL MAKE A FINAL INSPECTION AND NOTIFY THE CONTRACTOR IN WRITING OF ALL PARTICULARS IN WHICH THE FINAL INSPECTION REVEALS THE WORK INCOMPLETE OR UNACCEPTABLE. THE CONTRACTOR SHALL IMMEDIATELY TAKE SUCH CORRECTIVE MEASURES AS ARE NECESSARY TO REMEDY

7. BEFORE ANY CONSTRUCTION OR DEVELOPMENT ACTIVITY A PRE-CONSTRUCTION MEETING MUST BE HELD BETWEEN THE CONTRACTOR, OWNER, CITY ENGINEER AND PROJECT ENGINEER. (MINIMUM 3 DAYS PRIOR TO STARTING WORK)

8. A COPY OF THESE APPROVED PLANS MUST BE ON THE JOB SITE WHENEVER CONSTRUCTION IS IN PROGRESS.

9. THE CONTRACTOR SHALL BE RESPONSIBLE FOR PROVIDING ADEQUATE SAFEGUARDS, SAFETY DEVICES, PROTECTIVE EQUIPMENT, FLAGGERS, AND ANY OTHER NEEDED ACTIONS TO PROTECT THE LIFE, HEALTH AND SAFETY OF THE PUBLIC, AND TO PROTECT PROPERTY IN CONNECTION WITH THE PERFORMANCE OF WORK COVERED BY THE CONTRACTOR. ANY WORK WITHIN THE TRAVELED RIGHT-OF-WAY THAT MAY INTERRUPT NORMAL TRAFFIC FLOW SHALL REQUIRE AT LEAST ONE FLAGGER FOR EACH LANE OF TRAFFIC AFFECTED. ALL SECTIONS OF THE WSDOT STANDARD SPECIFICATIONS 1-07.23-PUBLIC CONVENIENCE AND SAFETY,

10. PROOF OF LIABILITY INSURANCE SHALL BE SUBMITTED TO THE CITY PRIOR TO THE PRE-CONSTRUCTION MEETING.

11. NO WORK SHALL OCCUR BETWEEN 7:00 PM & 7:00 AM.

12. ALL HARD SURFACED PAVEMENTS MUST BE REPAIRED AT THE CLOSE OF EACH WORK DAY. THE REPAIRS CAN BE TEMPORARY WITH ASPHALT COLD MIX OR PERMANENT WITH HOT MIX ASPHALT OR CONCRETE. ALL REPAIRS SHALL BE ACCORDING TO CITY OF FERNDALE

13. ALL WORK MUST BE INSPECTED BY A REPRESENTATIVE OF THE CITY OF FERNDALE ENGINEERING DIVISION, AND 24 HOURS NOTICE MUST BE GIVEN PRIOR TO STARTING WORK OR TO SCHEDULE INSPECTIONS IN ACCORDANCE WITH SECTION 302 OF THE

14. UPON COMPLETION OF THE PROJECT A CERTIFIED AS-BUILT PRINT SHALL BE PROVIDED TO THE CITY. AS-BUILTS SHALL BE ACCORDING TO CITY OF FERNDALE

15. THE LOCATIONS OF UNDERGROUND FACILITIES SHOWN ON THESE PLANS ARE BASED ON FIELD SURVEYS AND LOCAL UTILITY COMPANY RECORDS. IT SHALL BE THE CONTRACTOR'S FULL RESPONSIBILITY TO CONTACT THE VARIOUS UTILITY COMPANIES TO LOCATE THEIR FACILITIES PRIOR TO STARTING CONSTRUCTION. NO EXTRA COMPENSATION SHALL BE PAID TO THE CONTRACTOR FOR DAMAGE AND REPAIR TO THESE FACILITIES CAUSED BY HIS WORK FORCE. CALL 1-800-424-5555 FOR UTILITY LOCATE 48 HOURS PRIOR TO WORK, CONTRACT TO HOLD. THE CONTRACTOR SHALL NOTIFY THE ENGINEER PROMPTLY OF ANY CONFLICT. THE CONTRACTOR SHALL BE RESPONSIBLE FOR MAINTAINING THE INTEGRITY OF ALL ADJACENT UTILITIES WHICH INCLUDE BUT ARE NOT LIMITED TO: WATER, SEWER, STORM SEWER, POWER, TELEPHONE, CABLE TV, IRRIGATION, AND STREET LIGHTING. CONTRACTOR SHALL RESTORE ALL PRIVATE AND PUBLIC PROPERTY DISTURBED BY THE PROJECT UPON COMPLETION OF THE PROJECT.

16. A REVOCABLE ENCROACHMENT PERMIT SHALL BE OBTAINED PRIOR TO COMMENCING WORK IN THE PUBLIC RIGHT OF WAY.

1. GRAVEL BASES AND BALLAST MAXIMUM PARTICLE SIZE PASSING THE U.S. NO. 200 SIEVE SHALL NOT EXCEED 5%.

2. BALLAST, GRAVEL BASE AND CRUSHED SURFACING SHALL BE COMPACTED TO AT LEAST 95% OF ITS MAXIMUM DRY DENSITY.

3. THE CONTRACTOR OR PROPONENT SHALL BE RESPONSIBLE FOR ALL COMPACTION TESTING. ALL TESTING SHALL BE THROUGH ENGINERRING REVIEW ACCOUNT AND PAID FOR BY TEH OWNER.

1. WHERE SHOWN ON THE PLANS, PAVEMENT MARKINGS SHALL BE OBLITERATED UNTIL BLEMISHES CAUSED BY THE PAVEMENT MARKING REMOVAL CONFORM TO THE COLORATION OF THE ADJACENT PAVEMENT.

2. SOIL RESIDUAL HERBICIDE SHALL BE PLACED WITHIN 24 HOURS OF PAVING.

3. A TACK COAT OF ASPHALT SHALL BE APPLIED BETWEEN ALL COURSES OF ASPHALT. 4. ALL PAVEMENT REPAIR SHALL BE SAW-CUT BEFORE REMOVAL. AR-4000W SHALL BE

5. ASPHALT CONCRETE PAVEMENT SHALL NOT BE PLACED NOR COMPACTED DURING HOURS OF DARKNESS.

6. SUBGRADE SHALL BE CERTIFIED IN WRITTING BY THE ENGINEER PRIOR TO PAVING.

1. TEST PRESSURE FOR WATERMAIN ACCEPTANCE SHALL BE 225 p.s.i. AT THE HIGHEST POINT ON THE WATER LINE AND SHALL BE DONE ACCORDING TO CITY OF FERNDALE REQUIREMENTS. ALL PURIFICATION ACCEPTANCE TESTING SHALL BE ACCORDING TO CITY OF FERNDALE REQUIREMENTS. THE PIPE WILL NOT PASS UNLESS A ZERO BACTERIA COUNT IS OBTAINED FOR TWO CONSECUTIVE TESTS 24 HOURS APART.

2. ALL BACKFILL SHALL BE IMPORTED GRAVEL AND SHALL CONFORM TO SECTION 2-09 OF THE STANDARD SPECIFICATIONS FOR ROAD, BRIDGE AND MUNICIPAL CONSTRUCTION.

3. ALL PIPE SHALL HAVE A MINIMUM COVER OF 3.5 FEET.

APPLIED TO ALL EDGES OF EXISTING PAVEMENT.

1. THE CONTRACTOR SHALL CLEAR, GRUB AND CLEAN UP THOSE AREAS SHOWN ON THE

2. THE CONTRACTOR SHALL EXCAVATE AND GRADE TO THE ALIGNMENT, GRADE AND CROSS-SECTIONS SHOWN IN THE PLANS OR ESTABLISHED BY THE ENGINEER. IN

3. MAXIMUM DENSITY AND OPTIMUM MOISTURE FOR GRANULAR MATERIALS WILL BE DETERMINED USING ASTM D-1557 TEST METHOD.

4. UNSUITABLE MATERIAL NOT FIT FOR A SUB-GRADE SHALL BE EXCAVATED TO THE BOUNDARIES SET BY THE ENGINEER AND REPLACED WITH A SUITABLE BACKFILL MATERIAL.

### STORM DRAINAGE

1. ALL PIPE AND APPURTENANCES SHALL BE LAID ON A PROPERLY PREPARED FOUNDATION IN ACCORDANCE WITH WSDOT 7-08. THIS SHALL INCLUDE LEVELING AND COMPACTING THE TRENCH BOTTOM, THE TOP OF THE FOUNDATION MATERIAL AND ANY REQUIRED PIPE BEDDING, TO A UNIFORM GRADE SO THAT THE ENTIRE PIPE IS SUPPORTED BY A UNIFORMLY DENSE UNYIELDING BASE.

2. ALL DRAINAGE STRUCTURES, SUCH AS CATCH BASINS AND MANHOLES, NOT LOCATED WITHIN A TRAVELED ROADWAY OR SIDEWALK, SHALL HAVE SOLID LOCKING LIDS. ALL DRAINAGE STRUCTURES ASSOCIATED WITH A PERMANENT RETENTION/DETENTION FACILITY SHALL HAVE SOLID LOCKING LIDS.

3. ALL CATCH BASIN GRATES SHALL INCLUDE THE STAMPING "OUTFALL TO STREAM, DUMP NO POLLUTANTS.

#### STORM DRAINAGE CONT.

4. ALL DRIVEWAY CULVERTS LOCATED WITHIN THE RIGHT-OF-WAY SHALL BE OF SUFFICIENT LENGTH TO PROVIDE A MINIMUM 3:1 SLOPE FROM THE EDGE OF THE DRIVEWAY TO THE BOTTOM OF THE DITCH. CULVERTS SHALL HAVE BEVELED END SECTIONS PER WSDOT

5. THE CONTRACTOR IS RESPONSIBLE FOR COORDINATING THE LOCATIONS OF ALL STUB-OUT CONVEYANCE LINES WITH RESPECT TO THE UTILITIES (E.G. POWER, GAS, TELEPHONE, TELEVISION).

#### SANTARY SEWER SPECIFICATIONS

1. ALL WORK AND MATERIALS SHALL BE IN ACCORDANCE WITH THE STANDARD SPECIRFICATIONS FOR ROAD, BRIDGE, AND MUNICIPAL CONSTRUCITON, CURRENT EDITION AND THE CITY OF FERNDALE DEVELOPMENT STANDARDS SECTON 5 AND SHALL BE SUBJECT TO

2. FOUR INCH THROUGH TWELVE-INCH PIPE SHALL BE PVC PIPE CONFORMING TO ASTM D-3034, SDR-35 OR EQUAL. PIPE JOINTS SHALL BE MADE WITH FLEXIBLE GASKETS CONFOMING TO THE REQUIREMENTS OF SECTION 7-17.3G (2)E OF THE STANDARD SPECIFICATIONS.

3. TRENCH EXCAVATION SHALL BE ACCORDING TO SECTION 7-17,3(1)A OF THE STANDARD

4. THE BEDDING SHALL BE PEA GRAVEL PER SS-1.

5. PIPE LAYING SHALL MEET THE REQUIREMENTS OF SECTION 7-17.3(2)B OF THE STANDARD

6. ALL SIDE SEWERS SHALL BE CONSTRUCTED ACCORDING TO THE CITY OF FERNDALE STANDARD PLAN SS-6 THROUGH SS-8. CONNECT SIDE SEWERS PER COF DWG SS-12.

7. ALL TRENCH BACKFILL UNDER EXISTING OR FUTURE PAVING SHALL BE BANK RUN GRAVEL, CLASS "B" AND SHALL BE COMPACTED TO 95% OF MAXIMUM DENSITY.

8. ALL SEWER PIPE WILL BE PRESSURE TESTED AND WILL SCANNED BY MEANS OF A TV CAMERA PRIOR TO ACCEPTANCE BY THE CITY OF FERNDALE.

9. ALL MANHOLES WILL BE ACCORDING TO THE CITY OF FERNDALE STANDARD PLAN NO. SS-2.

10. ALL CLEANOUTS SHALL BE ACCORDING TO CITY OF FERNDALE STANDARD PLAN NO. SS-5. 11. ALL HARD SURFACED PAVEMENTS MUST BE REPAIRED AT THE CLOSE OF EACH WORK DAY. THE REPAIRS CAN BE TEMPORARY WITH ASPHALT COLD MIX OR PERMANENT WITH HOT MIX ASPHALT OR CONCRETE.

12. ALL WORK MUST BE INSPECTED AND APPROVED BY A REPRESENTATIVE OF THE CITY OF FERNDALE PUBLIC WORKS, AND 24 HOURS NOTICE MUST BE GIVEN PRIOR TO

13. ALL TESTING SHALL BE DONE IN THE PRESENCE AND UNDER THE SUPERVISION OF A REPRESENTATIVE OF THE CITY OF FERNDALE.

APPROVED

Asbuilt Drawing Certification

I HEREBY CERTIFY THAT THE IMPROVEMENTS IN MOUNTAIN VIEW APARTMENTS HAVE BEEN INSPECTED BY FREELAND & ASSOCIATES, INC. AND CONSTRUCTED IN CONFORMANCE WITH THE PLANS APPROVED BY THE PUBLIC WORKS DIRECTOR FOR SAID DEVELOPMENT AND THE GENERAL SPECIFICATIONS ADOPTED BY THE CITY OF FERNDALE PUBLIC WORKS.



CALL BEFORE YOU DIG FOR BURIED UTILITY LOCATIONS 1-800-424-5555

REVISION Date

1408 North Garden Street Bellingham, WA 98225

t: 360.650.1408 f: 360.650.1401

MOUNTAIN VIEW RDM, LLC 910 HARRIS STREET, UNIT 502 BELLINGHAM, WA 98225 DJECT LOCATION: NE 1/4, NW 1/4 SEC. 30; T. 39 N.; R. 2E; W.M. 2373 MOUNTAIN VIEW ROAD

FERNDALE, WASHINGTON 98248

HEET CONTENTS

05097ASB V: n/a H: n/a

**GENERAL NOTES** 

DRAWN B AMM CHECKED BY

FREELAND & ASSOCIATE