
PORTAL WAY / 1-5 ROUNDABOUT IMPROVEMENTS FERNDALE, WA


PROJECT No. ST2016-03

VICINITY MAP

PROJECT LOCATED IN SECTION 20, TOWNSHIP 39N, RANGE 2E, W.M.

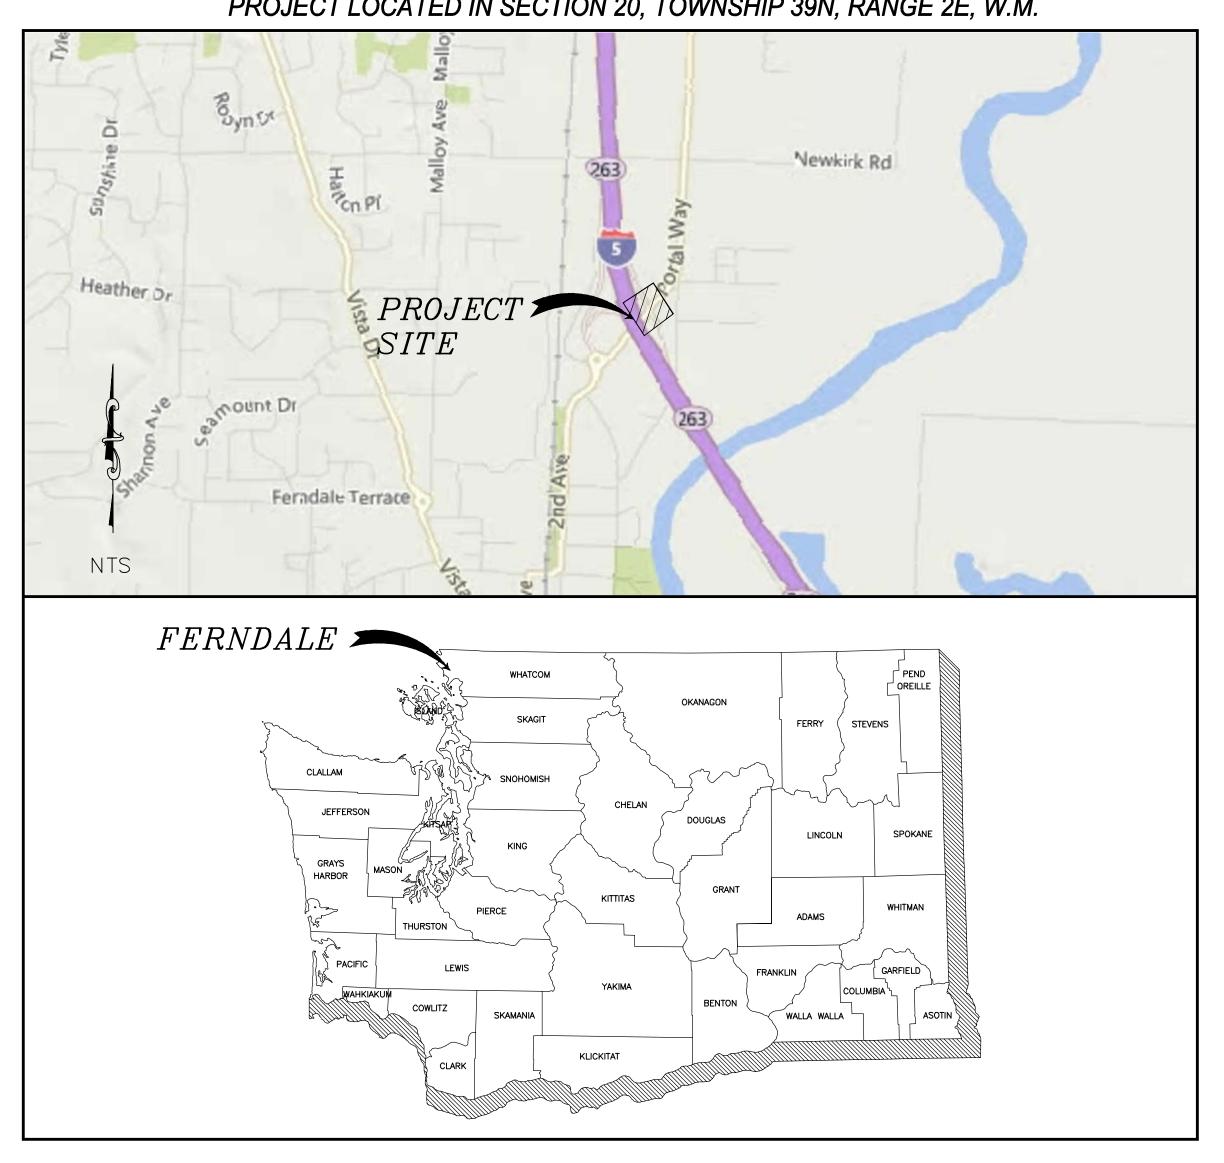

	SHEET SERIES INDEX
SHEET	DESCRIPTION
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4	I-5 EXIT 263 - NB RAMPS - S. SHOULDER CLOSURE
5	I-5 EXIT 263 - NB RAMPS - N. SHOULDER CLOSURE
6	I-5 EXIT 263 - NB RAMPS - ON RAMP CLOSURE
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10	I-5 EXIT 263 - NB RAMPS - LANE CLOSURE SIGNAGE
11	I-5 EXIT 263 - NB RAMPS - NON-WORKING HOURS
12	EXISTING CONDITIONS
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MK2	PAVEMENT MARKING PLAN
SS1	SIGN SPECIFICATIONS
SS2	SIGN SPECIFICATIONS
SN1	SIGNING PLAN
SN2	SIGNING PLAN
IL1	ILLUMINATION PLAN
IT1	ITS RELOCATION PLAN

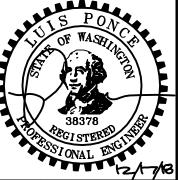

SUBMITTED WITH	
DESIGN PLAN	

DESIGNED BY	
LP	
DRAWN BY	
RWG	
CHECKED BY	P.O. Box 97
LP	813 Metcalf

Reichhardt & Ebe ENGINEERING INC 978 | 423 Front Street, Lynden, WA 98264 (360) 354-3687 Street, Sedro-Woolley, WA 98284 (360) 855-1713

DATE DESCRIPTION CITY OF FERNDALE **2095 MAIN ST** FERNDALE, WA 98248

PORTAL WAY / I-5 ROUNDABOUT IMPROVEMENTS COVER

			~ 7 7 7 7	12/17/6
OWG 16033 COVE	R		DATE	
			12/17	/2018
JOB#	SCALE		SHEET	1
16033	H: N/A	∨: N/A		of 20

	DIAMETER	5 1400	END VEDTON OUDVE OTATON	1100	MODIFIED	_	00171
Ø	= DIAMETER	EVCS	= END VERTICAL CURVE STATION	MOD	= MODIFIED	S	= SOUTH
AC	= ASBESTOS CEMENT	EX, EXIST	= EXISTING	MON	= MONUMENT	SCH	= SCHEDULE
AD	= ALGEBRAIC DIFFERENCE	IR	= EXISTING IRRIGATION	MPOC	= MID-POINT ON CURVE	SD	= STORM DRAIN
ASPH	= ASPHALT	F&C	= FRAME AND COVER	MTR	= METER	SDCB	= STORM DRAIN CATCH BASIN
BLDG	= BUILDING	F&G	= FRAME AND GRATE	MW	= MONITORING WELL	SDMH	= STORM DRAIN MANHOLE
BVCE	= BEGIN VERTICAL CURVE ELEVATION	FF	= FINISHED FLOOR	N	= NORTH	SE	= SOUTHEAST
BVCS	= BEGIN VERTICAL CURVE STATION	FG	= FINISHED GRADE	NE	= NORTHEAST	SN	= EXISTING SIGN
C&G	= CURB & GUTTER	FL	= FLOW LINE	NW	= NORTHWEST	SP	= STANDARD PLAN
CATV	= CABLE TELEVISION	FT	= FEET	OC	= ON CENTER	SSMH	= SANITARY SEWER MANHOLE
CDF	= CONTROLLED DENSITY FILL	FT/FT	= FEET PER FOOT	PVMNT	= PAVEMENT	STA	= STATION
©	= CLASS, CENTERLINE	GÁLV	= GALVANIZED	PC	= POINT OF CURVATURE	STD	= STANDARD
CMP	= CORRUGATED METAL PIPE	GRVL	= GRAVEL	PCC	= POINT OF COMPOUND CURVATURE,	SW	= SOUTHWEST
CMU	= CONCRETE MASONRY UNIT	GV	= GATE VALVE		PORTLAND CEMENT CONCRETE	TEL	= TELEPHONE
COMP	= COMPACTED	HDPE	= HIGH DENSITY POLYETHYLENE	PED	= PEDESTAL	TL	= TRAFFIC LOOP
CON	= CONIFER	HMA	= HOT MIX ASPHALT	POC	= POINT ON CURVE	TYP	= TYPICAL
CONC	= CONCRETE	HP	= HIGH POINT	POSS	= POSSIBLE	UP	= UTILITY POLE
CONT	= CONTOUR	HYD	= HYDRANT	PRC	= POINT OF REVERSE CURVE	UTIL	= UTILITY
CPSSP	= CORRUGATED POLYETHYLENE	IE, INV	= INVERT ELEVATION	PROP	= PROPOSED	VC	= VERTICAL CURVE
	STORM SEWER PIPE	ĪW	= INJECTION WELL	PT	= POINT OF TANGENCY	VLT	= VAULT
CULV	= CULVERT	L	= LENGTH	PVC	= POLYVINYL CHLORIDE	VPC	= VERTICAL POINT OF CURVATURE
D/W	= DRIVEWAY	LDCS	= LANDSCAPING	PVI	= POINT OF VERTICAL INTERSECTION	VPI	= VERTICAL POINT OF INTERSECTION
DEC	= DECIDUOUS	LF	= LINEAR FEET	PWR	= POWER	VPT	= VERTICAL POINT OF TANGENCY
DI	= DUCTILE IRON	LOC	= LOCATION	R	= RADIUS	W	= WEST
E.	= EAST	LP	= LOW POINT	R&C	= RING AND COVER	WM	= WATER METER
EOP, EP	= EDGE OF PAVEMENT	LT	= LEFT	RET	= RETAINING	WSDOT	= WASHINGTON STATE DEPARTMENT
EQUIV	= EQUIVALENT	MAX	= MAXIMUM	ROW	= RIGHT OF WAY		OF TRANSPORTATION
EVCE	= END VERTICAL CURVE ELEVATION	MIN	= MINIMUM	RT	= RIGHT	XEOA	= EXISTING EDGE OF ASPHALT

NOTES

1. FIELD WORK PERFORMED BY LARRY STEELE AND ASSOCIATES, INC., BELLINGHAM, WA. TOPOGRAPHIC SURVEY PERFORMED IN JULY, 2016. 2. HORIZONTAL DATUM: BASIS OF BEARING IS NAD 83/11, WASHINGTON STATE PLANE NORTH ZONE, DERIVED FROM CONVENTIONAL SURVEY METHOD TIED TO WSDOT SURVEY CONTROL POINTS GP29020-55 AND W327, VERTICAL DATUM: NAVD 88 HOLDING THE PUBLISHED ELEVATION FROM WSDOT SURVEY CONTROL POINT GP29020-55

RWG CHECKED BY LP

LEGEND

PROPOSED

EXISTING	<u>LEGEND</u>
TB TB	= EXISTING TOP OF BANK
— — — ВВ — — — ВВ —	
	= EXISTING DITCH &
	= EXISTING GRADE BREAK = EXISTING MAJOR CONTOUR
	= EXISTING MINOR CONTOUR
	= EXISTING GUARDRAIL
XXXX	= EXISTING FENCE = EXISTING GRAVEL
	= EXISTING WALL
'/////////////	= EXISTING BUILDING
	= EXISTING PROPERTY BOUNDARY = EXISTING RIGHT OF WAY
	= EXISTING RIGHT OF WAY &
	= EXISTING EASEMENT
	= EXISTING ROAD € = EXISTING WETLANDS BOUNDARY
	= EXISTING TRAFFIC STRIPING
	= EXISTING EDGE OF PAVEMENT
	= EXISTING FLOWLINE = EXISTING TOP BACK OF CURB
	= EXISTING SIDEWALK
— — — — UGP— — — — UGP—	
— — — — — — — — — — — — — — — — — — —	= EXISTING OVERHEAD POWER = EXISTING COMMUNICATIONS BURIED
	= EXISTING OVERHEAD COMMUNICATIONS
—————F0———F0——	
ccc	
	= EXISTING GAS MAIN
— W W W W W	
	= EXISTING TARIGATION LINE = EXISTING SANITARY SEWER FORCE MAIN
——————————————————————————————————————	= EXISTING SANITARY SEWER
——————————————————————————————————————	
> OHW	= EXISTING ORDINARY HIGH WATER = EXISTING CULVERT
~~~~~~~~~~~~~~~~~~~~~~~~~~~~~~~~~~~~~~~	= EXISTING TREE LINE
	= EXISTING CONCRETE
	= EXISTING RR TRACKS
	= EXISTING SIGNAL POLE  = EXISTING SIGNAL POLE W/ LUMINARE
→————————————————————————————————————	= EXISTING STREET LIGHT ASSEMBLY
X .	= EXISTING YARD LIGHT
	= EXISTING GUY WIRE = EXISTING GAS METER
$\bowtie$	= EXISTING GAS VALVE
	= EXISTING TRANSFORMER PAD
P	= EXISTING POWER VAULT = EXISTING JBOX
<u> </u>	= EXISTING SOIL BORING LOCATION
MB□ 	= EXISTING MAIL BOX
<b>"</b> Ŷ	= EXISTING WATER SPIGOT = EXISTING WATER BLOW OFF
	= EXISTING WATER METER
$\bowtie$	= EXISTING WATER VALVE = EXISTING FIRE HYDRANT
$\boxtimes$	= EXISTING TRAFFIC SIGNAL VAULT
	= EXISTING SEWER MANHOLE
	= EXISTING STORM DRAIN CATCH BASIN TYPE I  = EXISTING STORM DRAIN CATCH BASIN TYPE II
\(\rangle\)	= EXISTING UTILITY POLE
<b>*</b>	= EXISTING MONITORING WELL
0	= EXISTING STORM CLEANOUT = EXISTING SEWER CLEANOUT
П	= EXISTING SIGN
	= EXISTING TELEPHONE PEDESTAL
<u> </u>	= EXISTING COMMUNICATIONS VAULT = EXISTING BENCH MARK
<del>♦</del> <b>※</b>	= EXISTING BENCH MARK  = EXISTING NAIL AND SHINER
0	= EXISTING IRON PIPE
⊕ <b>⊚</b>	= EXISTING MONUMENT (IN CASE) = EXISTING MONUMENT (SURFACE)
Δ	= EXISTING MONUMENT (SURFACE)  = EXISTING ANGLE POINT
<u>©</u>	= EXISTING TREE STUMP
(0)	= EXISTING TREE = EXISTING VEGETATION

<u> —  —  — тв —  — тв —</u>	= PROPOSED TOP OF BANK
— — — BB — — — BB —	= PROPOSED TOE OF BANK
<u> </u>	- · · · · · · · · · · · · · · · ·
	= PROPOSED GRADE BREAK
95	= PROPOSED MAJOR CONTOUR
	= PROPOSED MINOR CONTOUR
	= PROPOSED GUARDRAIL
xxx	= PROPOSED FENCE
	= PROPOSED GRAVEL
	= PROPOSED WALL
<i>/////////////////////////////////////</i>	= PROPOSED BUILDING
	= PROPOSED PAVEMENT VALLEY
	= PROPOSED RIGHT OF WAY
	= PROPOSED AUTOTURN
	= PROPOSED CONSTRUCTION EASEMENT
	= PROPOSED ROAD &
	= PROPOSED SAWCUT
	= PROPOSED TRAFFIC STRIPE = PROPOSED ROAD EDGE OF PAVEMENT
	= PROPOSED ROAD EDGE OF PAVEMENT = PROPOSED CURB AND GUTTER
	= PROPOSED SIDEWALK
PR	
·	
	= PROPOSED PARKING STRIPE
	= PROPOSED TRAFFIC SIGNAL CONDUCTOR
· <del>-</del>	= PROPOSED FIBER OPTICS
xxx	
	= PROPOSED CONDUIT
	= PROPOSED HANDRAIL
IRR	= PROPOSED IRRIGATION LINE
w	= PROPOSED WATER MAIN
FM	= PROPOSED SANITARY SEWER FORCE MAIN
ss	= PROPOSED SANITARY SEWER
SD	= PROPOSED STORM DRAIN
××	= PROPOSED CULVERT
	= PROPOSED TREE LINE
	= PROPOSED CONC. SIDEWALK/DRIVEWAY
	= PROPOSED INFILTRATION TRENCH
	= PROPOSED INFILTRATION FILTER MEDIA
	= PROPOSED GRIND
	= PROPOSED DEMOLITION AREA
	= PROPOSED ASPHALT
	= PROPOSED RIGHT OF WAY TAKE
	= PROPOSED STORM DRAIN INLET
#	= PROPOSED COUPLER
	= PROPOSED WATER METER
MX	= PROPOSED WATER VALVE
	= PROPOSED STORM DRAIN CATCH BASIN TYPE II
	= PROPOSED SANITARY SEWER MANHOLE
	= PROPOSED STORM DRAIN CATCH BASIN TYPE I
<del></del>	= PROPOSED HYDRANT
<b>+</b>	= PROPOSED UTILITY POLE
	= PROPOSED JBOX (TYPE I, II, III)
<b>•</b>	= PROPOSED MONITORING WELL
•	= PROP STORM CLEANOUT = PROPOSED SANITARY SEWER CLEAN OUT
•	= PROPOSED SANITARY SEWER CLEAN OUT = PROPOSED SIGN
<b>.</b>	= PROPOSED SIGN = FLOW ARROW
<b>\( \sqrt{\sqrt{\sqrt{\sqrt{\sqrt{\sqrt{\sqrt{\sqrt{\sqrt{\sqrt{\sqrt{\sqrt{\sqrt{\sqrt{\sqrt{\sqrt{\sqrt{\sqrt{\sqrt{\sqrt{\sqrt{\sqrt{\sqrt{\sqrt{\sqrt{\sqrt{\sqrt{\sqrt{\sqrt{\sqrt{\sqrt{\sqrt{\sqrt{\sqrt{\sqrt{\sqrt{\sqrt{\sqrt{\sqrt{\sqrt{\sqrt{\sqrt{\sqrt{\sqrt{\sqrt{\sqrt{\sqrt{\sqrt{\sqrt{\sqrt{\sqrt{\sqrt{\sqrt{\sqrt{\sqrt{\sqrt{\sqrt{\sqrt{\sqrt{\sqrt{\sqrt{\sqrt{\sqrt{\sqrt{\sqrt{\sqrt{\sqrt{\sqrt{\sqrt{\sqrt{\sqrt{\sqrt{\sqrt{\sqrt{\sqrt{\sqrt{\sqrt{\sqrt{\sqrt{\sqrt{\sqrt{\sqrt{\sqrt{\sqrt{\sqrt{\sqrt{\sqrt{\sqrt{\sqrt{\sqrt{\sqrt{\sqrt{\sqrt{\sqrt{\sqrt{\sqrt{\sqrt{\sqrt{\sqrt{\sqrt{\sqrt{\sqrt{\sqrt{\sqrt{\sqrt{\sqrt{\sqrt{\sqrt{\sqrt{\sqrt{\sqrt{\sqrt{\sqrt{\sqrt{\sqrt{\sqrt{\sqrt{\sqrt{\sqrt{\sqrt{\sqrt{\sqrt{\sqrt{\sqrt{\sqrt{\sqrt{\sqrt{\sqrt{\sqrt{\sqrt{\sqrt{\sqrt{\sqrt{\sqrt{\sqrt{\sqrt{\sqrt{\sqrt{\sqrt{\sqrt{\sqrt{\sqrt{\sqrt{\sqrt{\sqrt{\sqrt{\sqrt{\sqrt{\sqrt{\sqrt{\sqrt{\sqrt{\sqrt{\sqrt{\sqrt{\sqrt{\sqrt{\sqrt{\sqrt{\sqrt{\sqrt{\sqrt{\sqrt{\sqrt{\sqrt{\sqrt{\sqrt{\sqrt{\sqrt{\sqrt{\sqrt{\sqrt{\sqrt{\sqrt{\sqrt{\sqrt{\sqrt{\sqrt{\sqrt{\sqrt{\sqrt{\sqrt{\sqrt{\sqrt{\sqrt{\sqrt{\sqrt{\sqrt{\sqrt{\sqrt{\sqrt{\sqrt{\sqrt{\sqrt{\sqrt{\sqrt{\sqrt{\sqrt{\sqrt{\sqrt{\sqrt{\sq}}\sqrt{\sqrt{\sqrt{\sqrt{\sqrt{\sqrt{\sqrt{\sqrt{\sqrt{\sqrt{\sqrt{\sqrt{\sqrt{\sqrt{\sqrt{\sqrt{\sqrt{\sqrt{\sqrt{\sqrt{\sqrt{\sqrt{\sqrt{\sqrt{\sqrt{\sqrt{\sqrt{\sqrt{\sqrt{\sqrt{\sqrt{\sqrt{\sqrt{\sqrt{\sqrt{\sqrt{\sqrt{\sqrt{\sqrt{\sqrt{\sqrt{\sqrt{\sqrt{\sqrt{\sqrt{\sqrt{\sqrt{\sqrt{\sqrt{\sqrt{\sqrt{\sqrt{\sqrt{\sqrt{\sqrt{\sqrt{\sqrt{\sqrt{\sqrt{\sqrt{\sqrt{\sqrt{\sqrt{\sqrt{\sqrt{\sqrt{\sqrt{\sqrt{\sqrt{\sqrt{\sqrt{\sqrt{\sqrt{\sqrt{\sqrt{\sqrt{\sqrt{\sqrt{\sqrt{\sqrt{\sqrt{\sqrt{\sqrt{\sqrt{\sqrt{\sqrt{\sqrt{\sqrt{\sq}}}}}}}}}}}}}}}}}}}}}}}}}}}}}}}}}}}}</b>	= FLOW ARROW = PROPOSED TREE
0	- FROFOGED IREE
—DETAIL NUMBER	
DET	0507011 11171
SHIX -	= SECTION MARK
SHEET	
NUMBER	



D&F	Reichhardt & E
Work.	ENGINEERING INC
P.O. Box 978   42	3 Front Street, Lynden, WA 98

Ebe P.O. Box 978 | 423 Front Street, Lynden, WA 98264 (360) 354-3687 813 Metcalf Street, Sedro-Woolley, WA 98284 (360) 855-1713 DATE

DESCRIPTION

CITY OF FERNDALE 2095 MAIN ST FERNDALE, WA 98248

PORTAL WAY / I-5 ROUNDABOUT IMPROVEMENTS LEGEND AND ABBREVIATIONS

^{DwG} 16033 C
JOB#
16033

16033 COVER 12/17/2018 H: **N/A** V: **N/A** of 20

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0
1

SIGN SPACING = X (1)						
RURAL ROADS & URBAN ARTERIALS	35 / 40 MPH	350' ±				
RURAL ROADS, URBAN ARTERIALS, RESIDENTIAL & BUSINESS DISTRICTS	25 / 30 MPH	200' ± (2)				
URBAN STREETS	25 MPH OR LESS	100' ± (2)				


(1) ALL SPACING MAY BE ADJUSTED TO ACCOMMODATE INTERSECTIONS AND DRIVEWAYS. (2) THIS SPACING MAY BE REDUCED IN URBAN AREAS TO FIT ROADWAY CONDITIONS.

	MINIMUM SHOULDER TAPER LENGTH = L/3 (feet)									
SHOULDER WIDTH										
(feet)	25	30	35	40	45	50	55	60	65	70
8'	40	40	60	90	-	-	-	-	-	-
10'	40	60	90	90	-	-	-	-	-	-
	USE A 3 DEVICES TAPER FOR SHOULDERS LESS THEN 8'									

CHANNELIZATION DEVICE SPACING (feet)						
MPH	TAPER	TANGENT				
35/40	30	60				
25/30	20	40				

BUFFER DATA											
	LONGITUDINAL BUFFER SPACE = B										
SPEED (MP	H)	25	30	35	40	45	50	55	60	65	70
LENGTH (fe	et)	155	200	250	305	360	425	495	570	645	730
TRANSP	TRANSPORTABLE ATTENUATOR ROLL AHEAD DISTANCE = R										
		E WEIG				ŀ		EHICLE 22,000		IT	
< 45 MPH	45-55	MPH	> 5	> 55 MPH < 45 MPH				45-55 MPH		> 55 MPH	
100'	123'		172'			74'		100'		150'	
PROTECTIVE VEHICLE (WORK VEHICLE) = R											
	NO SPECIFIED DISTANCE REQUIRED										

NOT TO SCALE

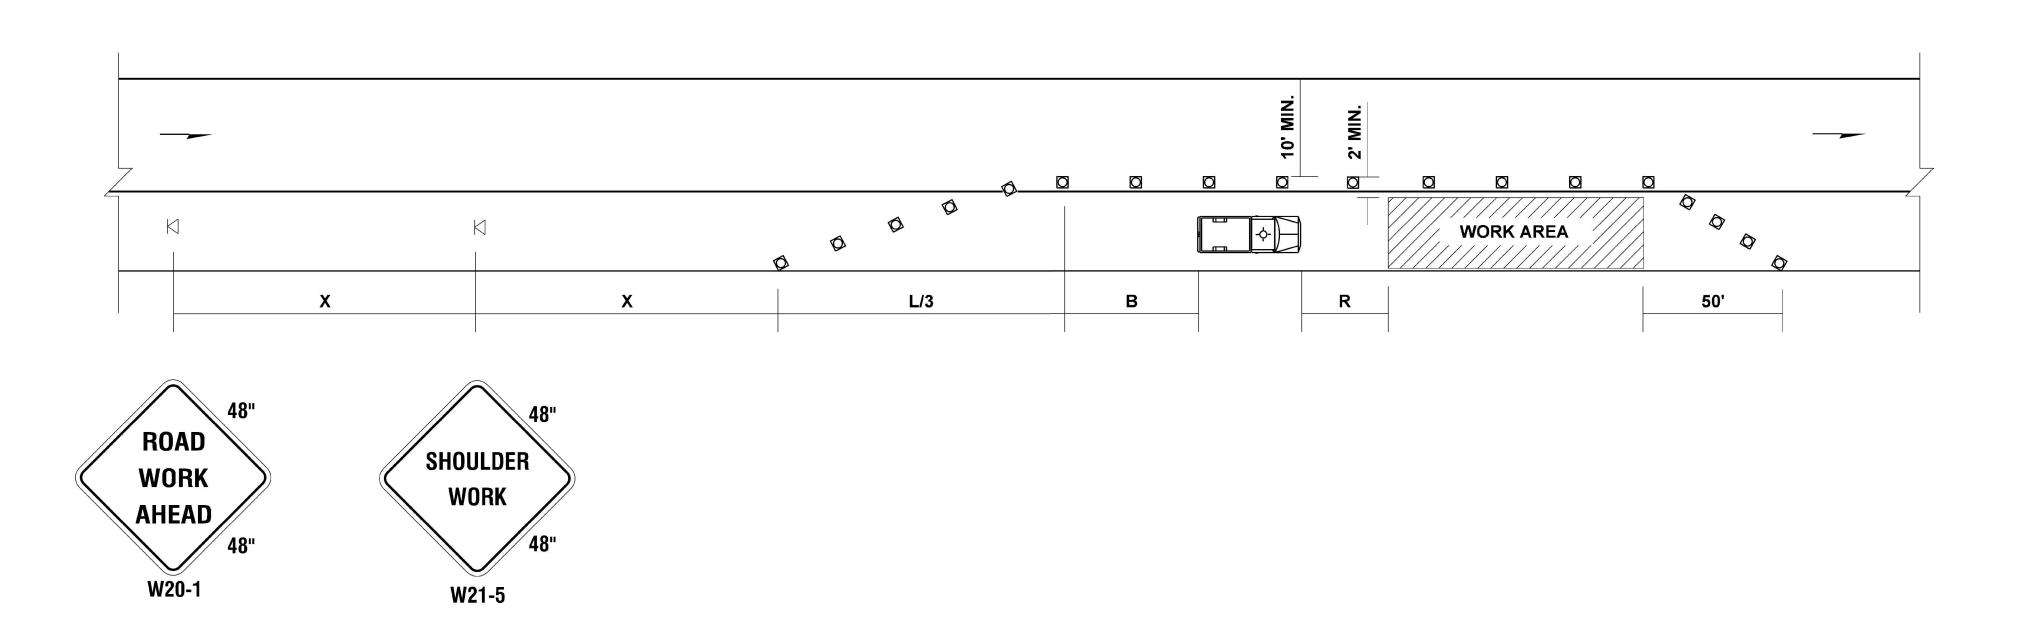

### **LEGEND**

- SIGN LOCATION
- CHANNELIZING DEVICES TRAFFIC SAFETY DRUMS. TYPE C STEADY BURN WARNING LIGHTS REQUIRED DURING HOURS OF DARKNESS.



PROTECTIVE VEHICLE


# PHASE 1 SHOULDER WIDENING **SHOULDER CLOSURE - LOW SPEED**

(40 MPH OR LESS)

**NOT TO SCALE** 

#### NOTES:

- 1. DEVICE SPACING FOR THE DOWNSTREAM TAPER SHALL BE 20' (F)
- 2. ALL SIGNS ARE BLACK ON ORANGE.

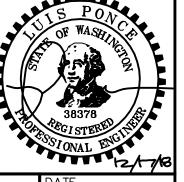

SUBMITTED WITH **DESIGN PLAN** 

ED BY	ſ
BY RWG	٦L
ED BY	P.C
ΙP	<b>I</b> 813

Reichhardt & Ebe ENGINEERING INC


P.O. Box 978 | 423 Front Street, Lynden, WA 98264 (360) 354-3687 313 Metcalf Street, Sedro-Woolley, WA 98284 (360) 855-1713


DESCRIPTION


CITY OF FERNDALE 2095 MAIN ST FERNDALE, WA 98248

PORTAL WAY / I-5 ROUNDABOUT IMPROVEMENTS WSDOT TYPICAL SHOULDER CLOSURE


WG 16033 TC PLAN 12/17/2018 v: **N/A** 16033 of 20

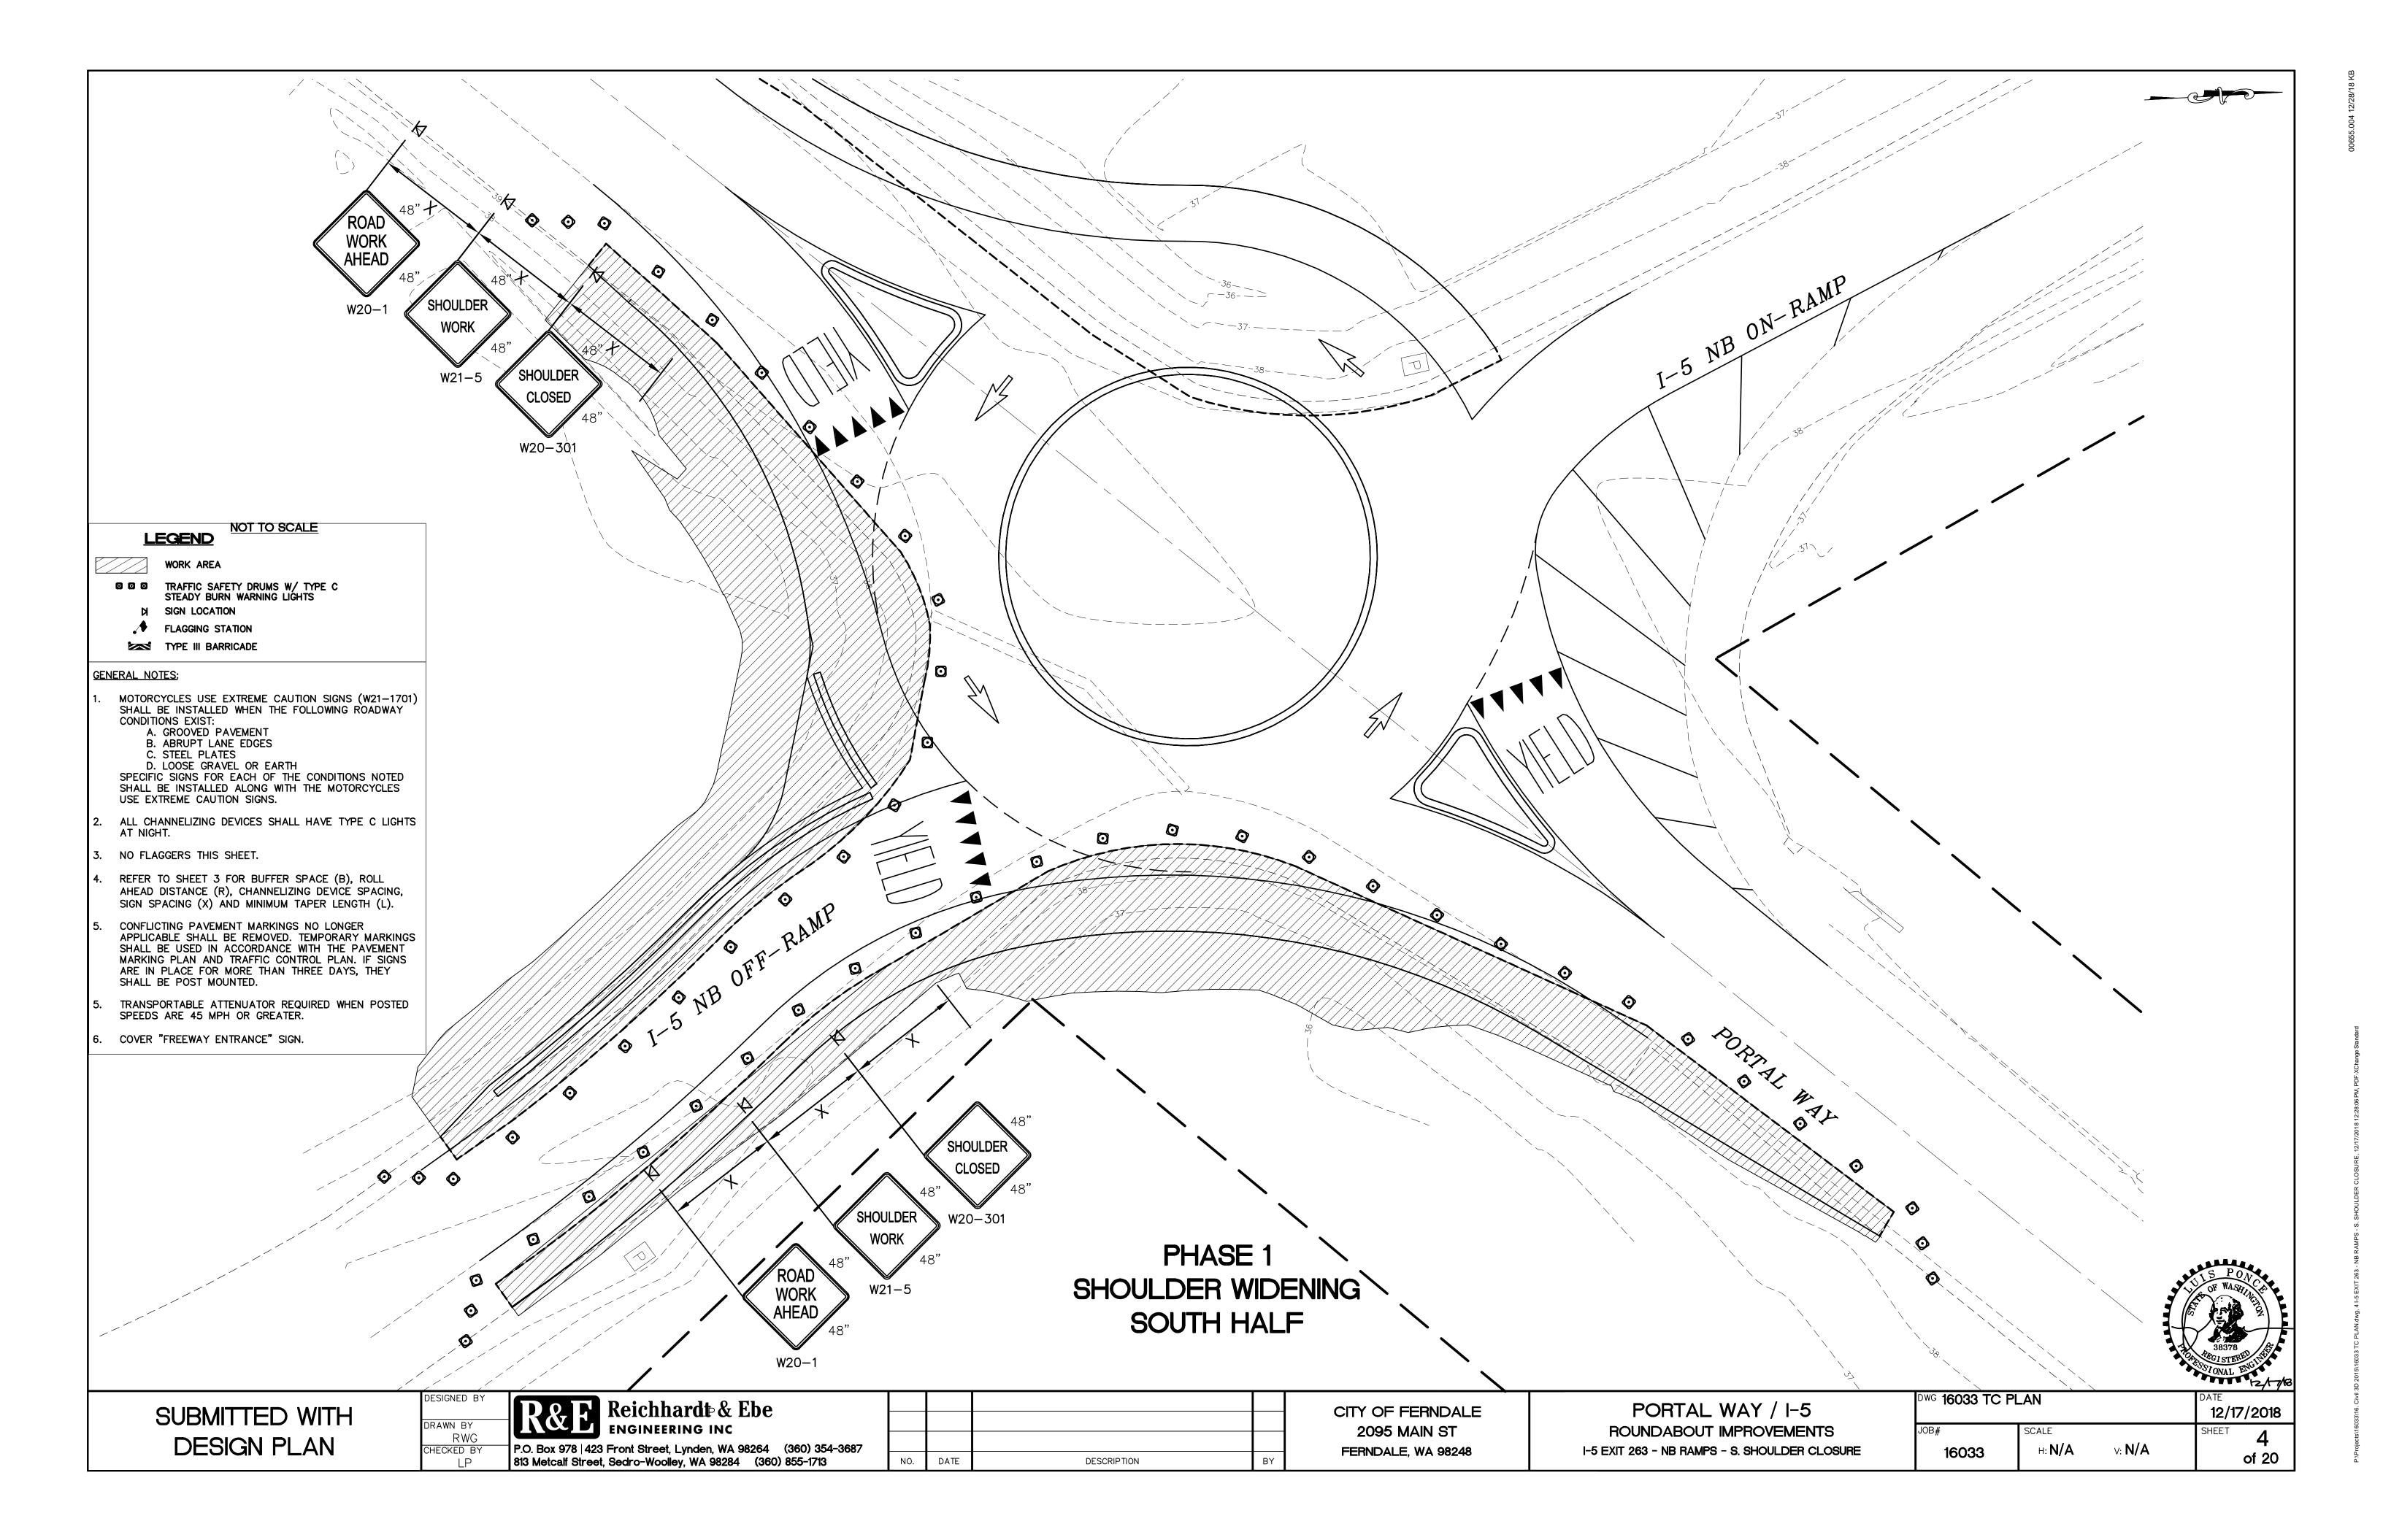

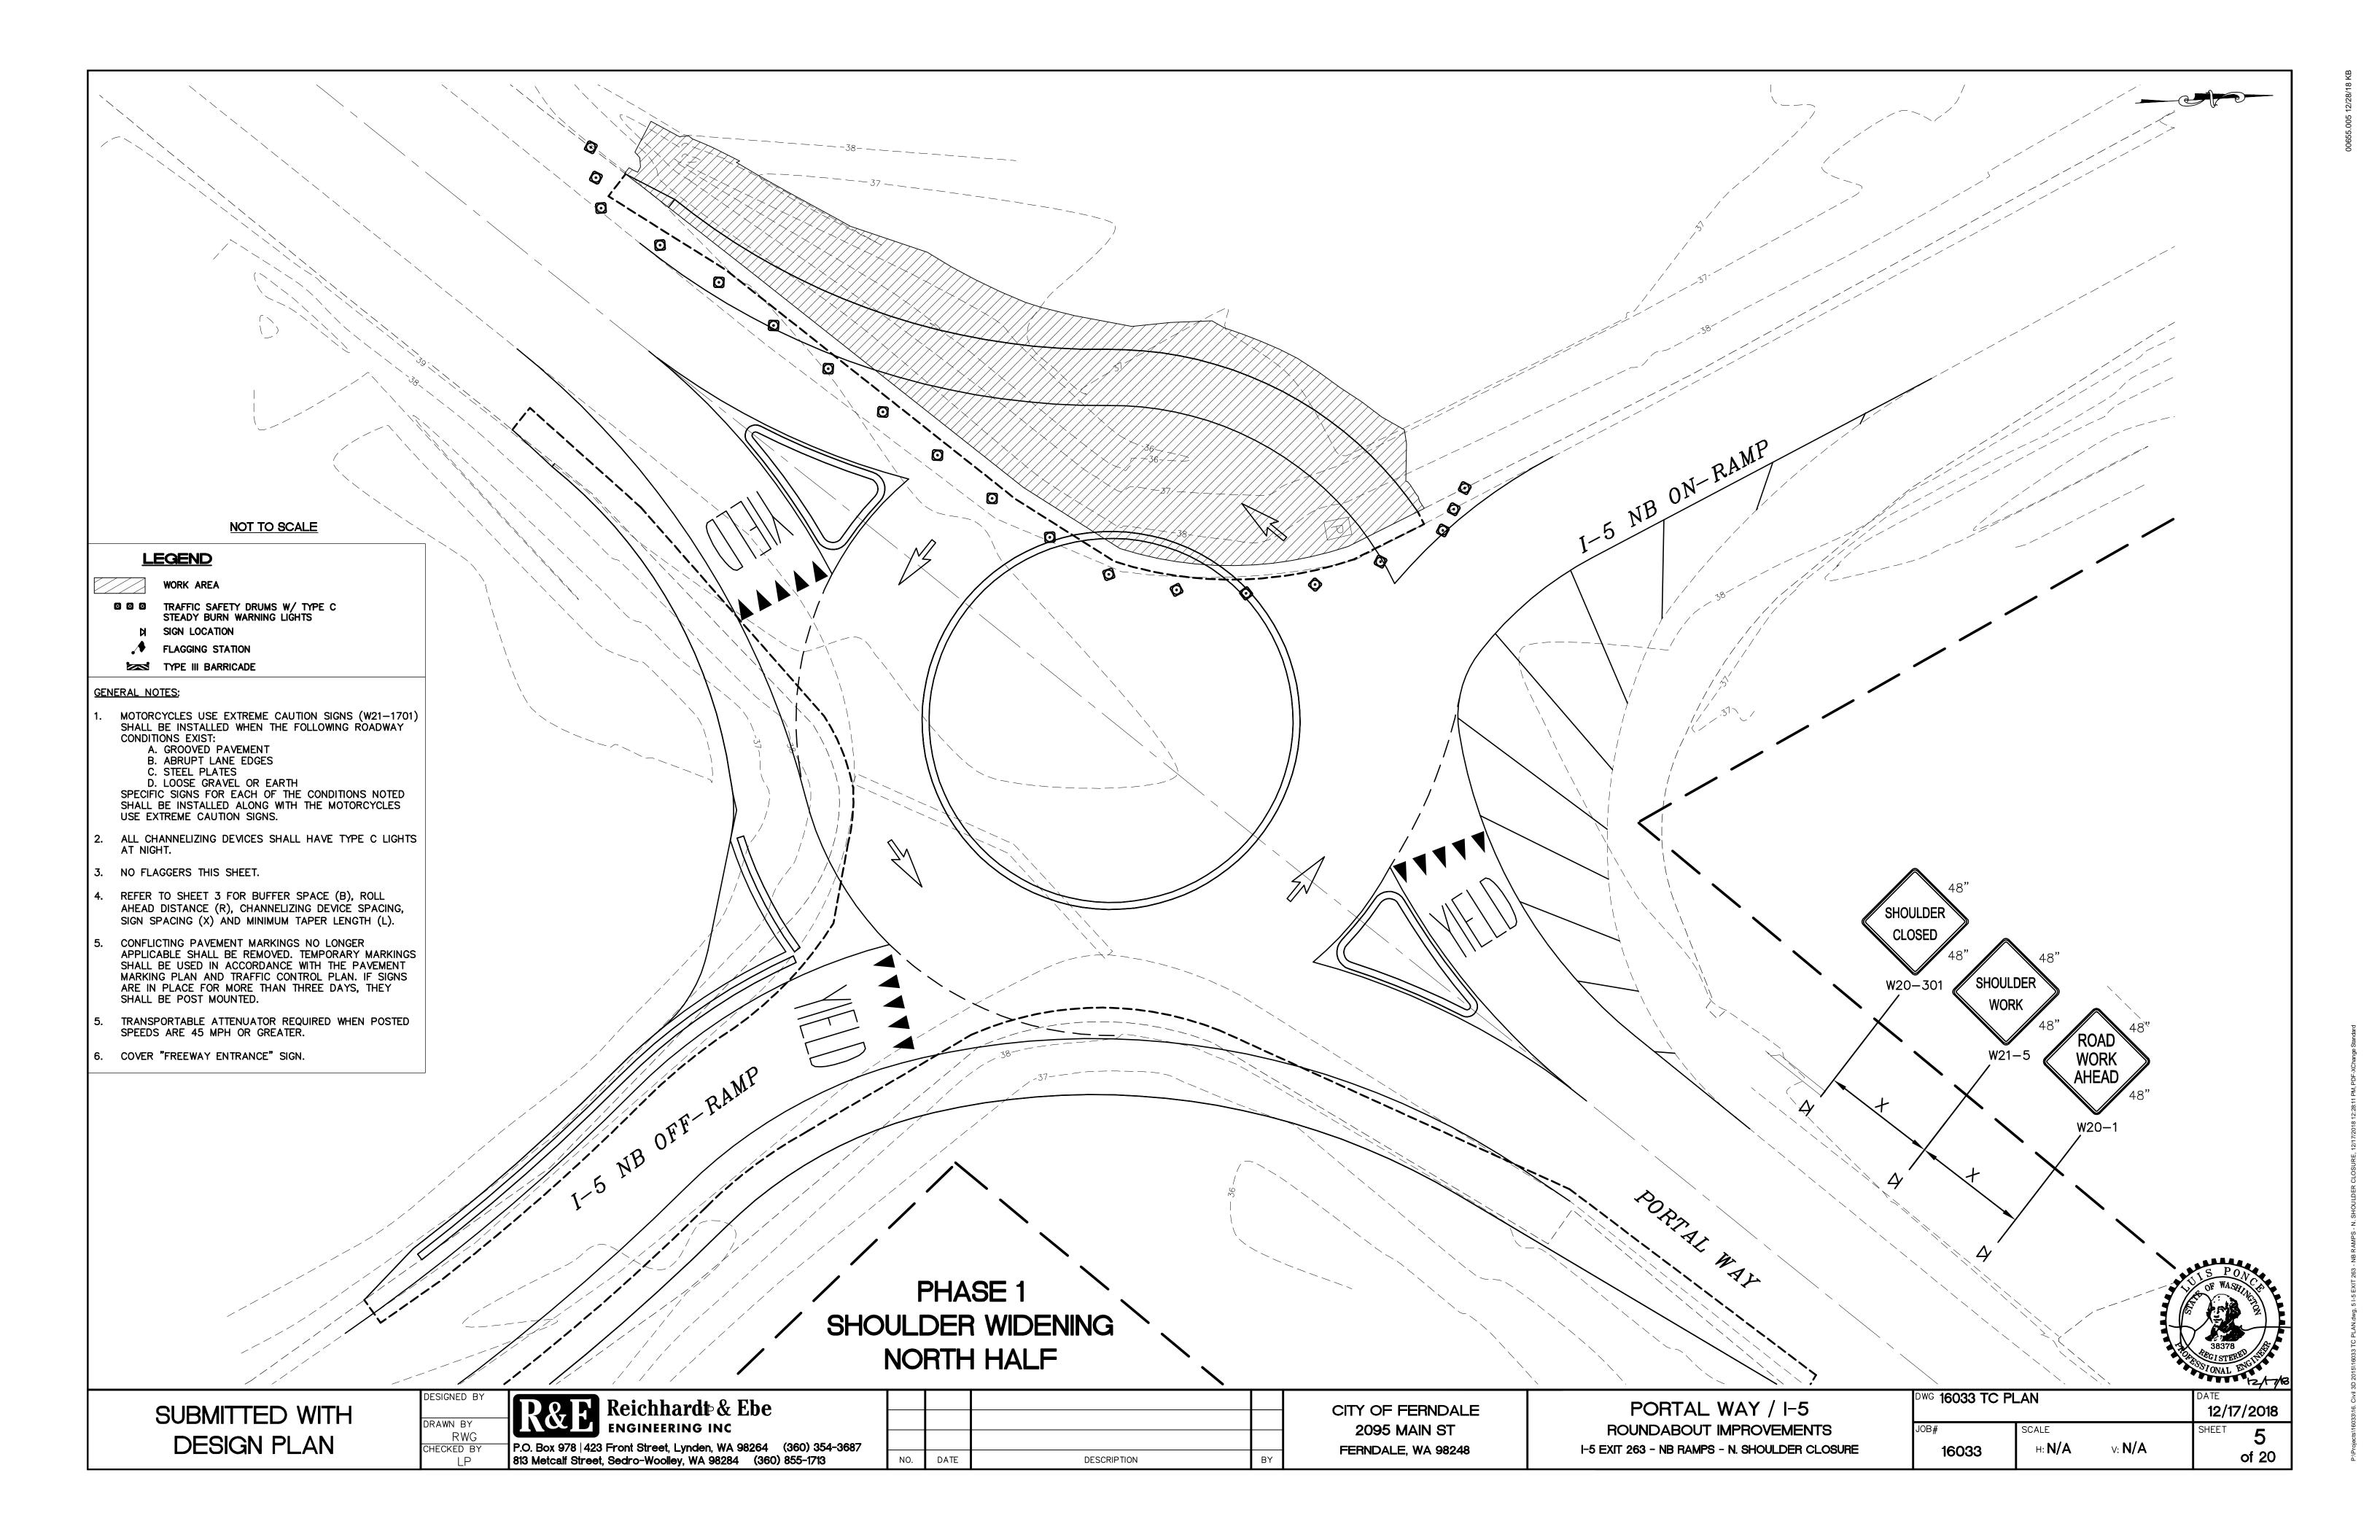

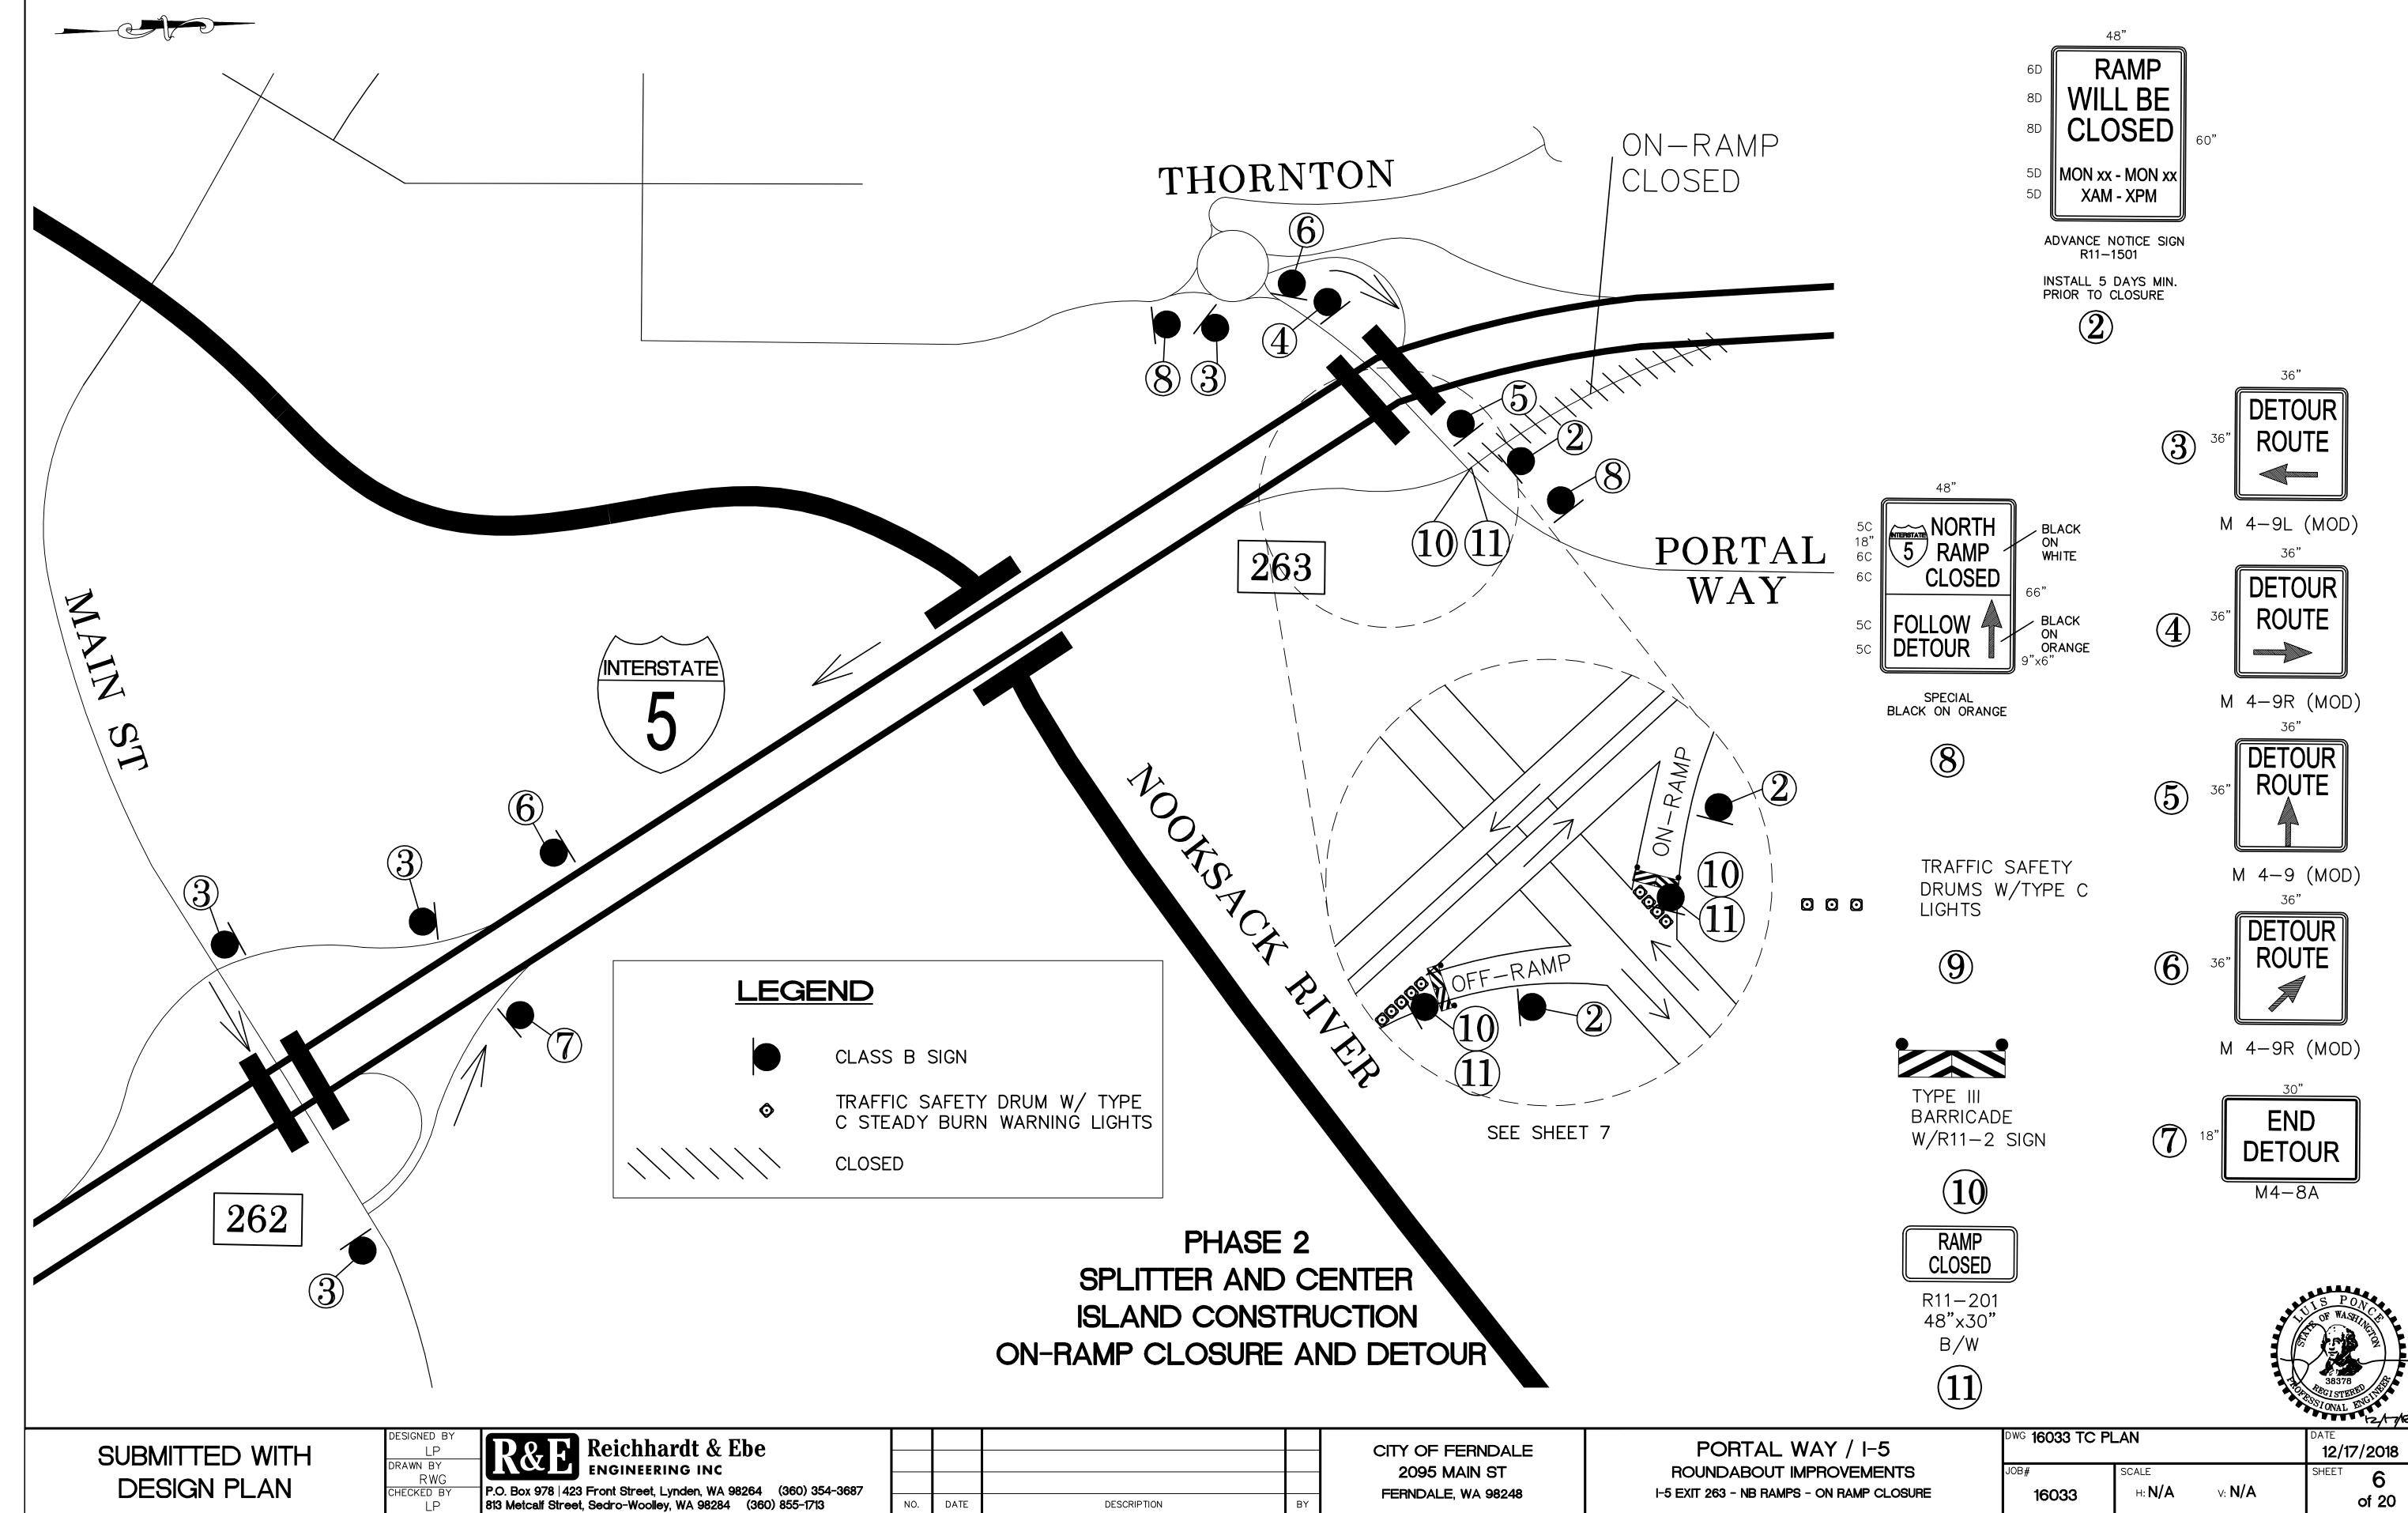



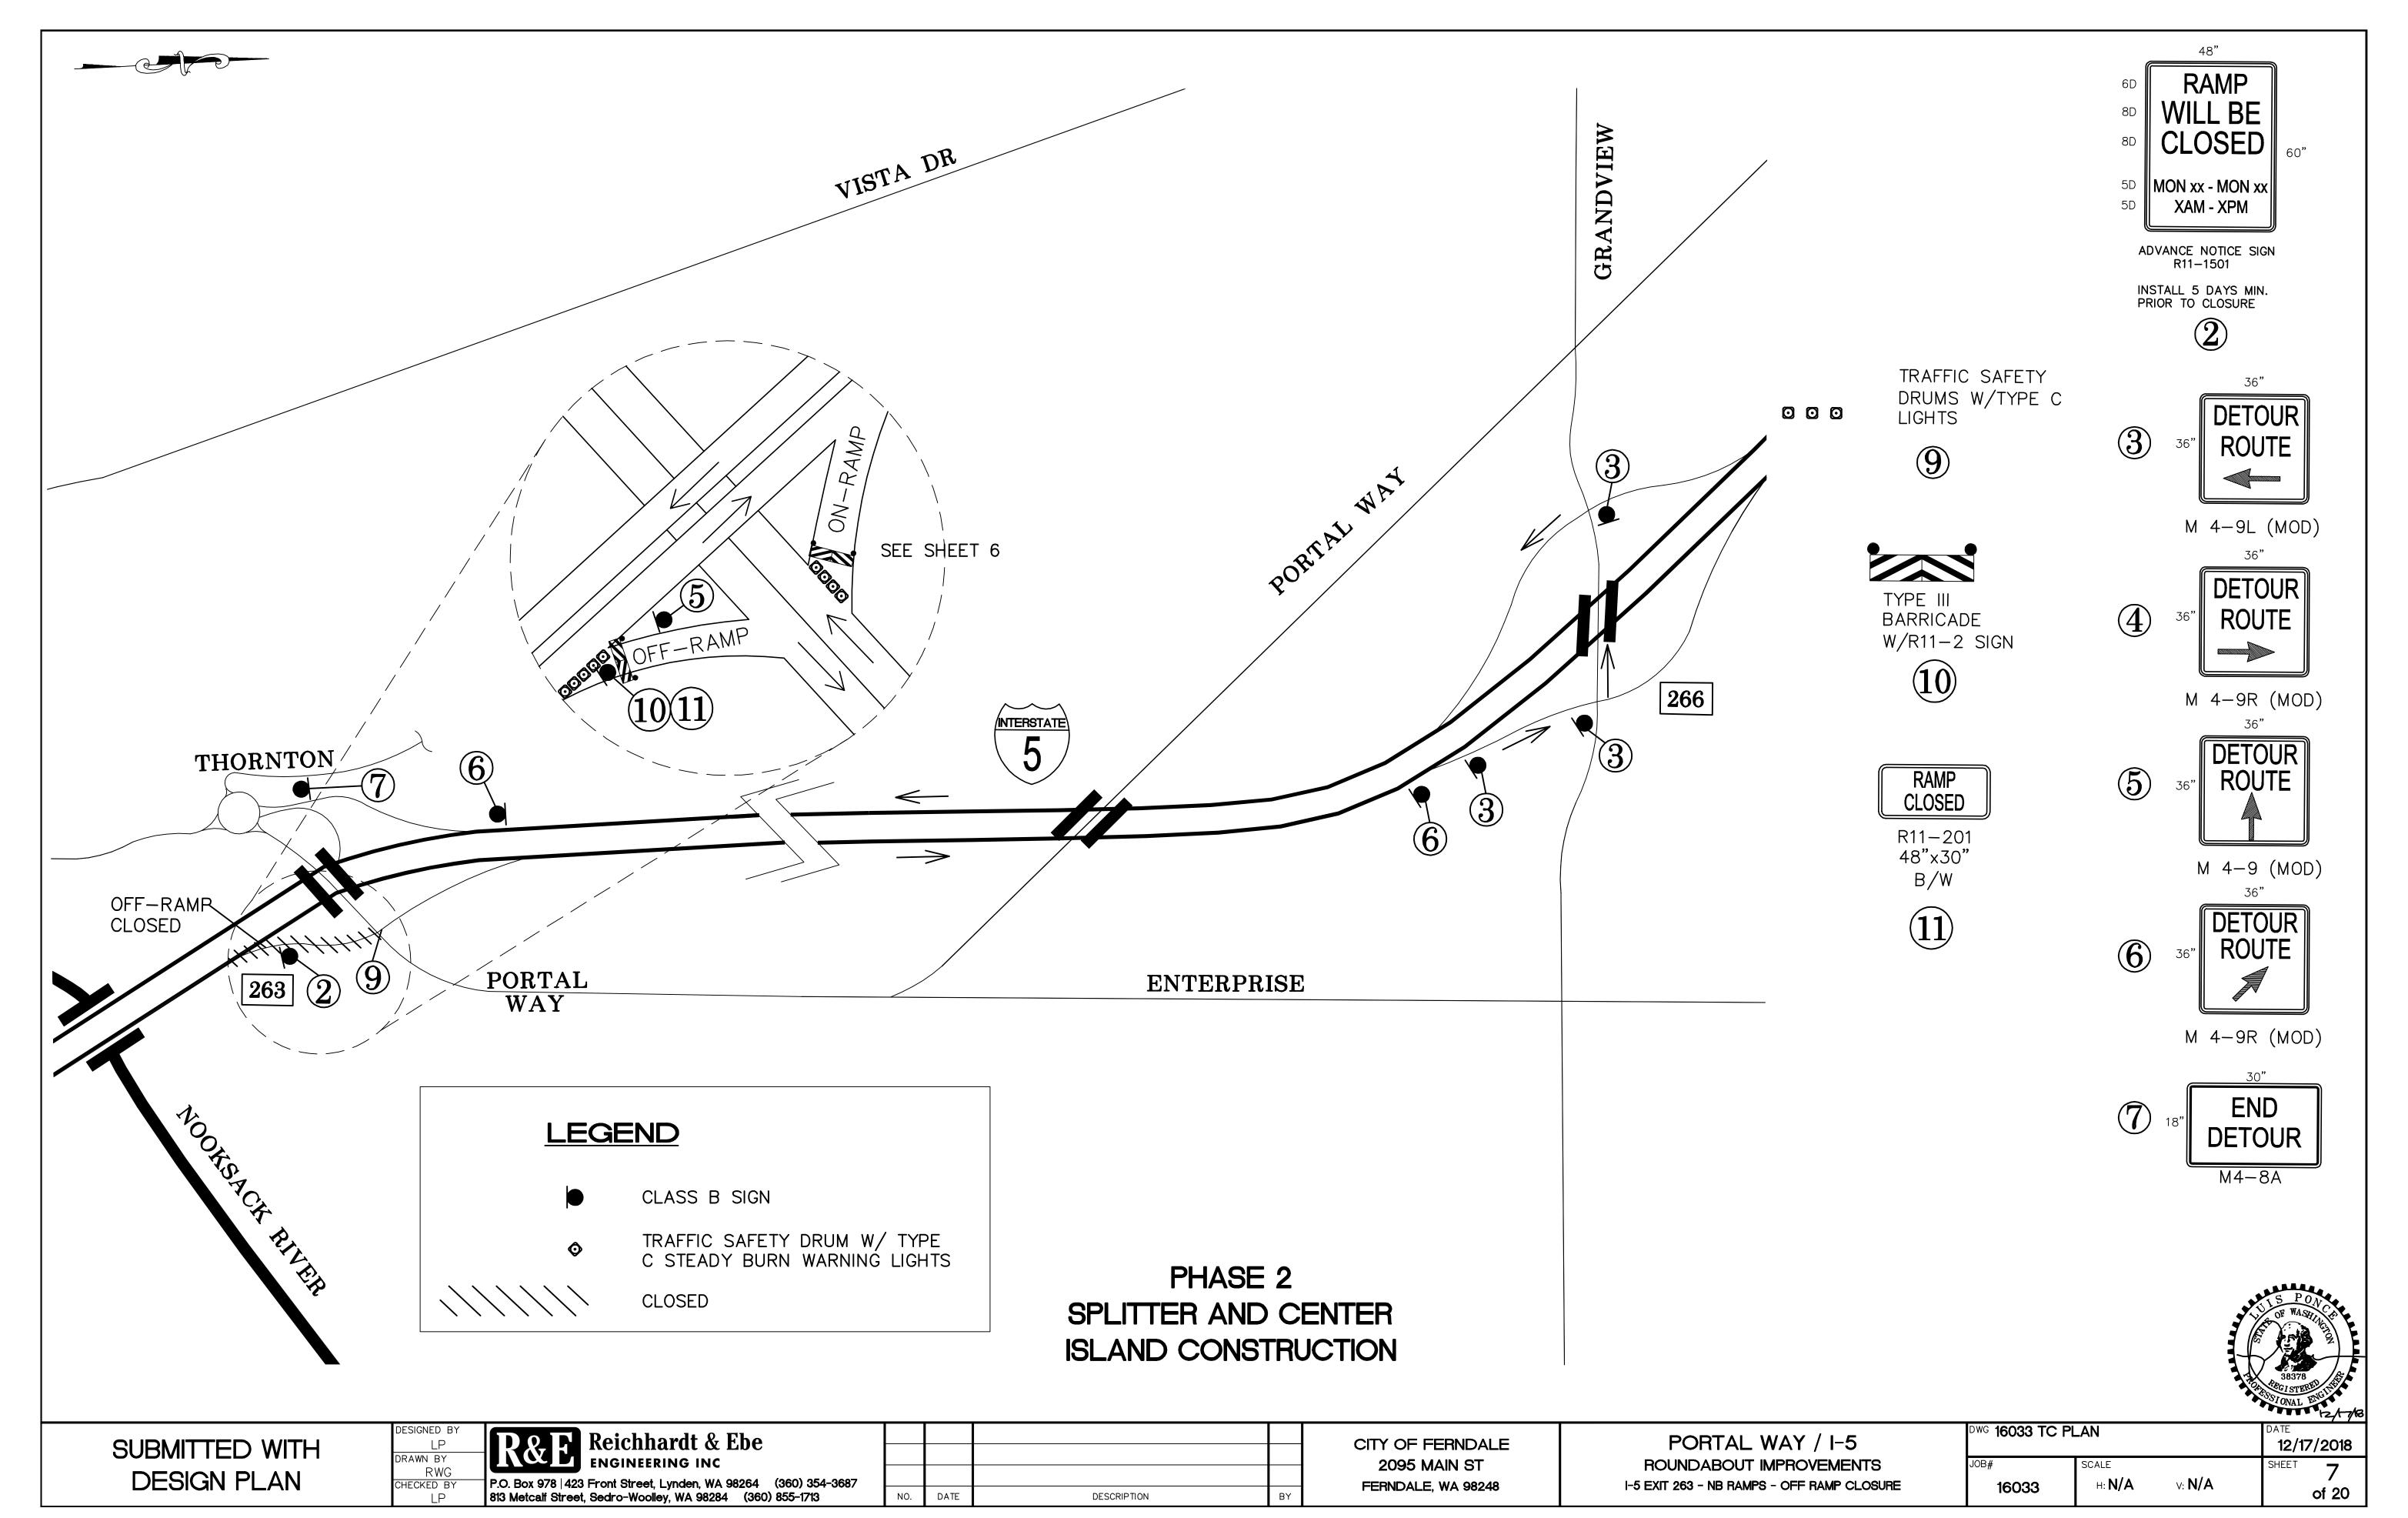

IS\16033\16. Civil 3D 2015\16033 TC PLAN.dwg, 7 I-5 EXIT 263 - NB RAMPS - OFF RAMP CLOSURE, 12/17/2018 12:28:22 PM, PDF-XChange S



SIGN LOCATION (CLASS B)

SIGN LOCATION (CLASS A)

SIGN LOCATION - TRIPOD MOUNTED

OR 000 TRAFFIC SAFETY DRUMS WITH TYPE C LIGHTS


PCMS PORTABLE CHANGEABLE MESSAGE SIGN

CHANNELIZING DEVICE SPACING (FEET)						
MPH	TAPER	TANGENT				
50/65 35/45	40	80				
35/45	30	60				
25/30	20	40				

PCN	<b>IS</b>
1	2
EXIT	USE
XXX	EXIT
CLOSED	XXX
2 SEC	2 SEC
FIELD LOCA PRIOR TO C	TE 1 MILE ± CLOSURE

	MAINII	N 41 1N 4	1 TAI	<u> </u>	LENI	OT1.	11.1		/. \	
LANG	MIINI	MUM	I TAF	FK	LEN	GIH	IN F	FFI	(L)	
LANE WIDTH (FEET)		POS	TED :	SPEE	D LIN	J TIN	MPH)	)		
WIDTH (FEET)	25	30	35	40	45	50	55	60	65	70
6	63	90	123	165	270	300	330	360	390	420
8	84		162							
10	105	150	204	270	450	500	550	600	650	700
11	115	165	225	295	495	550	605	660	715	770
12	125	180	245	320	540	600	660	720	780	840
3 DEVICES MINIMUM SPACED 10' O.C. IN TAPERS FOR										
SHOULDER WIDTHS LESS THAN 6 FEET										

NO FLAGGERS OR SPOTTERS

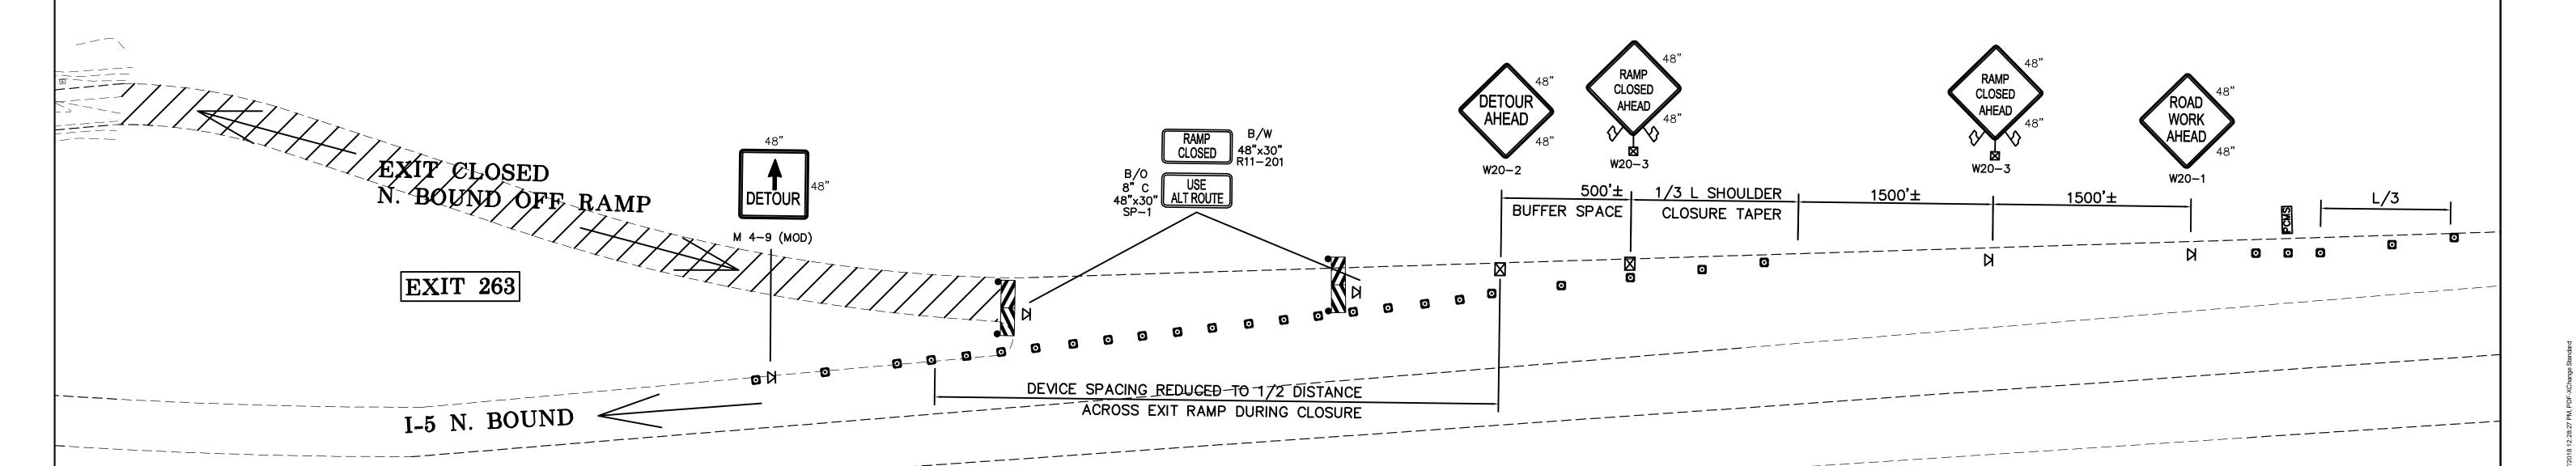

LP DRAWN BY

RWG

CHECKED BY

# PHASE 2 SPLITTER AND CENTER ISLAND CONSTRUCTION



SUBMITTED WITH DESIGN PLAN

R&E	Reich
P.O. Box 978   423	

nhardt & Ebe EERING INC eet, Lynden, WA 98264 (360) 354-3687 oolley, WA 98284 (360) 855-1713

CITY OF FERNDALE 2095 MAIN ST			
FERNDALE, WA 98248	BY	DESCRIPTION	DATE

PORTAL WAY / I-5 ROUNDABOUT IMPROVEMENTS I-5 EXIT 263 - NB RAMPS - OFF-RAMP SIGNAGE

033 TC PL	_AN		DATE 12/17	7/2018
6033	SCALE H: <b>N/A</b>	∨: <b>N/A</b>	SHEET	8 of 20

BUFFER DATA											
LONGITUDINAL BUFFER SPACE = B											
SPEED (MF	PH)	25	30	35	40	45	50	55	60	65	70
LENGTH (feet) 155		155	200	250	305	360	42	5 495	570	645	730
TRANSP	ORTAE	BLE A	TTEN	UATO	R RO	LL A	HEA	D DIS	TANCI	E = R	
	VEHICL 0 TO 2					ŀ	HOST	VEHIC > 22,0	LE WEI 00 lbs.	GHT	
< 45 MPH	45-55	MPH	> !	55 MPH	<	< 45 MPH 45-55 MPH			> 55 MPH		
100'	100' 123' 172'				74' 100'			0'	150'		
PROTECTIVE VEHICLE (WORK VEHICLE) = R											
NO SPECIFIED DISTANCE REQUIRED											


**ONE LANE** 

RWG

LP

CHECKED BY

-		
SIGN SPACING	= X (1)	
RURAL HIGHWAYS	60 / 65 MPH	800' ±
RURAL ROADS	45 / 55 MPH	500' ±
RURAL ROADS & URBAN ARTERIALS	35 / 40 MPH	350' ±
RURAL ROADS, URBAN ARTERIALS, RESIDENTIAL & BUSINESS DISTRICTS	25 / 30 MPH	200' ± (2)
URBAN STREETS	25 MPH OR LESS	100' ± (2)
(1) ALL SPACING MAY BE ADJUSTED TO INTERSECTIONS AND DRIVEWAYS.		ГІТ

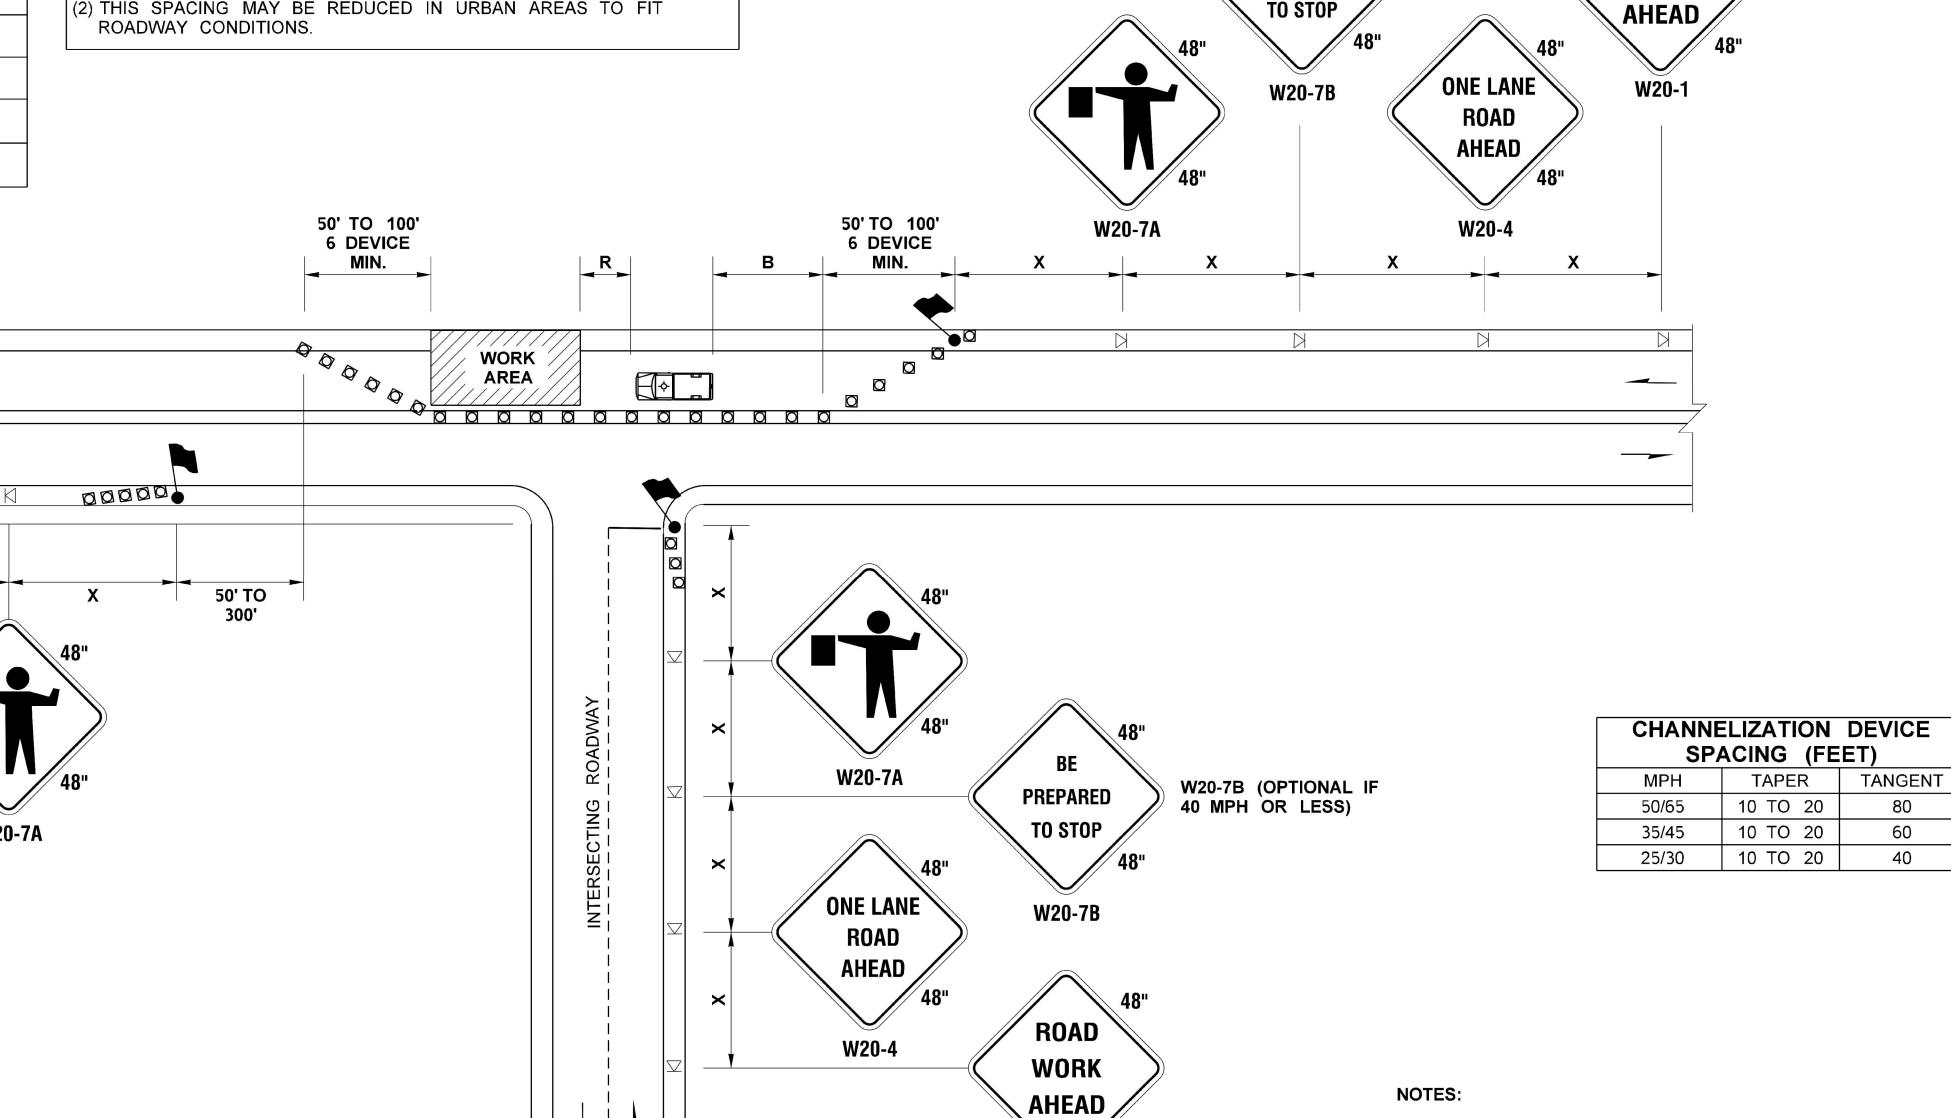

#### **LEGEND**

**ROAD** 

**WORK** 

**AHEAD** 

W20-1

SIGN LOCATION

NOT TO SCALE


PHASE 2 SPLITTER AND CENTER ISLAND CONSTRUCTION

# ONE-LANE, TWO-WAY TRAFFIC CONTROL WITH FLAGGERS

NOT TO SCALE

## 1 ALL SIGNS ARE BLACK ON ORANGE.

- 2. EXTENDING THE CHANNELIZING DEVICE TAPER ACROSS SHOULDER IS RECOMMENDED.
- 3. NIGHT WORK REQUIRES ADDITIONAL ROADWAY LIGHTING AT FLAGGING STATIONS. SEE THE STANDARD SPECIFICATIONS FOR ADDITIONAL DETAILS.
- 4. SEE SPECIAL PROVISIONS FOR WORK HOUR RESTRICTIONS.

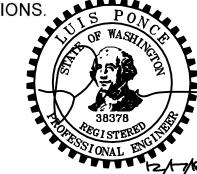

SUBMITTED WITH **DESIGN PLAN** 

Вοг	Raichhardt & F
K&L	Reichhardt & F
· ·	3 Front Street, Lynden, WA 96 t, Sedro-Woolley, WA 98284

**PREPARED** 

TO STOP

W20-7B

W20-7B (OPTIONAL IF 40 MPH OR LESS)

Ebe 98264 (360) 354-3687 (360) 855-1713

DESCRIPTION

CITY OF FERNDALE **2095 MAIN ST** FERNDALE, WA 98248


PORTAL WAY / I-5 ROUNDABOUT IMPROVEMENTS WSDOT TYPICAL LANE CLOSURE


W20-7B (OPTIONAL IF 40 MPH OR LESS)

**PREPARED** 

D33 TC PL	_AN		DATE <b>12/17</b>	7/2018
033	SCALE H: <b>N/A</b>	v: <b>N/A</b>	SHEET	9 of 20

DESCRIPTION

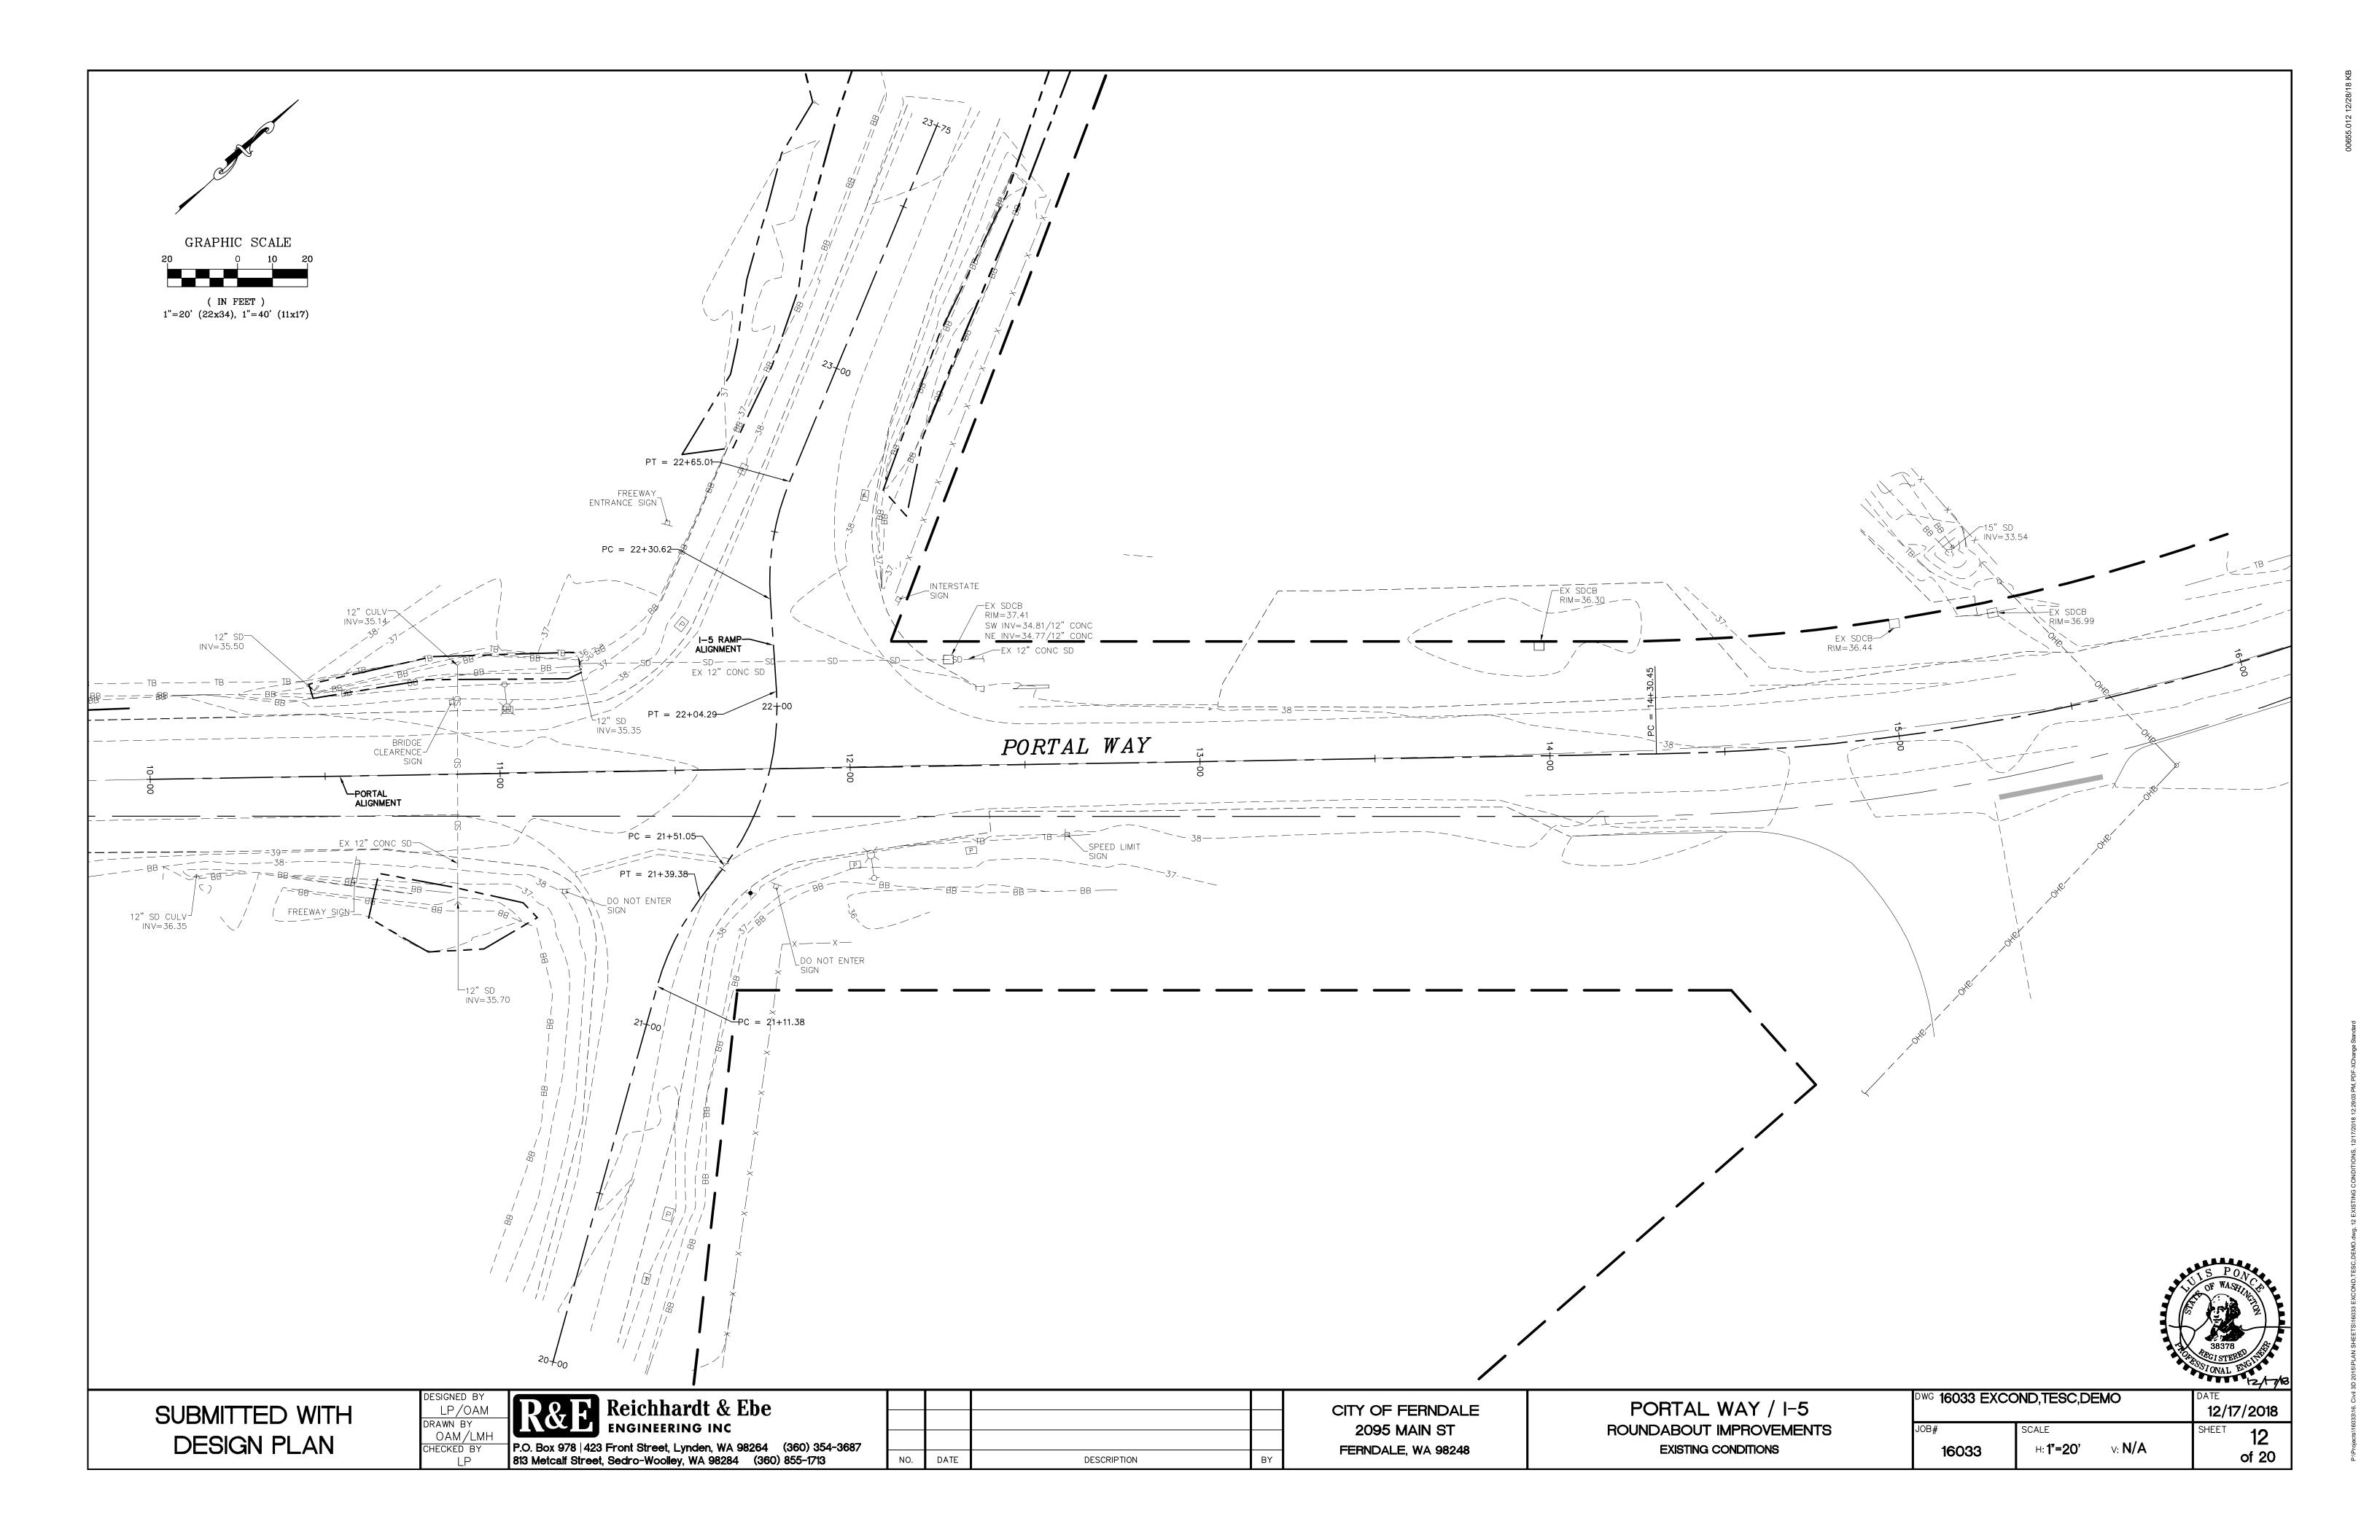

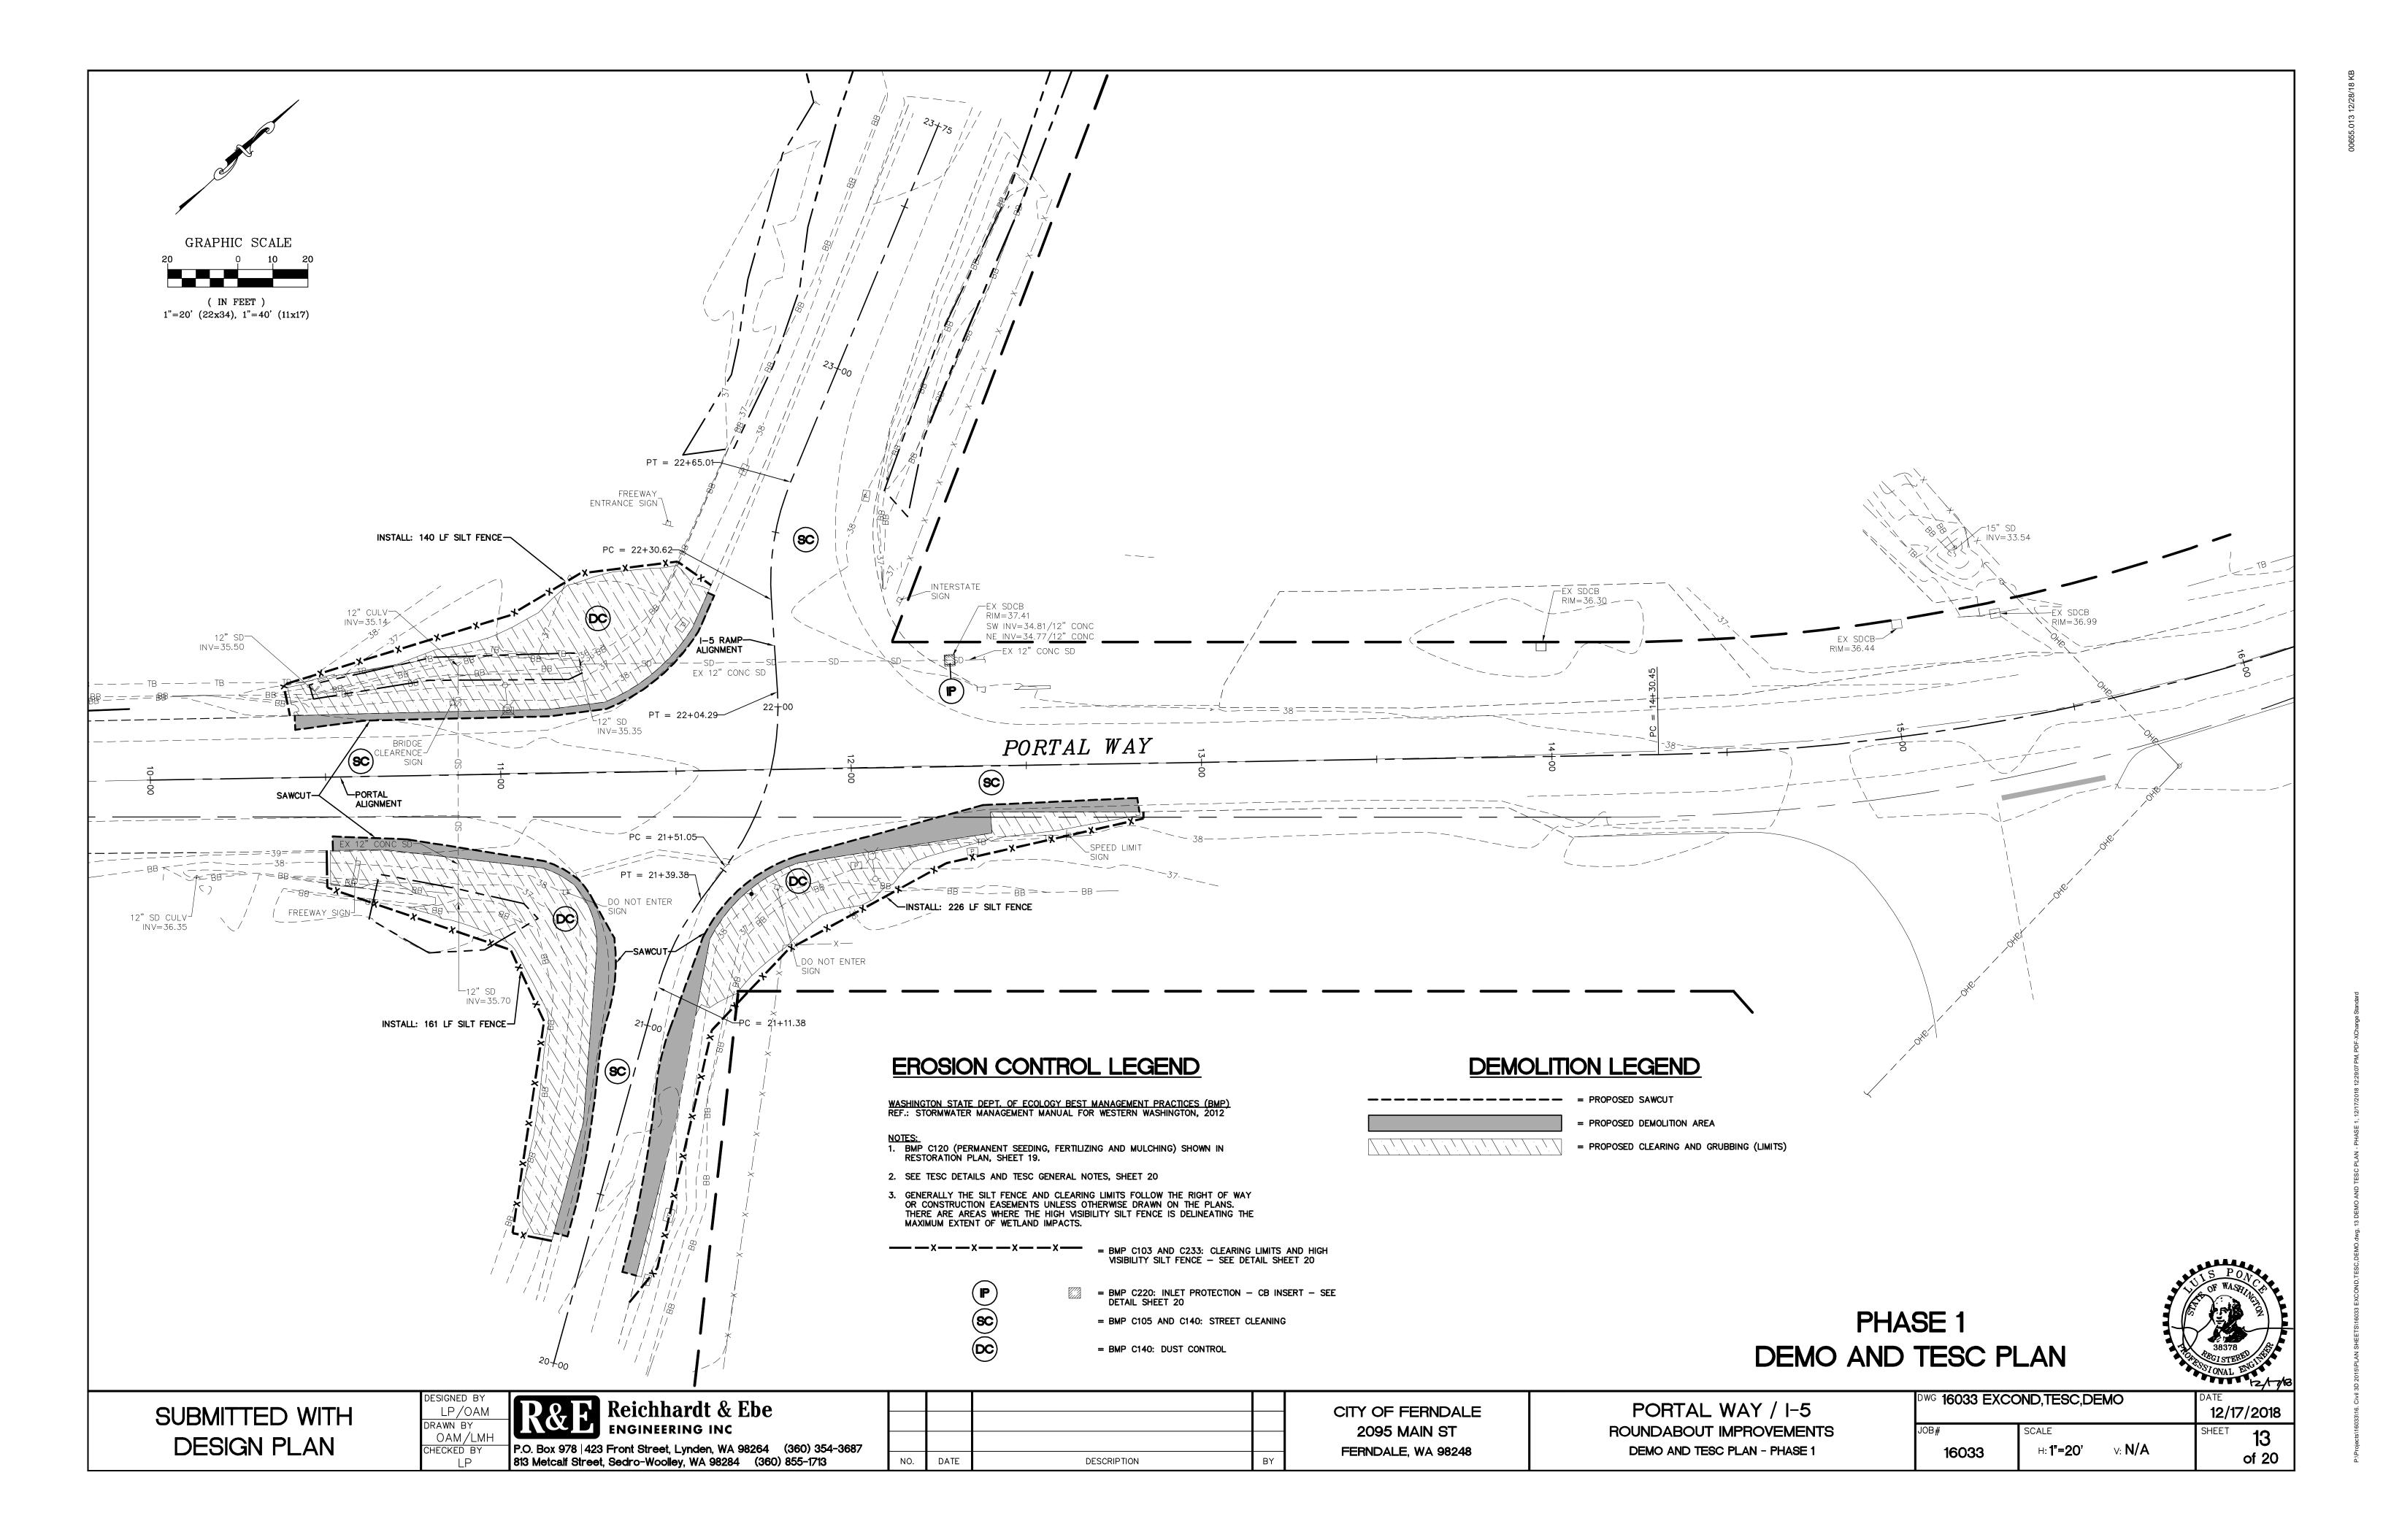

11+00

DESCRIPTION

R&E Reichhardt & Ebe

P.O. Box 978 | 423 Front Street, Lynden, WA 98264 (360) 354-3687 813 Metcalf Street, Sedro-Woolley, WA 98284 (360) 855-1713

AS-BUILT

DRAWN BY

RWG

CHECKED BY

12+00

CITY OF FERNDALE

2095 MAIN ST

FERNDALE, WA 98248

PORTAL WAY / I-5

ROUNDABOUT IMPROVEMENTS

PLAN AND PROFILE - PORTAL WAY - PHASE 1

P:\Projects\16033\16. Civil 3D 2015\PLAN SHEETS\16033 PLAN AND PROFILE.dwg, 14 PLAN AND PROFILE - PORTAL WAY - PHASE 1, 12/17/2


12/17/2018


of 20

OWG 16033 PLAN AND PROFILE

16033


H: 1"=20' V: 1"=2'

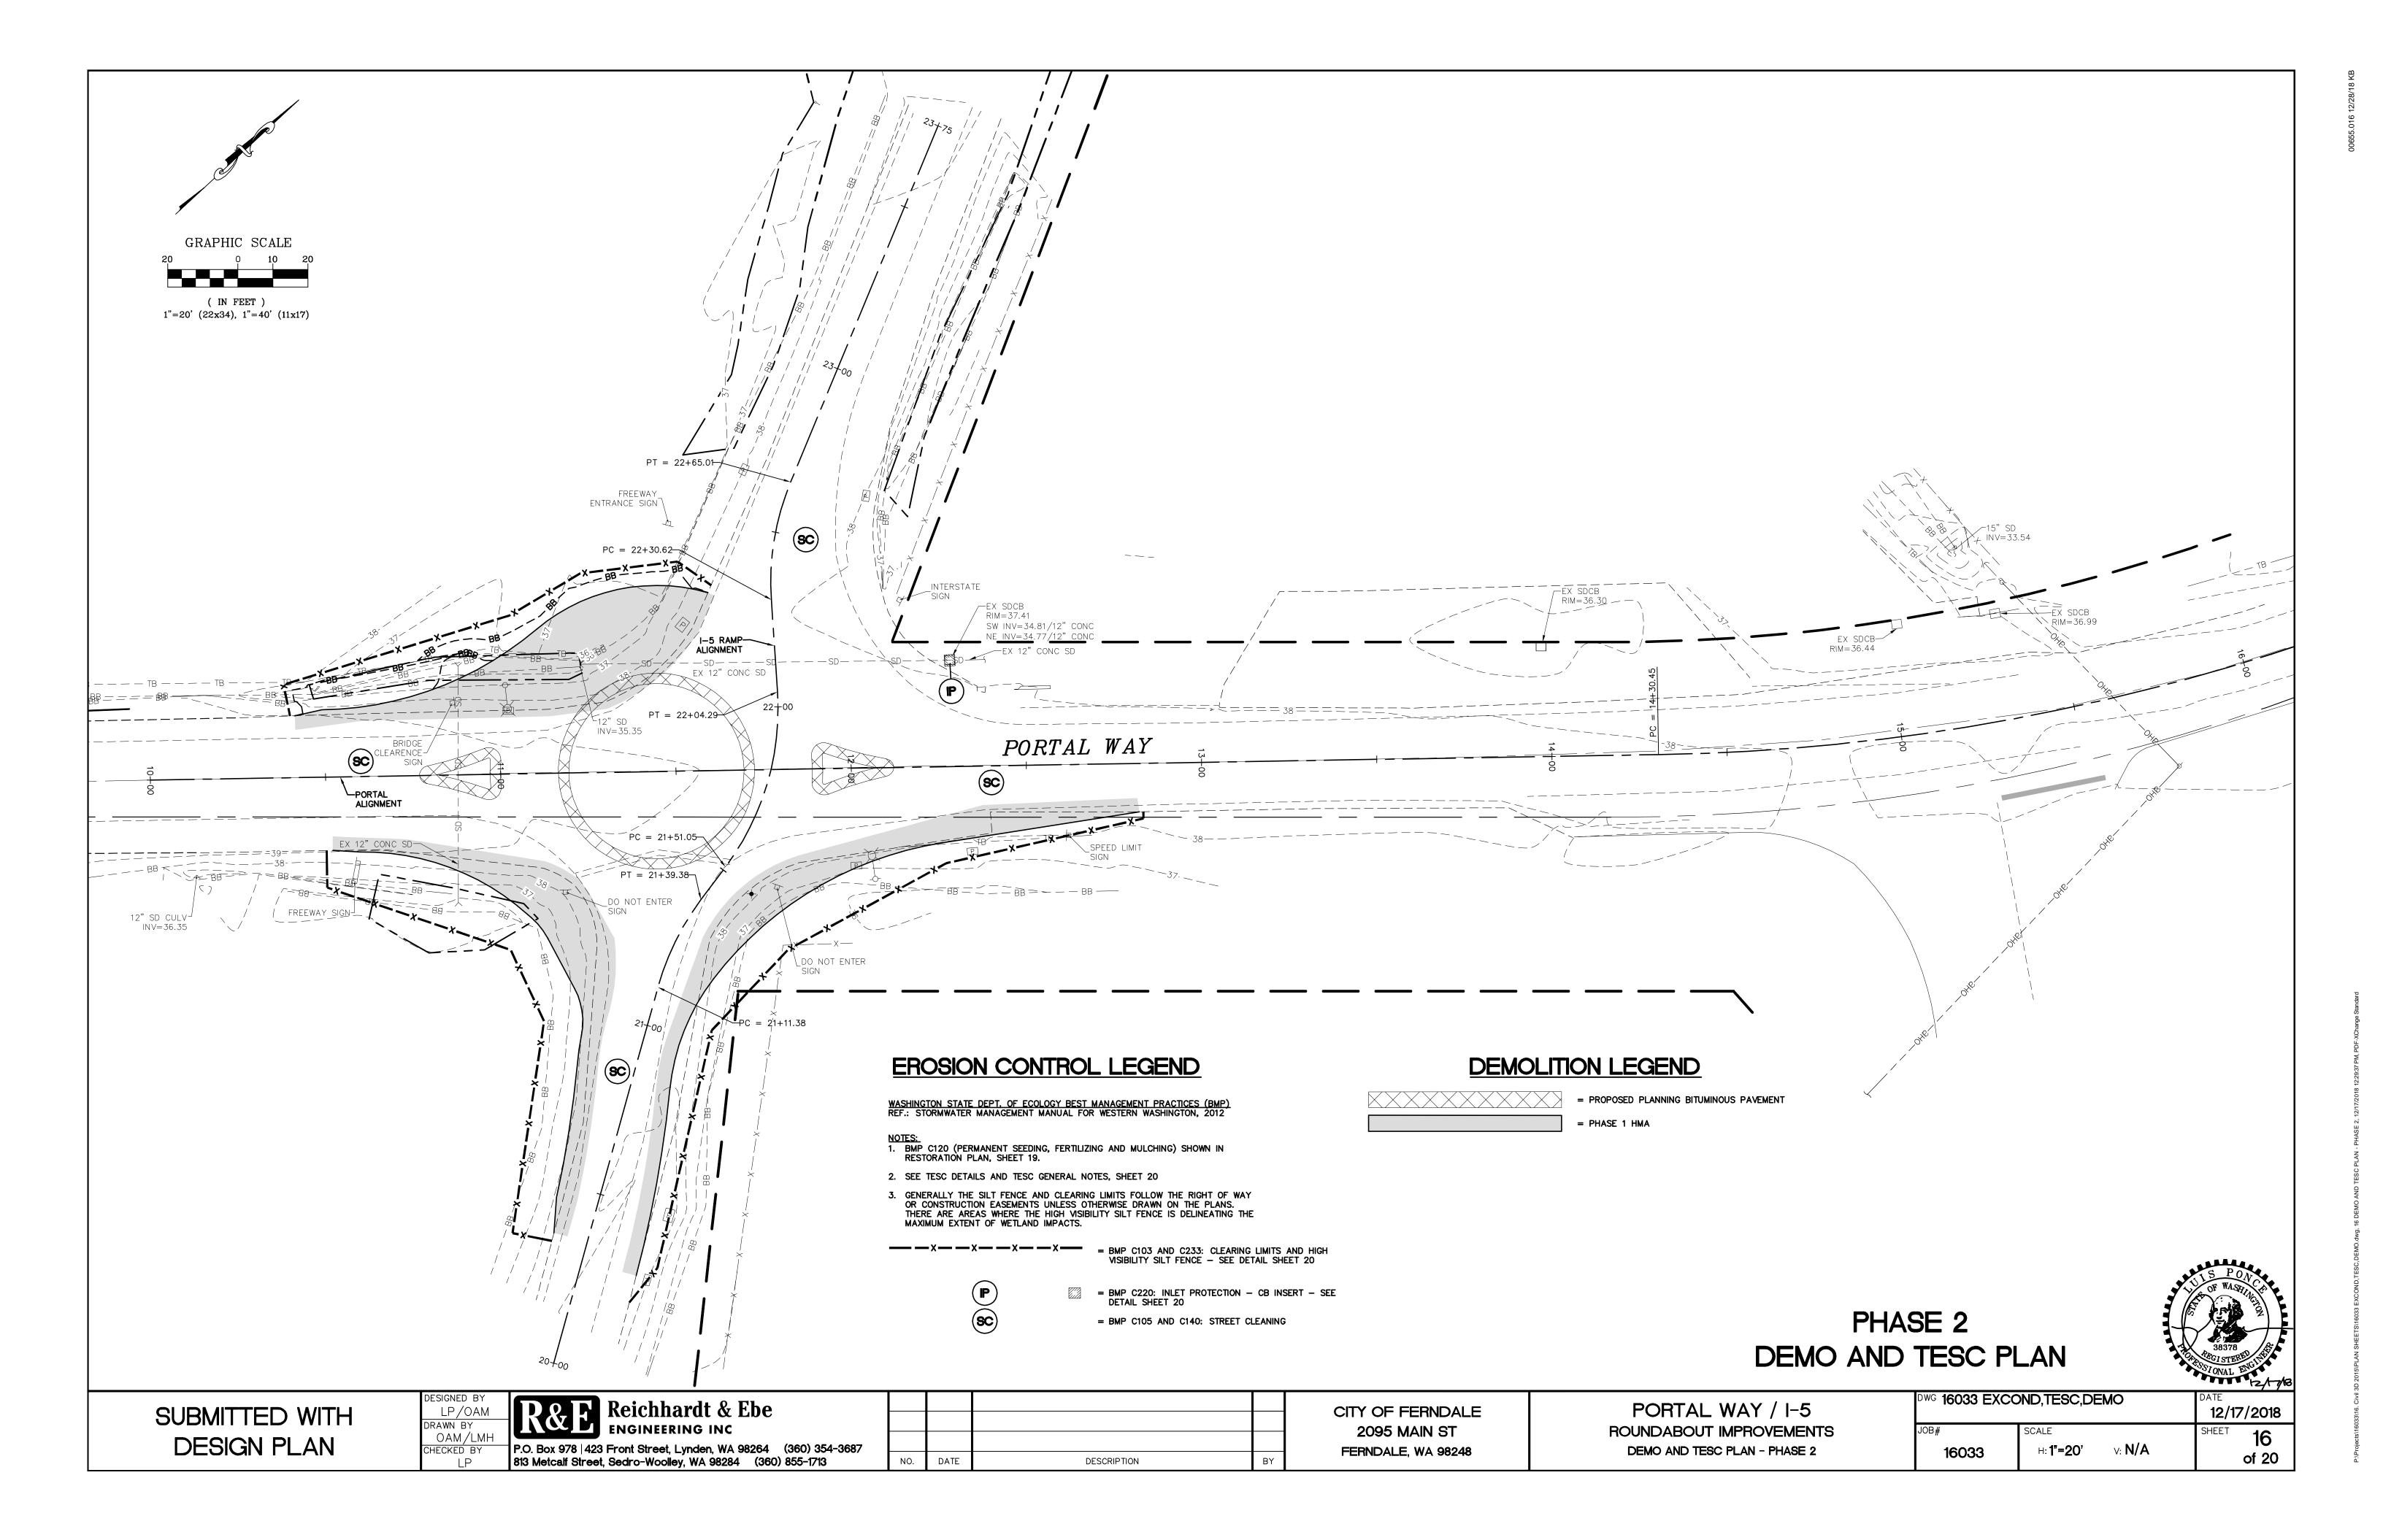


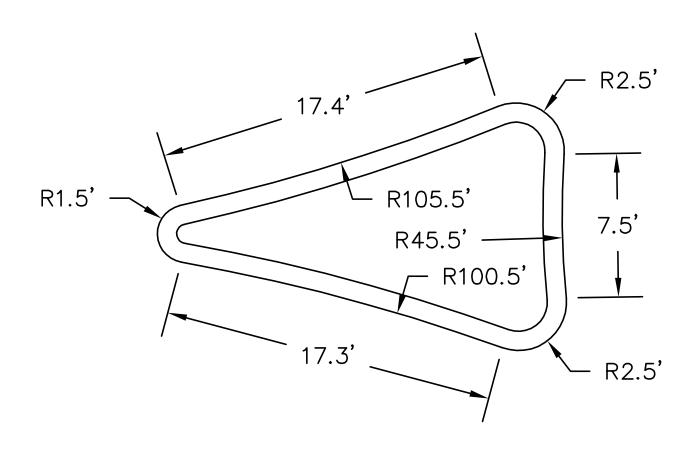

SPLITTER ISLAND DETAIL

WEST LEG AREA=163.5 SQ. FT.

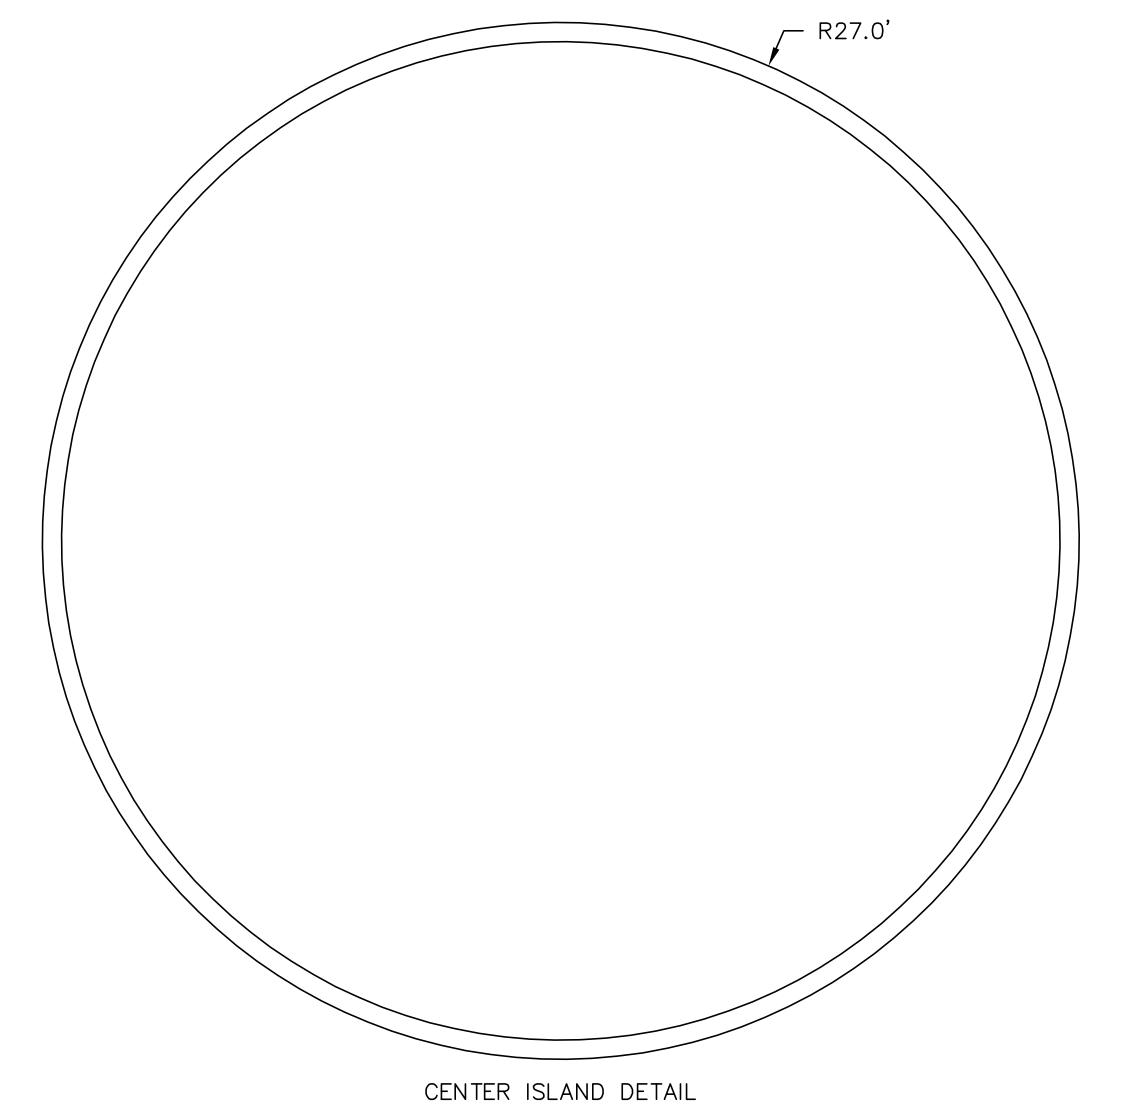


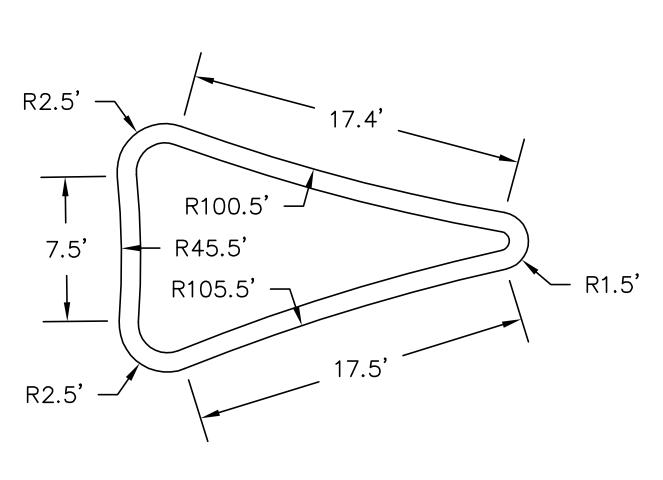

SPLITTER ISLAND DETAIL EAST LEG AREA=164.7 SQ. FT.


CENTER ISLAND DETAIL AREA=2,290.2 SQ. FT.

# GENERAL NOTES: 1. ALL DIMENSIONS ARE IN FEET UNLESS OTHERWISE NOTED. 2. HMA IN SPLITTER & CENTER ISLANDS TO BE PAINTED

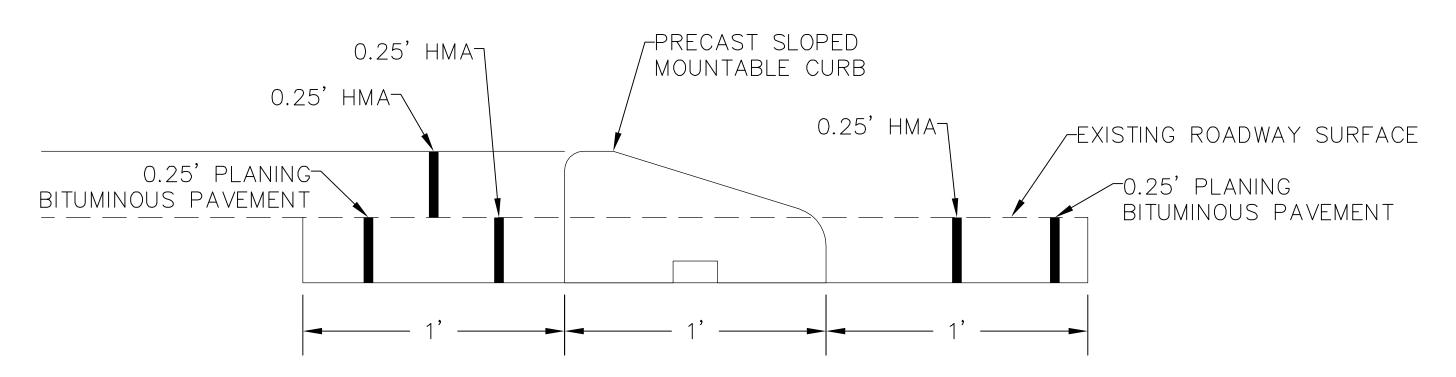

# EMBEDDED CURB DETAIL

# PHASE 2 TRAFFIC ISLAND

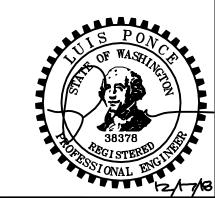

SUBMITTED WITH	
<b>DESIGN PLAN</b>	

YELLOW.

DESIGNED BY
LP/OAM
DRAWN BY
OAM/LMH
CHECKED BY

Reichhardt & Ebe
ENGINEERING INC

P.O. Box 978 | 423 Front Street, Lynden, WA 98264 (360) 354-3687
813 Metcalf Street, Sedro-Woolley, WA 98284 (360) 855-1713

CITY OF FERNDALE
2095 MAIN ST
FERNDALE, WA 98248


PORTAL WAY / I-5 ROUNDABOUT IMPROVEMENTS TRAFFIC ISLAND CURB DETAIL - PHASE 2 16033 EXCOND,TESC,DEMO

DATE
12/17/2018

SCALE
H: 1"=5" V: N/A

DATE
12/17/2018

SHEET 18
of 20

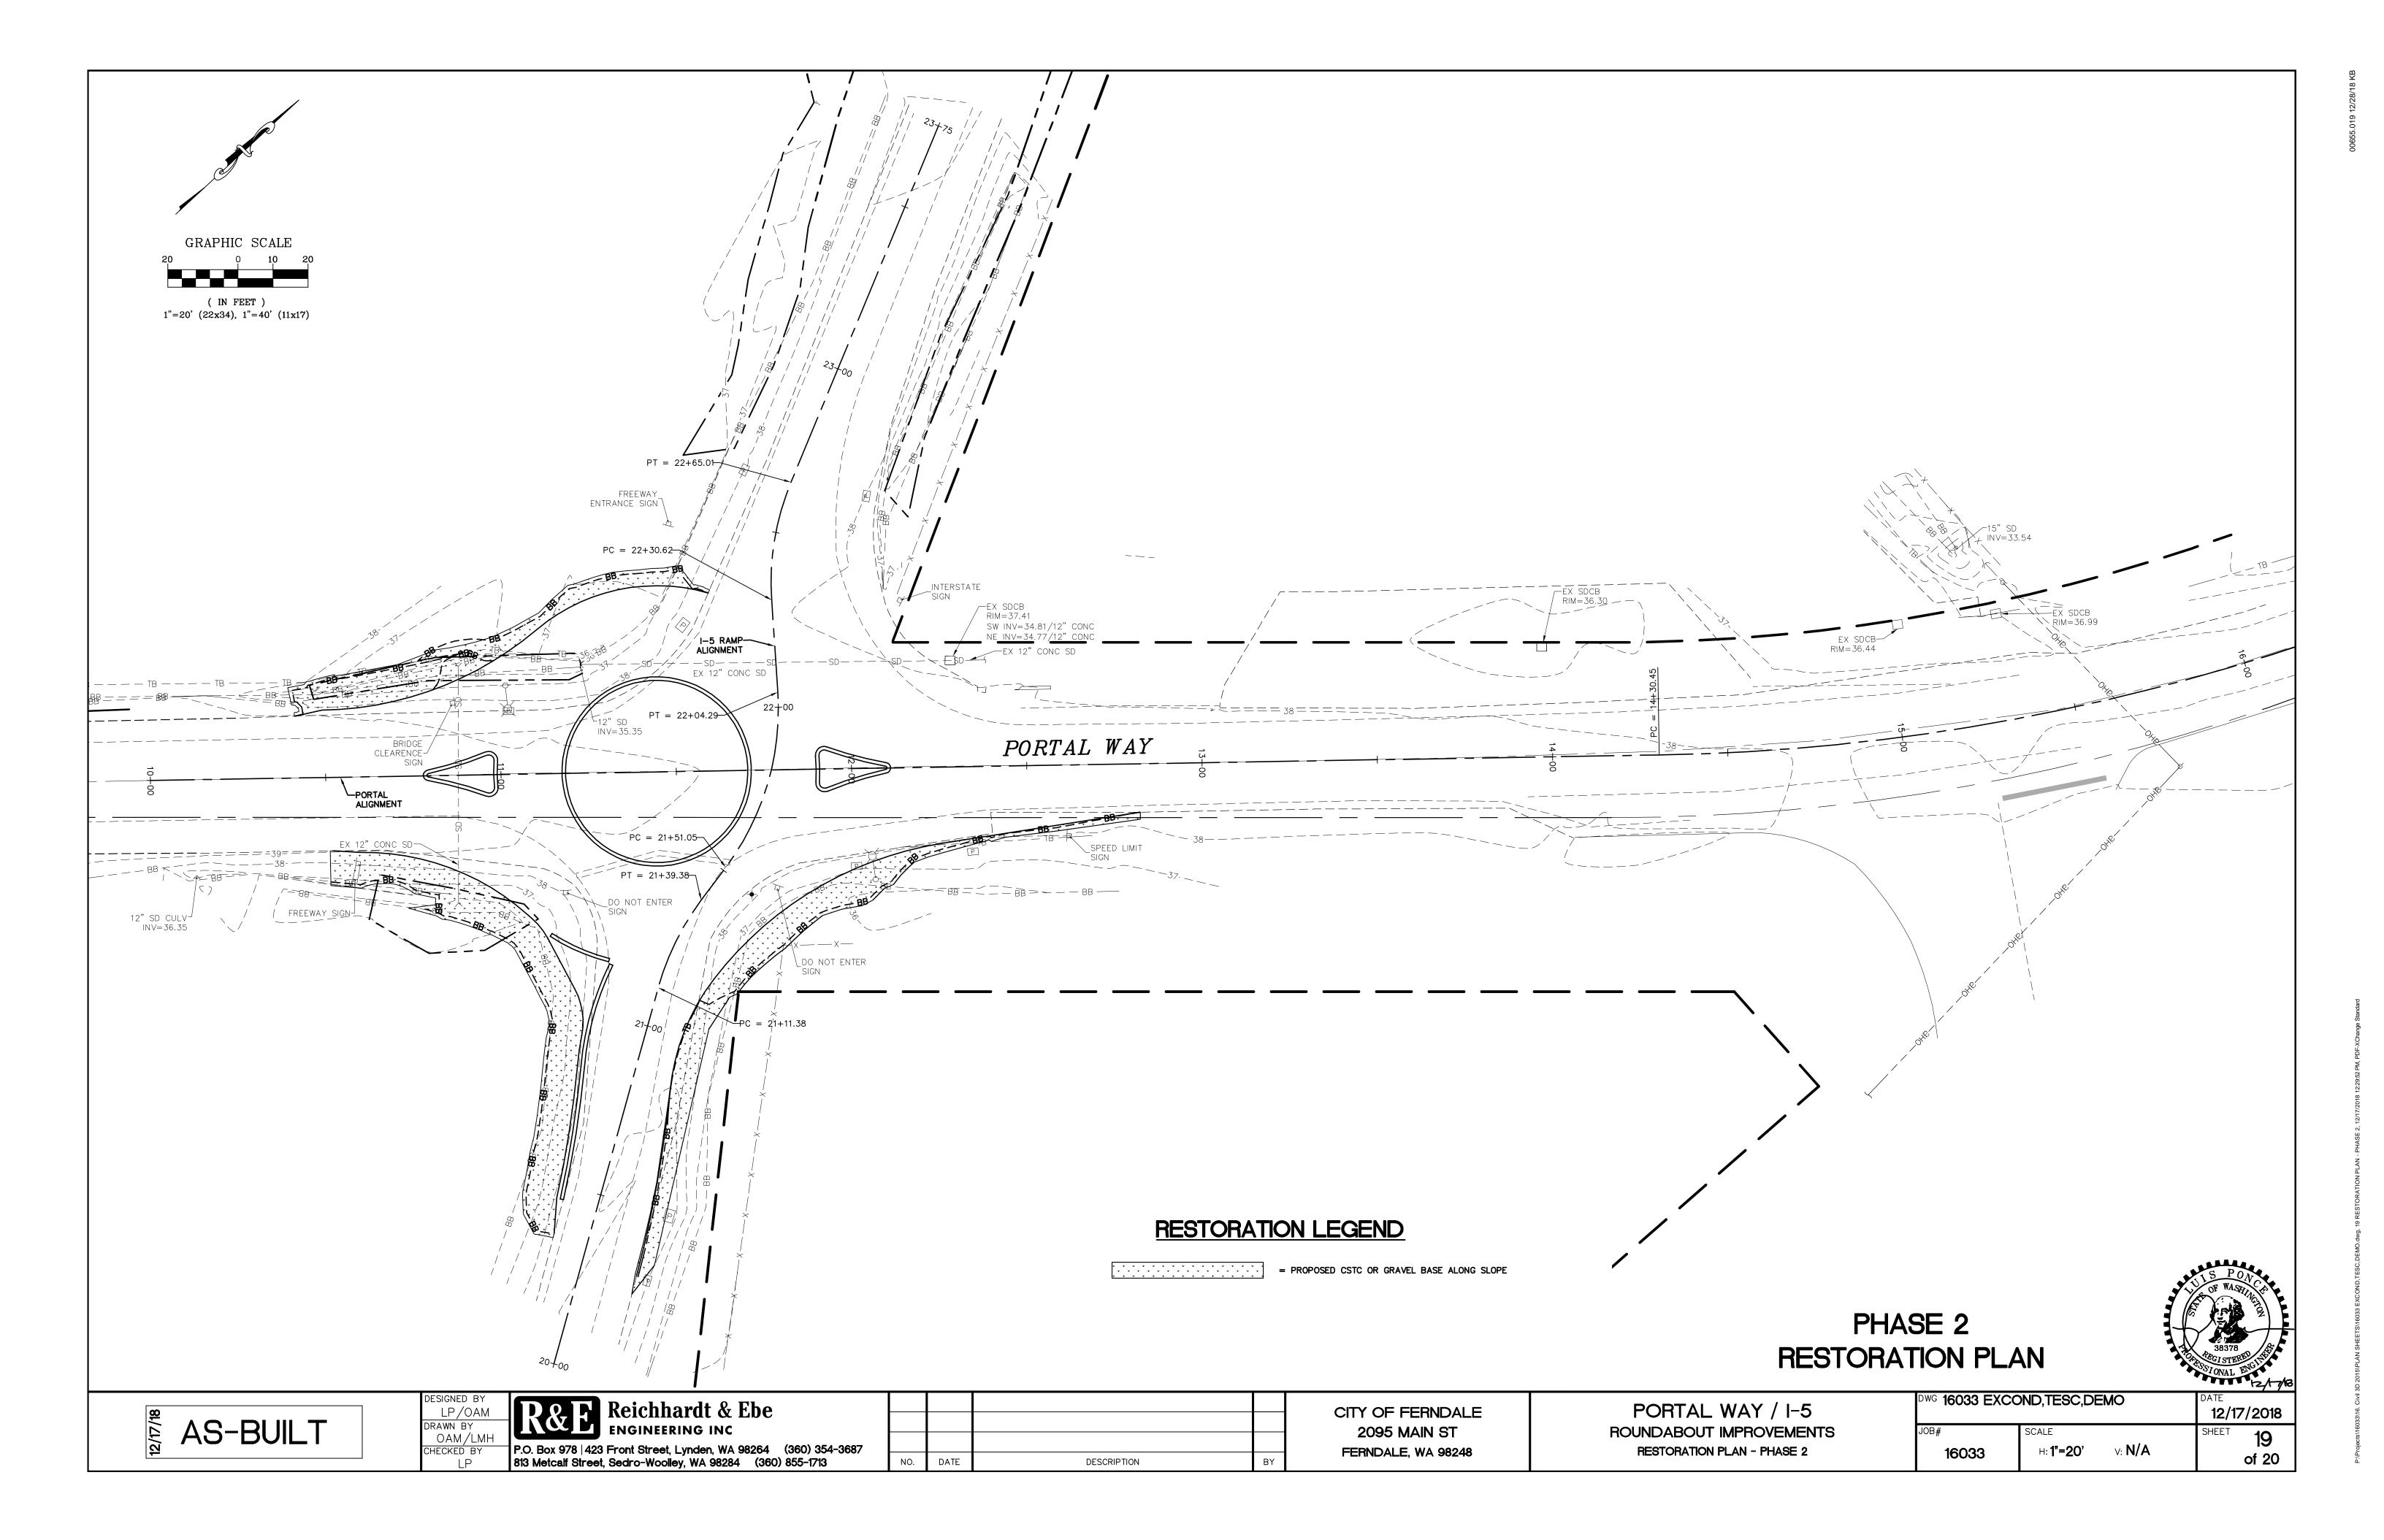

ALL CLEARING LIMITS SHALL BE VISIBLY MARKED PRIOR TO CLEARING. ANY VEGETATION NOT IN THE CONSTRUCTION AREA SHALL BE LEFT UNDISTURBED.

5. CONTRACTOR SHALL INFORM THE ENGINEER AND OBTAIN APPROVAL FROM THE ENGINEER OF ANY PROPOSED CHANGES IN PLAN PRIOR TO CONSTRUCTION OF THAT CHANGE. CONTRACTOR SHALL KEEP RECORD OF DEVIATIONS AND FORWARD TO THE ENGINEER.

6. MAINTENANCE AND OPERATION OF THE ENGINEER.
RESPONSIBILITY OF THE CONTRACTOR. THE CONTRACTOR SHALL BE RESPONSIBLE FOR IMPLEMENTATION OF THE SEDIMENTATION AND EROSION CONTROL MEASURES, AS SHOWN AND AS INSTALLED ON AN AS NEEDED BASIS. 7. THE CONSTRUCTED EROSION CONTROL AND SEDIMENTATION PLAN SHALL BE APPROVED BY THE ENGINEER PRIOR TO PERFORMING ANY SITE GRADING OR CLEARING.

8. CONTRACTOR WILL HAVE A WATER TRUCK AVAILABLE ON SITE AT ALL TIMES. CONTRACTOR WILL WATER SURFACES OFTEN ENOUGH TO ABATE DUST AS APPROVED BY THE ENGINEER. WATERING WILL INCLUDE WEEKENDS

9. THE CONTRACTOR SHALL PERFORM ALL STREET CLEANING BY HAND OR WITH A SELF-PROPELLED PICKUP STREET SWEEPER. A STANDARD SELF-PROPELLED STREET SWEEPER WILL NOT BE ALLOWED.


10. ALL DISTURBED AREAS SHALL BE HYDROSEEDED. GRASS SEEDING SHALL BE BROADCAST IN ACCORDANCE WITH


THE CONTRACT DOCUMENTS. 11. ALL CUT AND FILL SLOPES SHALL BE SEEDED AND FERTILIZED FOR EROSION CONTROL. CONTRACTOR SHALL BE RESPONSIBLE FOR SLOPE EROSION UNTIL VEGETATION IS FIRMLY ESTABLISHED.

12. ALL STORM DRAIN FACILITIES WITHIN THE PROJECT BOUNDARY, OR WHICH ARE IMPACTED BY THE PROJECT ARE TO BE CLEARED OF SEDIMENT AND DEBRIS PRIOR TO FINAL ACCEPTANCE OF THE PROJECT. 13. ALL WORK AND MATERIALS SHALL BE IN ACCORDANCE WITH THE CONTRACT DOCUMENTS.

<u>DUST CONTROL</u>:
CONTRACTOR SHALL LIMIT DUST GENERATION BY CLEARING ONLY THOSE AREAS WHERE IMMEDIATE EXCAVATION AND GRADING SHALL TAKE PLACE MAINTAINING THE ORIGINAL GROUND COVER AS LONG AS PRACTICAL. DUST CONTROL METHODS SHALL BE PERFORMED BY METHODS LISTED IN NOTE NUMBER EIGHT OF THE TESC GENERAL NOTES. SURFACES SHALL BE SPRAYED WITH WATER AS NEEDED IN ORDER TO ABATE DUST AS APPROVED BY THE ENGINEER.

CONTRACTOR SHALL PERFORM ALL STREET CLEANING AT A MINIMUM OF AT LEAST ONCE AT THE END OF EVERY DAY WORKED AND ON AN AS NEEDED BASIS BASED ON VEHICLE TRACK OUT. STREET CLEANING SHALL BE PERFORMED BY THE METHODS LISTED IN NOTE NUMBER 10 OF THE TESC GENERAL NOTES AND SHALL NOT ALLOW SEDIMENT INTO STORMWATER CONVEYANCE DITCHES OR STRUCTURES. STREET CLEANING METHODS SHALL BE APPROVED BY THE ENGINEER PRIOR TO THE BEGINNING OF CONSTRUCTION.

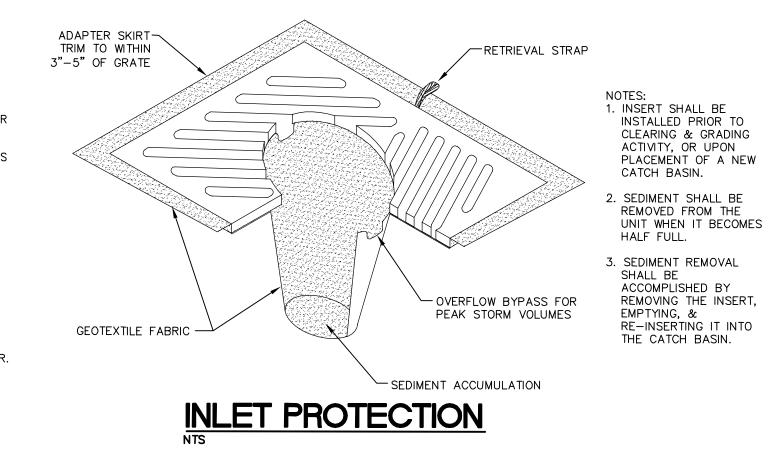

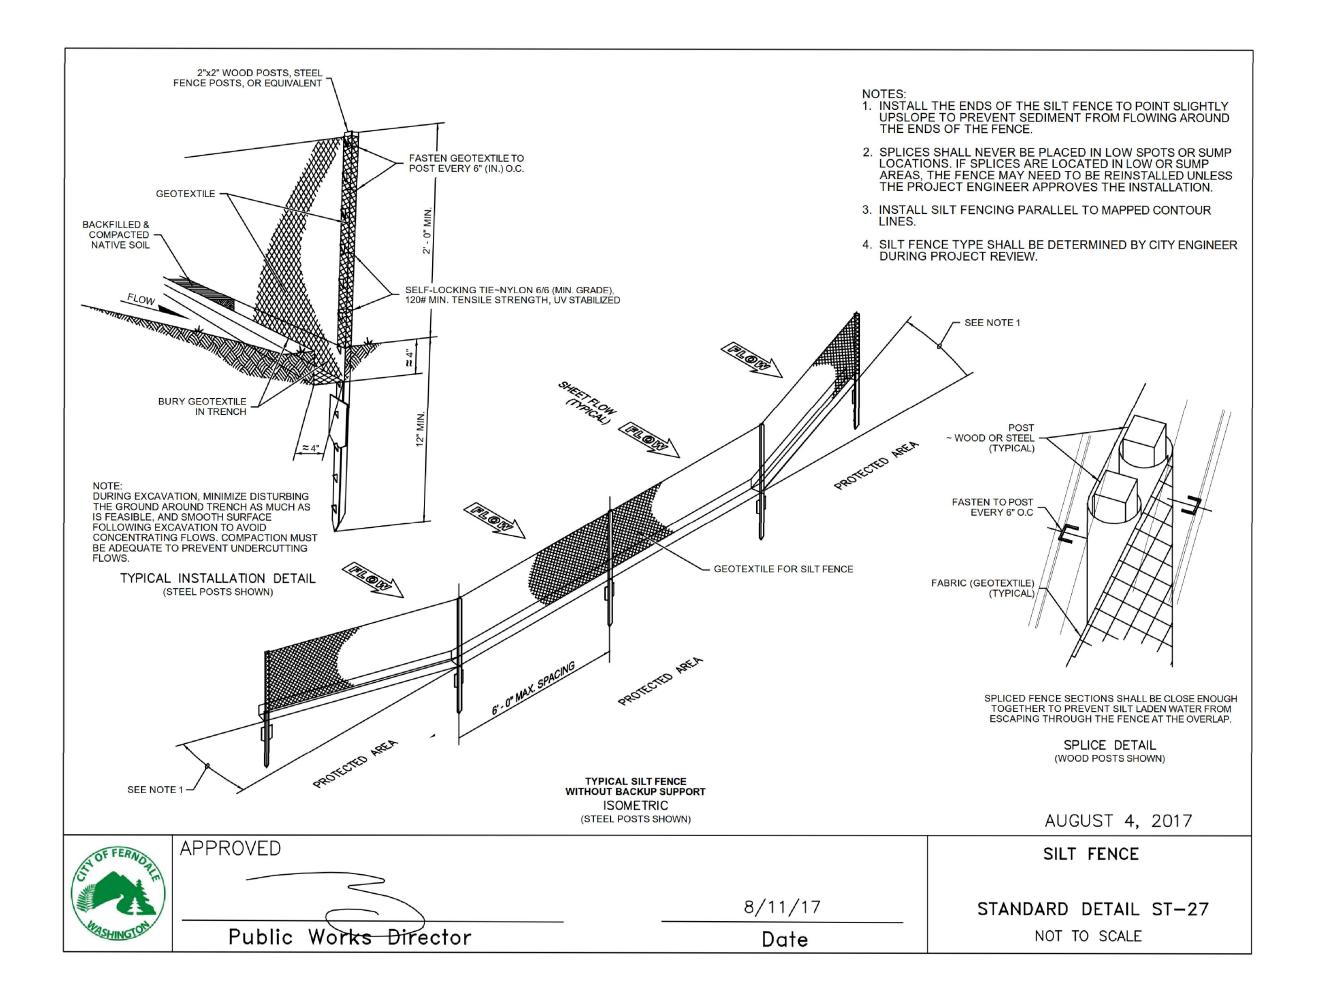



SUBMITTED WITH **DESIGN PLAN** 

DRAWN BY RWG/LMH CHECKED BY 813 Metcalf Street, Sedro-Woolley, WA 98284 (360) 855-1713

Reichhardt & Ebe ENGINEERING INC P.O. Box 978 | 423 Front Street, Lynden, WA 98264 (360) 354-3687

CITY OF FERNDALE **2095 MAIN ST** FERNDALE, WA 98248 DESCRIPTION

PORTAL WAY / I-5 ROUNDABOUT IMPROVEMENTS **DETAILS** 

33 DETA	ILS		DATE	
			12/1	7/2018
	SCALE		SHEET	20
033	H: <b>N/A</b>	∨: <b>N/A</b>		of 20

#### SEC. 20, T. 39N. R. 2E., W.M. CURVE DATA LENGTH S DESIGN SPEED **GENERAL NOTES** DELTA RADIUS TANGENT P.I. STATION PAVEMENT MARKING TYPE FLEXIBLE GUIDE POST 1. ALL DIMENSIONS ARE IN FEET UNLESS OTHERWISE NOTED. A 21+25.38 21°23'17" 75.00 28.00 25 MPH 1 PLASTIC EDGE LINE - WHITE 40°40′14" | 75.00' 27.80' 53.24 LOCATION TYPE A 21+77.6725 MPH REMOVE EXISTING PLASTIC STOP LINE AND ALL CONFLICTING PAINTED EDGE LINES AND DOUBLE CENTERLINES. 26°16'20" | 75.00' 2 PLASTIC EDGE LINE - YELLOW A 22+47.8217.50 34.39 25 MPH A 20+45.75, 12.87 LT 39°20'51" | 610.00' 218.10' 418.91 35 MPH P 16+39.90 A 20+50.74, 13.16 LT 3 PLASTIC DOTTED EXTENSION LINE - WHITE A 20+55.73, 13.54 LT 4 PLASTIC YIELD LINE SYMBOL - TYPE 2 PAVEMENT MARKING CURVE RADII A 20+60.70, 14.00 LT 5 PLASTIC TRAFFIC LETTER A 20+65.67, 14.55 LT 6 PLASTIC TRAFFIC ARROW - TYPE 1S 100.00 NOT USED A 20+70.63, 15.18 LT 120.00 110.00' 7 PLASTIC CROSSHATCH - 8" WHITE A 20+75.58, 15.90 LT NOT USED NOT USED A 23+0.54, 7.69 RT END EDGE LINE A 20+80.52, 16.70 LT NOT USED 105.00 MATCH EX A 20+85.44, 17.55 LT NOT USED 15.00 A 20+90.40, 18.19 LT P 11+83.52 50.00 61.28 LT, PC A 20+95.39, 18.54 LT A 22+49.37, 9.52 LT END EDGE LINE NOT USED 75.00' P 11+83.52 A 21+00.39, 18.60 LT 300.00 45.00 MATCH EX 40.80 LT, PCC NOT USED NOT USED A 21+05.38, 18.36 LT P 11+15.93 P 11+81.24, 33.79 LT 34.95 LT, PRC P 11+63.94, 40.74 LT NOT USED 315.00 A 21+10.35, 17.82 LT END DOTTED EXT LINE END EDGE LINE P 11+08.65 BEGIN EDGE LINE TOTAL 14 P 11+79.53 29.86 LT, PCC P 11+0.30, 8.94 LT **END PROJECT** P 11+88.60, 8.71 LT END EDGE LINE END EDGE LINE BEGIN EDGE LINE PORTAL WAY BEGIN EDGE LINE BEGIN DOTTED EXT LINE P 10+59.93, 0.01 RT P 13+00.00 YIELD LINE BEGIN EDGE LINES P 10+63.08, 11.23 LT, PC BEGIN EDGE LINE 11+43.62 6 MATCH EX END EDGE LINES PORTAL WAY P 12+52.12, 11.67 A 21+81.94 MATCH EX MP 263.48 P 11+80.34 6 6 P 11+34.37 34.20 RT PORTAL WAY END TAPER **BEGIN PROJECT** END EDGE LINE P 11+0.26, 8.48 RT (2) BEGIN DOTTED EXT LINE 1 MATCH EX MATCH EX **PORTAL WAY** \P 12+30.27, 13.15 RT, PC END EDGE LINES BEGIN TAPER P 10+00.00 YIELD LINE P 11+88.54, 8.74 RT BEGIN EDGE LINES P 11+17.30, 35.78 RT, PRC END DOTTED EXT LINE <u>A 21+24.64, 10.03 LT</u> END EDGE LINES P 11+72.91, 34.71 RT END DOTTED EXT LINE BEGIN DOTTED EXT LINE 2 6 YIELD LINE **LEGEND** <u>A 20+83.88</u> 12.32 LT, PRC A 20+82.77 3.21 RT, PRC ◆ TRAFFIC ARROW TRAFFIC LETTER TTTT YIELD LINE SYMBOL 4 TYP FLEXIBLE GUIDE POST A 20+30.94,7.50 LT, PT BEGIN EDGE LINE ————— DOTTED EXTENSION LINE, 12" WIDE, 3' LONG, 2' GAP ---- Existing edge line MATCH EX ------ NEW EDGE LINE TRAFFIC LETTER PLACEMENT DETAIL A 20+30.35, 7.90 RT, PC ---- EXISTING EDGE OF PAVEMENT BEGIN EDGE LINE MATCH EX ---- NEW EDGE OF PAVEMENT **SUBMITTED WITH**

DESIGN PLAI	V

						REICHHARDT & EBE ENGINEERING, INC.
DRAWN	RMH					P.O. Box 978
DESIGNED	RMH					Lynden, Washington 98264
CHECKED	3/29/18 RMH					CITY OF FERNIDALE
PROJ. ENGR.						CITY OF FERNDALE
DRAWING FILE	MK_rev2.DWG					P.O. Box 936
		DATE	REVISION	BY	APP'D	Ferndale, Washington 98248







11215 Southeast 220th Place,	Kent, Washington 98031
253-236-4941 tel.	hte@comcast.net

-5 MP 263.48		
I-5 NB RAMPS/PORTAL WAY	MK1	
FERNDALE, WHATCOM COUNTY MARCH, 2018	SHEET	
PAVEMENT MARKING PLAN	OF	

SHEETS

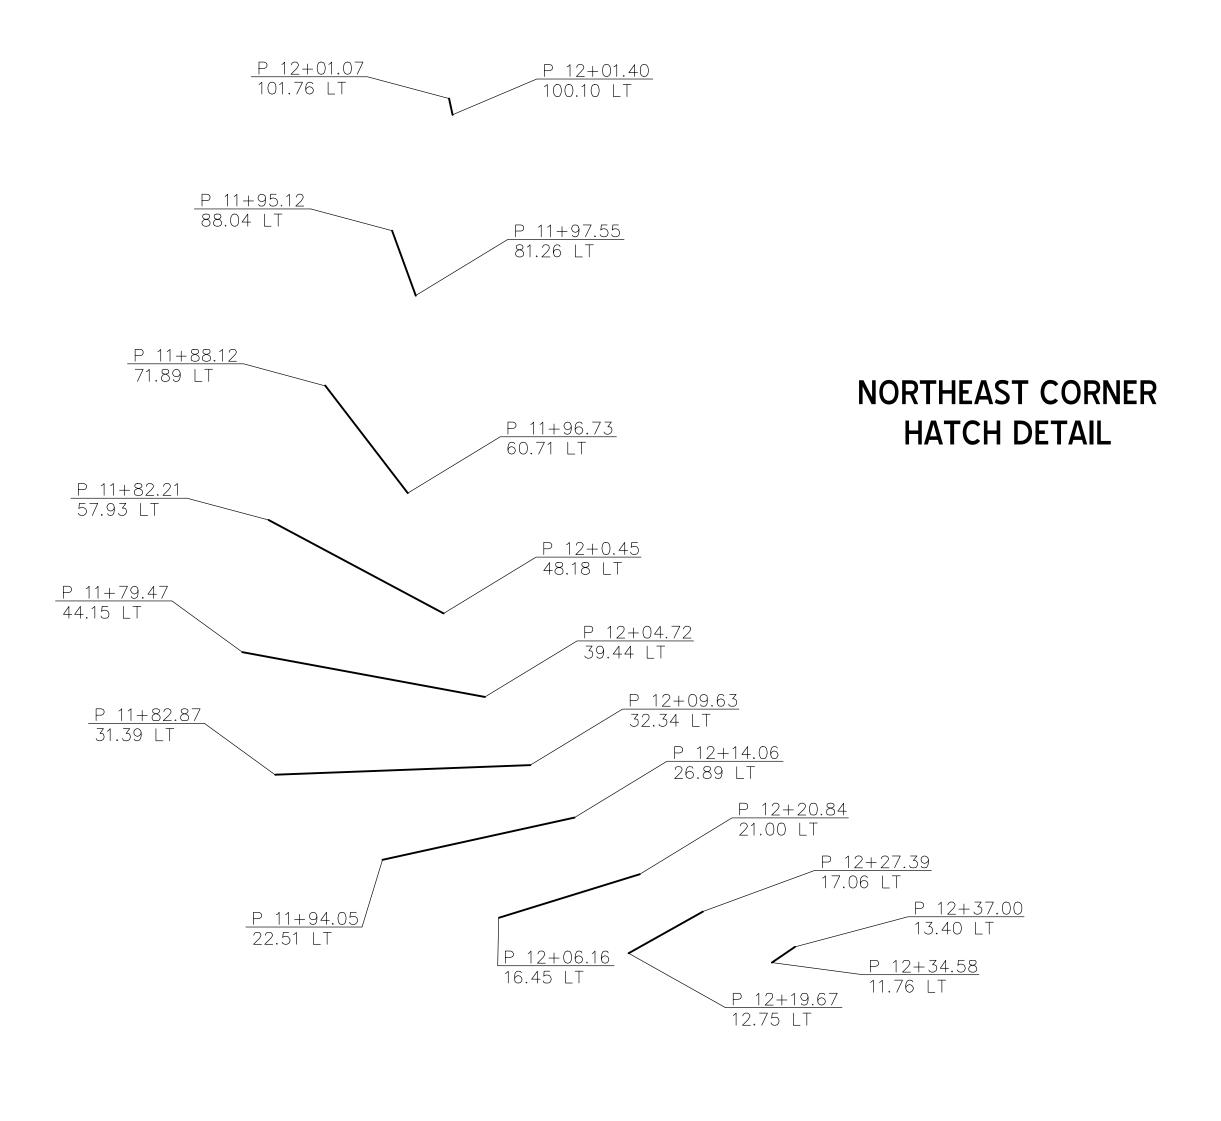

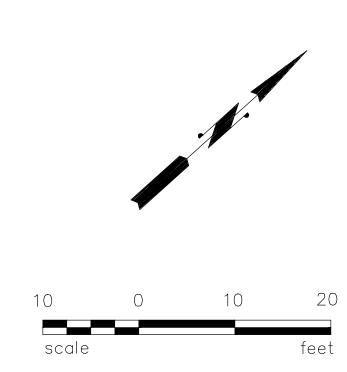

### **GENERAL NOTES**

1. ALL DIMENSIONS ARE IN FEET UNLESS OTHERWISE NOTED.

# SUBMITTED WITH DESIGN PLAN

						<b>REICHHARDT &amp; EBE ENGINEERING, INC.</b> P.O. Box 978
DRAWN	RMH					
DESIGNED	RMH					Lynden, Washington 98264
CHECKED	3/29/18 RMH					CITY OF FERNDALE
PROJ. ENGR.						
DRAWING FILE	MK_rev2.DWG					P.O. Box 936
		DATE	REVISION	BY	APP'D	Ferndale, Washington 98248





253-236-4941 tel. hte@comcast.net

-5	MP 2	263.4
I-5 NB RAMPS/PORTAL WAY	Y	
FERNDALE, WHATCOM COUNTY	MARCH,	2018
PAVEMENT MARKING PLAN		

MK2

#### GENERAL NOTES (GN):

- A) POST LENGTHS AND "W" VALUES SHOWN ARE APPROXIMATE. FINAL VALUES SHALL BE DETERMINED IN THE FIELD BY THE CONTRACTOR PRIOR TO FABRICATION AND INSTALLATION.
- B) FOR STRUCTURE AND MOUNTING DETAILS SEE STANDARD PLAN SERIES "G".
- C) FOR CODE REFERENCES AND STANDARD DETAILS SEE WASHINGTON STATE SIGN FABRICATION MANUAL.
- D) ALL 2.5" PERFORATED SQUARE STEEL TUBE (PSST) POSTS SHALL BE 12 GAGE.
- E) 2.5" SQ (SB) AND 2.5" SQ (5) PSST POSTS SHALL HAVE A 12 GAGE 2 1/4" PSST INSERT OF THE SAME LENGTH.
- F) ALL WIDE FLANGE STEEL POSTS SHALL BE ASTM A36.
- G) ALL ROUND STEEL POSTS ARE MEASURED TO OUTSIDE DIAMETER AND SHALL HAVE TYPE AP SIGN SUPPORTS.
- H) ALL SIGNS 36" OR WIDER SHALL BE BRACED IN ACCORDANCE WITH STANDARD PLAN G-50.10.
- I) 5", 6", 7" AND 8" SQUARE STEEL TUBE SIGN POSTS SHALL HAVE TYPE TP-B BASES. ASTM A36 W6x12 FOUNDATION SPECIFICATIONS SHALL BE USED UNLESS OTHERWISE NOTED IN THE PLANS.
- J) NOT USED.
- K) 3" SOLID SQUARE STEEL TUBE POSTS SHALL BE 7 GAGE AND SHALL HAVE A 10" TRIANGULAR SLIP BASE UNLESS OTHERWISE NOTED. SEE STANDARD PLAN G-24.40, TYPE SB-1 AND SB-3 SLIP BASE ASSEMBLY.
- L) NOT USED.
- M) NOT USED.
- N) ALL OVERHEAD SIGN MOUNTING HARDWARE SHALL BE NEW UNLESS OTHERWISE SHOWN ON THE PLANS OR SIGN SPECIFICATION SHEETS.

		LL BE AS FOLLOWS:	
TYPE OF SIGN SHEETING TYPE			
	BACKGROUND	LEGEND / BORDER	
GUIDE - LIT	*	IIIOR IV	
GUIDE - UNLIT	III OR IV*	VIII OR IX	
STREET NAME	<b>∥</b> OR IV	IV	
REGULATORY	N	N/A	
WARNING	*	N/A	

^{*} FOR YELLOW BACKGROUND USE TYPE VIII OR IX FLUORESCENT SHEETING.

	ABBREVIATIONS LEGEND			
AAH	ADOPT A HIGHWAY			
AHD	AHEAD			
BR MOUNT	BRIDGE MOUNTED SIGN BRACKET			
BTWN	BETWEEN			
CANT	CANTILEVER			
CL	CENTER LINE			
CN	CONSTRUCTION NOTE			
CONT	CONTINUED			
EX OR EXIST	EXISTING			
HAR	HIGHWAY ADVISORY RADIO			
I/C	INTERCHANGE			
I/S	INTERSECTION			
LT	LEFT			
LT STD	LIGHT STANDARD			
MO D	MODIFIED			
MP	MILE POST			
MTG HDWR	MOUNTING HARDWARE			
N/A	NOT APPLICABLE			
NO.	NUMBER			
PED	PEDESTRIAN			
PERP	PERPENDICULAR			
PSST	PERFORATED SQUARE STEEL TUBE			
R-	REMOVAL			
RT	RIGHT			
SIG POLE	SIGNAL POLE			
SIGN BR	SIGN BRIDGE			
SB	SLIP BASE			
SQ	SQUARE			
STA	STATION			
TYP	TYPICAL			
W/	WITH			
XING OR X-ING	CROSSING			

2 1/2" PERFORATED & 3" SQUARE STEEL TUBE SIGN POST SUPPORTS					
POST SIZE (#)	CALL OUT IN THE POST SIZE COLUMN	SIGN SUPPORT TYPE	GENERAL NOTE		
2 1/2"	2.5" SQ (1)	ST-1	D		
2 1/2"	2.5" SQ (4)	ST-4	D		
2 1/2"	2.5" SQ (SB)	SB-1, SB-2 OR SB-3	D, E		
2 1/2"	2.5" SQ (5)	ST-4	E		
3"	3" SQ (SB)	SEE NOTE K	K		
3"	3" SQ (5)	ST-4	K		

SEE STANDARD PLANS G-24.40 AND G-24.50

# **SUBMITTED WITH DESIGN PLAN**

			<b>⊣</b>		
					REICHHARDT & EBE ENGINEERING, INC.
DRAWN	RMH				P.O. Box 978
DESIGNED	RMH				Lynden, Washington 98264
CHECKED	3/29/18 RMH				CITY OF FERNIDAL F
PROJ. ENGR.					CITY OF FERNDALE
DRAWING FILE	SN_rev2.DWG				P.O. Box 936
		DATE	REVISION	BY APP'D	Ferndale, Washington 98248





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I-5 MP 263.48	
I-5 NB RAMPS/PORTAL WAY	SS1
FERNDALE, WHATCOM COUNTY MARCH, 2018	SHEET
SIGN SPECIFICATIONS	OF
	SHFFTS

### SIGN SPECIFICATIONS

SIGN	SIGN			SIGN SIZE	SHEETING	LETTER SIZE	POST	POST	POST LENGTH	CLEARAI	NCF
NO.	CODE	SIGN DESCRIPTION	LOCATION	XY	TYPE	OR CODE	MATERIAL	SIZE	H1 H2 H3 H4		W REMARKS
1 A	W2-6P	ROUNDABOUT AHEAD	P 6+71, RT	36" 18"	III OR IV	STANDARD	STEEL	2.5" SQ (5)	15'	· ·	4' SEE CN 1
1B	W2-6	ROUNDABOUT SYMBOL	,	36" 36"	III OR IV	STANDARD		( )		7'	MOUNT BELOW SIGN NO. 1A
1 C	W13-1 (10)	 10 MPH		24" 24"	III OR IV	STANDARD				5'	MOUNT BELOW SIGN NO. 1B
	D1-901 MOD.	I-5 NORTH VANCOUVER B.C.	P 10+45, RT	9.5' 6.5'		SEE DETAIL	STEEL	3" SQ (SB)	14' 16'		6' SEE CN 2
		WITH LEFT FISHHOOK ARROW	,					. ,			
R-3		I-5 NORTH VANCOUVER B.C.	P 10+54, RT								REMOVE SIGN AND WOOD POSTS (2)
		WITH LEFT ARROW									
4		14'-0"	P 10+43, LT				STEEL	2.5" SQ (5)	14'	7' 1	3' RELOCATE SIGN FROM P 10+87 LT, SEE CN 1
R-5		WOOD POST	P 10+87, LT					, ,			REMOVE WOOD POST
6		VISITOR INFORMATION	P 10+59, LT				LIGHT STANDARD			7' 1	5' RELOCATE WITH LIGHT STANDARD
7A	R1-2	YIELD	P 10+88, RT	36" 36"	III OR IV	STANDARD	STEEL	2.5" SQ (5)	13'	7.5' 1	6' SEE CN 1
7B	R6-5P	ROUNDABOUT DIRECTIONAL		30" 30"	III OR IV	SEE DETAIL				5'	MOUNT BELOW SIGN NO. 7A
R-8		STOP	P 11+16, RT								REMOVE SIGN AND WOOD POST
9		DO NOT ENTER	P 11+22, RT					3" SQ (SB)	14'	7' 1	O' RELOCATE SIGN FROM P 11+16 RT, SEE CN3
10		ONE WAY>	P 11+22, RT							11'	RELOCATE SIGNS (2) FROM P 11+16 RT TO ABOVE
		<one td="" way<=""><td></td><td></td><td></td><td></td><td></td><td></td><td></td><td>11'</td><td>AND PERPENDICULAR TO SIGN NO. 9</td></one>								11'	AND PERPENDICULAR TO SIGN NO. 9
R-11		STOP	P 11+70, RT								REMOVE SIGN AND WOOD POST
12		DO NOT ENTER	P 11+74, RT					3" SQ (SB)	14'	7' 1	6' RELOCATE SIGN FROM P 11+70 RT, SEE CN 2
13		ONE WAY>	P 11+74, RT							11'	RELOCATE SIGNS (2) FROM P 11+70 RT TO ABOVE
		<one td="" way<=""><td></td><td></td><td></td><td></td><td></td><td></td><td></td><td>11'</td><td>AND PERPENDICULAR TO SIGN NO. 12</td></one>								11'	AND PERPENDICULAR TO SIGN NO. 12
14A	R1-2	YIELD	P 11+66, RT	36" 36"	III OR IV	STANDARD	STEEL	2.5" SQ (SB)	13'	7.5' 1	6' SEE CN 2
14B	R6-5P	ROUNDABOUT DIRECTIONAL		30" 30"	III OR IV	SEE DETAIL				5'	MOUNT BELOW SIGN NO. 14A
15A	R1-2	YIELD	P 12+08, LT	36" 36"	III OR IV	STANDARD	STEEL	2.5" SQ (5)	13'	7.5' 2	SEE CN 2
15B	R6-5P	ROUNDABOUT DIRECTIONAL		30" 30"	III OR IV	SEE DETAIL				5'	MOUNT BELOW SIGN NO. 15A
16		I-5 SOUTH^ NORTH>	P 13+94, LT				STEEL	2.5" SQ (5)	15'	7' 1	7' SEE CN 2
R-17		WOOD POST	P 12+15, LT								REMOVE WOOD POST
18A	W2-6P	ROUNDABOUT AHEAD	P 17+26, LT	36" 18"	III OR IV	STANDARD	STEEL	2.5" SQ (5)	15'	11.25' 1	4' SEE CN 2
18B	W2-6	ROUNDABOUT SYMBOL		36" 36"	III OR IV	STANDARD				7'	MOUNT BELOW SIGN NO. 18A
18C	W13-1 (10)	10 MPH		24" 24"	III OR IV	STANDARD				5'	MOUNT BELOW SIGN NO. 18B
R-19		STOP AHEAD	SEE PLAN DIMENSION								REMOVE SIGN AND TRIM POST
20A	W2-6P	ROUNDABOUT AHEAD	SEE PLAN DIMENSION	36" 18"	III OR IV	STANDARD	STEEL	2.5" SQ (SB)	15'	11.25' 1	4' SEE CN 2
20B	W2-6	ROUNDABOUT SYMBOL		36" 36"	III OR IV	STANDARD				7'	MOUNT BELOW SIGN NO. 20A
20C	W13-1 (10)	10 MPH		24" 24"	III OR IV	STANDARD				5'	MOUNT BELOW SIGN NO. 20B

CONSTRUCTION NOTES (CN):

- 1. EDGE OF SIGN SHALL BE MINIMUM 2' BEHIND BACK OF SIDEWALK.
- 2. EDGE OF SIGN SHALL BE MINIMUM 6' BEHIND EDGE OF PAVEMENT.
- 3. EDGE OF SIGN SHALL BE MINIMUM 2' BEHIND FACE OF CURB.

# SUBMITTED WITH DESIGN PLAN


						REICHHARDT & EBE ENGINEERING, INC.
DRAWN	RMH					P.O. Box 978
DESIGNED	RMH					Lynden, Washington 98264
CHECKED	3/29/18 RMH					CITY OF FEDNIDAL F
PROJ. ENGR.						CITY OF FERNDALE
DRAWING FILE	SN_rev2.DWG					P.O. Box 936
		DATE	REVISION	BY	APP'D	Ferndale, Washington 98248








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253-236-4941 tel.	hte@comcast.net


ı	I-5 MP 263.48		
	I-5 NB RAMPS/PORTAL WAY	SS2	
	FERNDALE, WHATCOM COUNTY MARCH, 2018	SHEET	
	SIGN SPECIFICATIONS	OF	

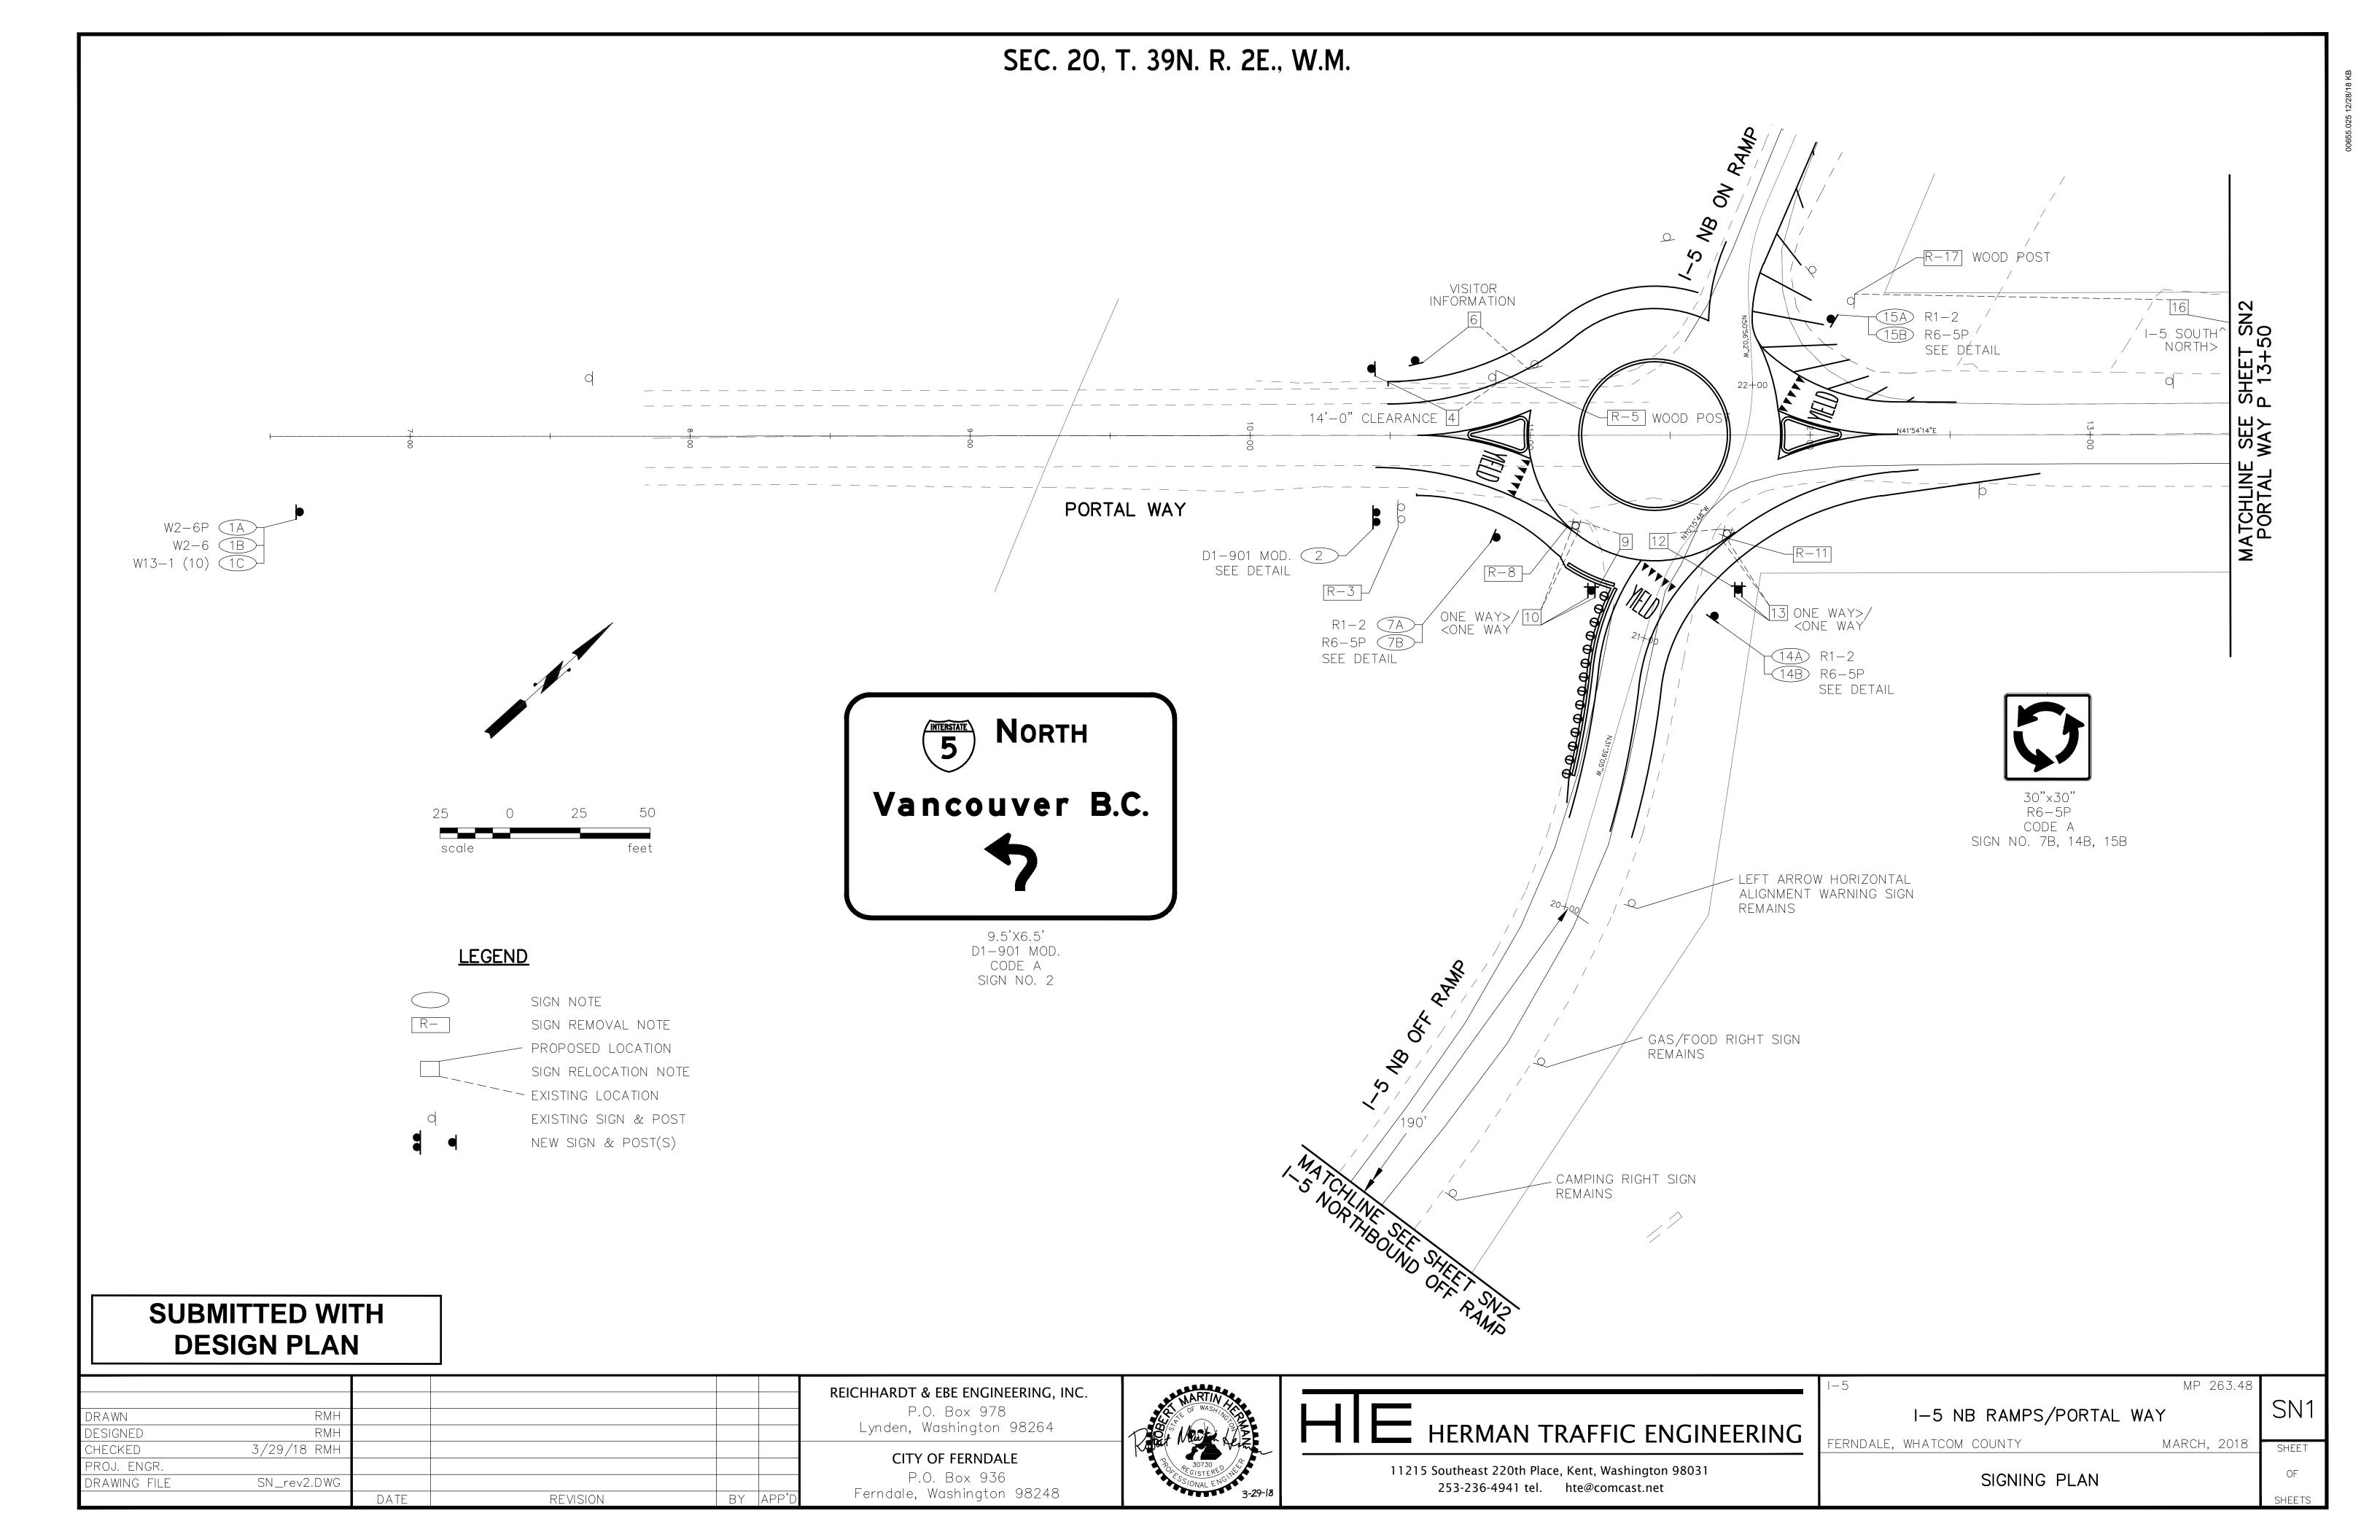

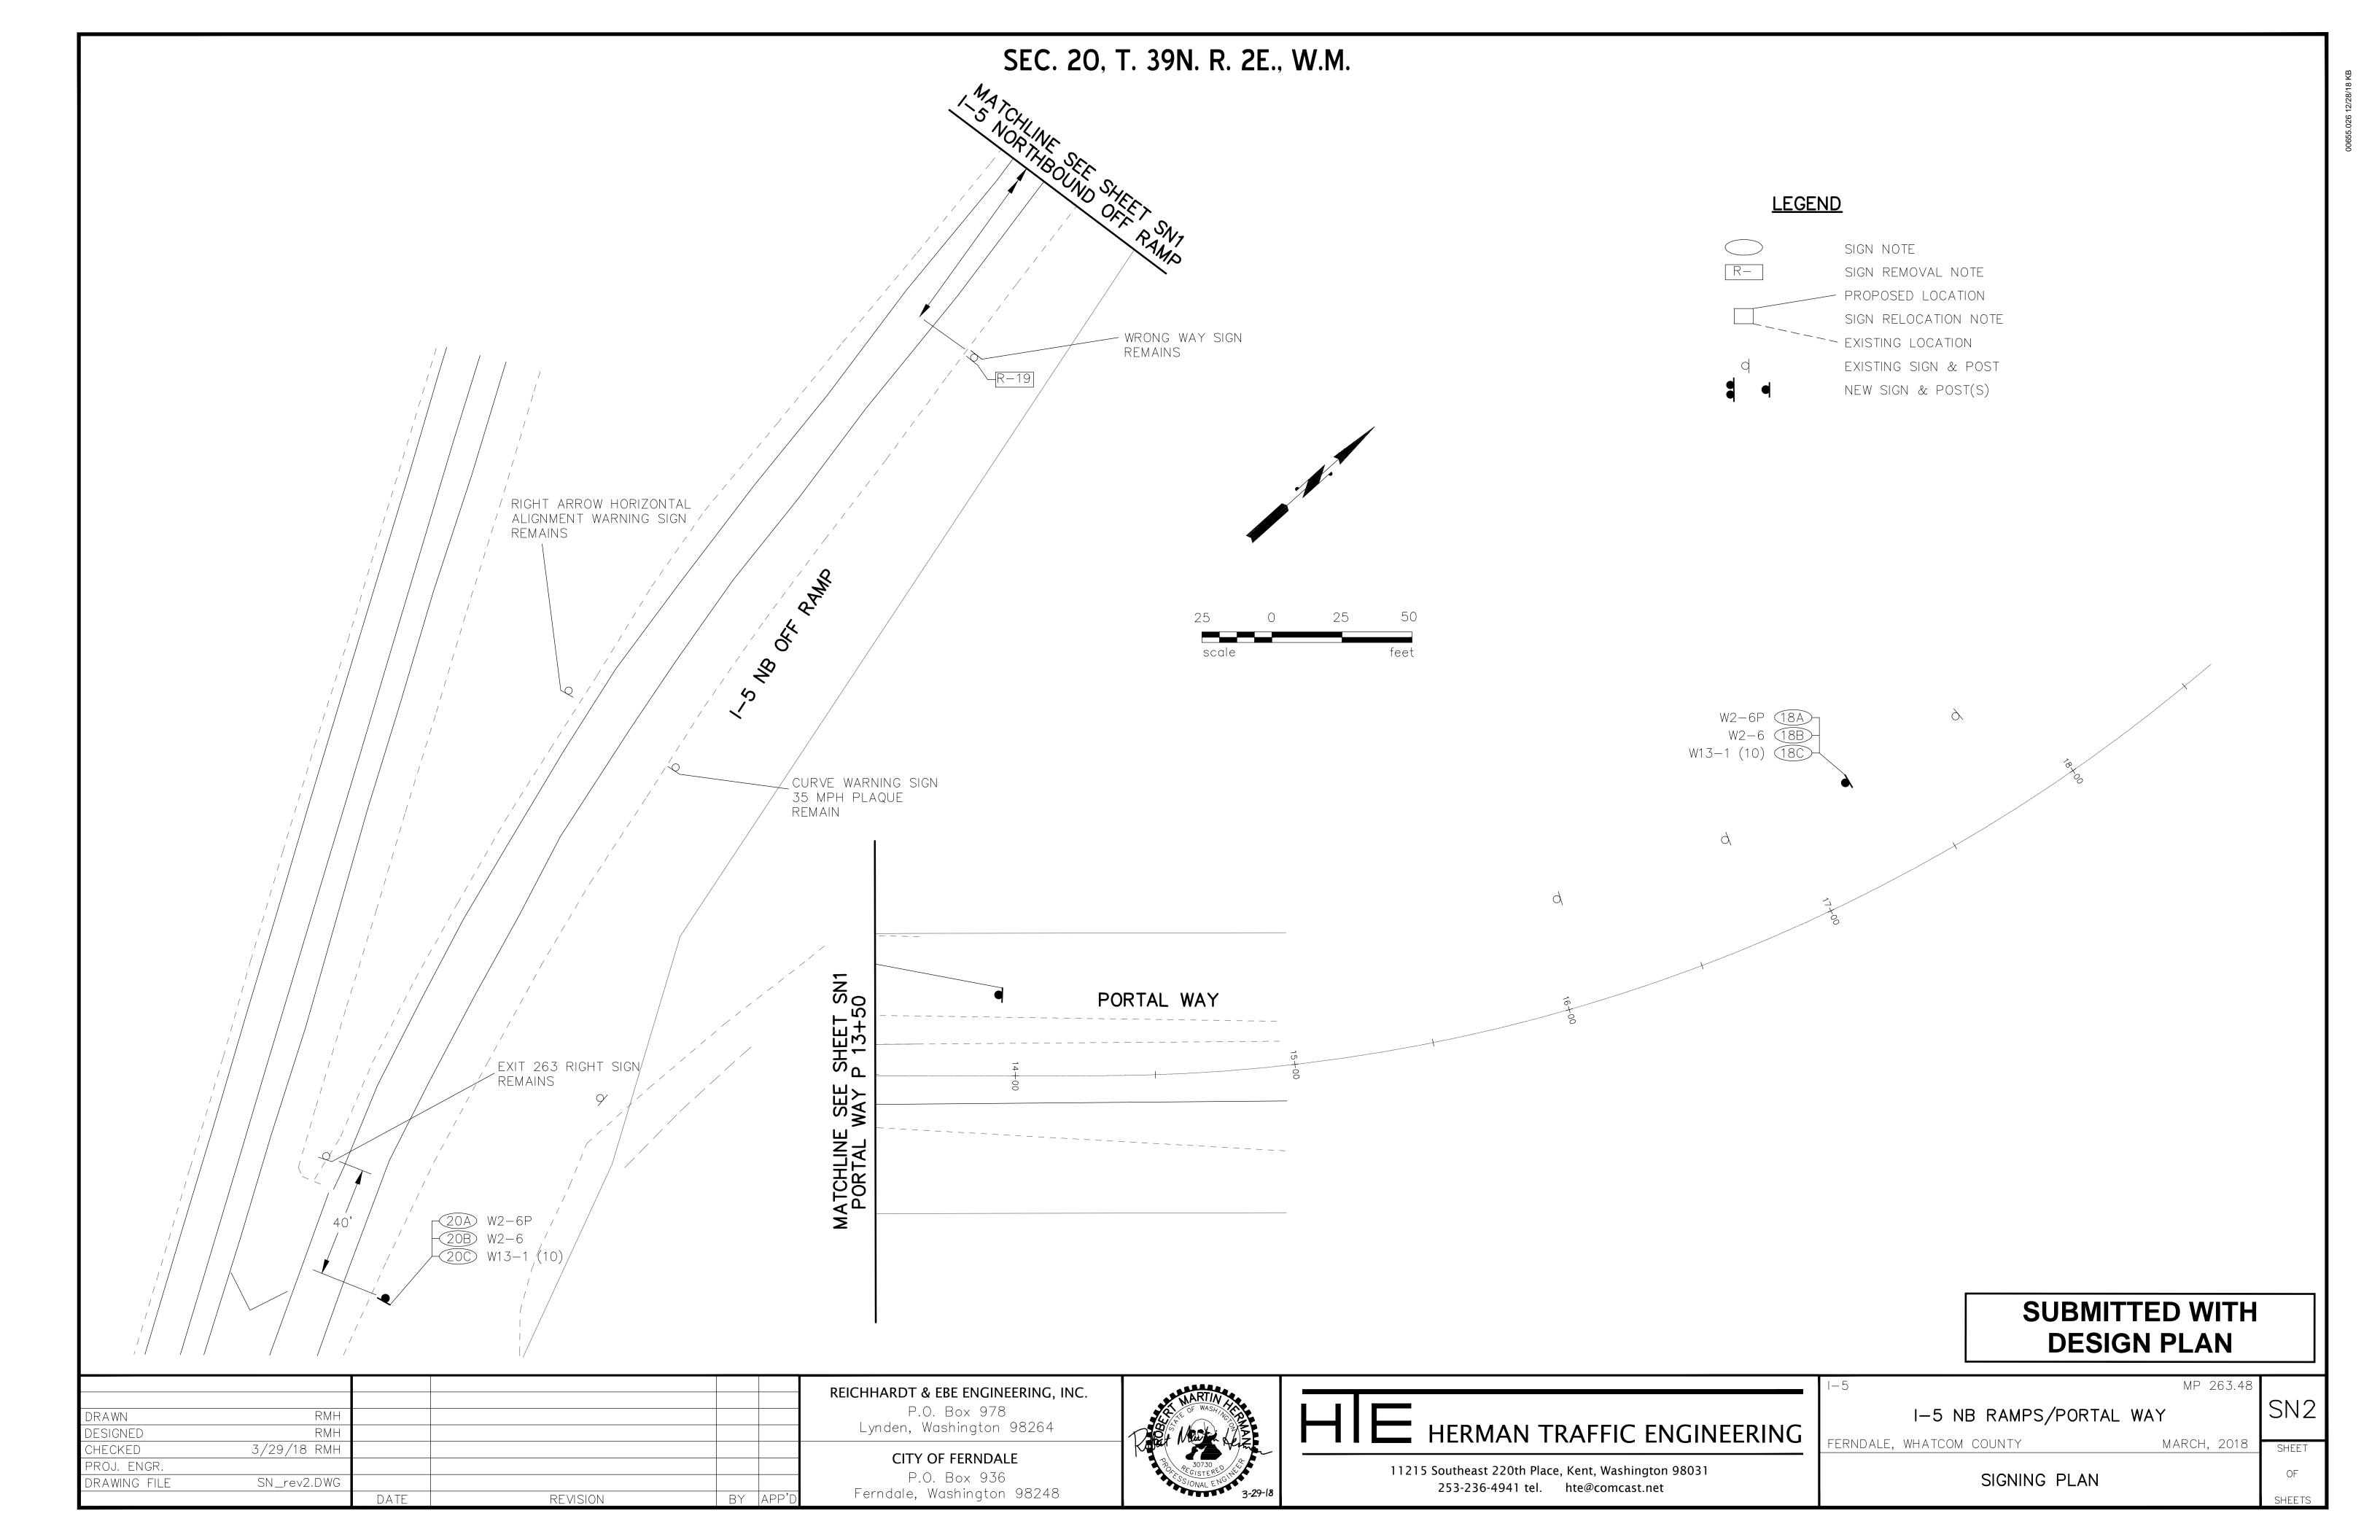

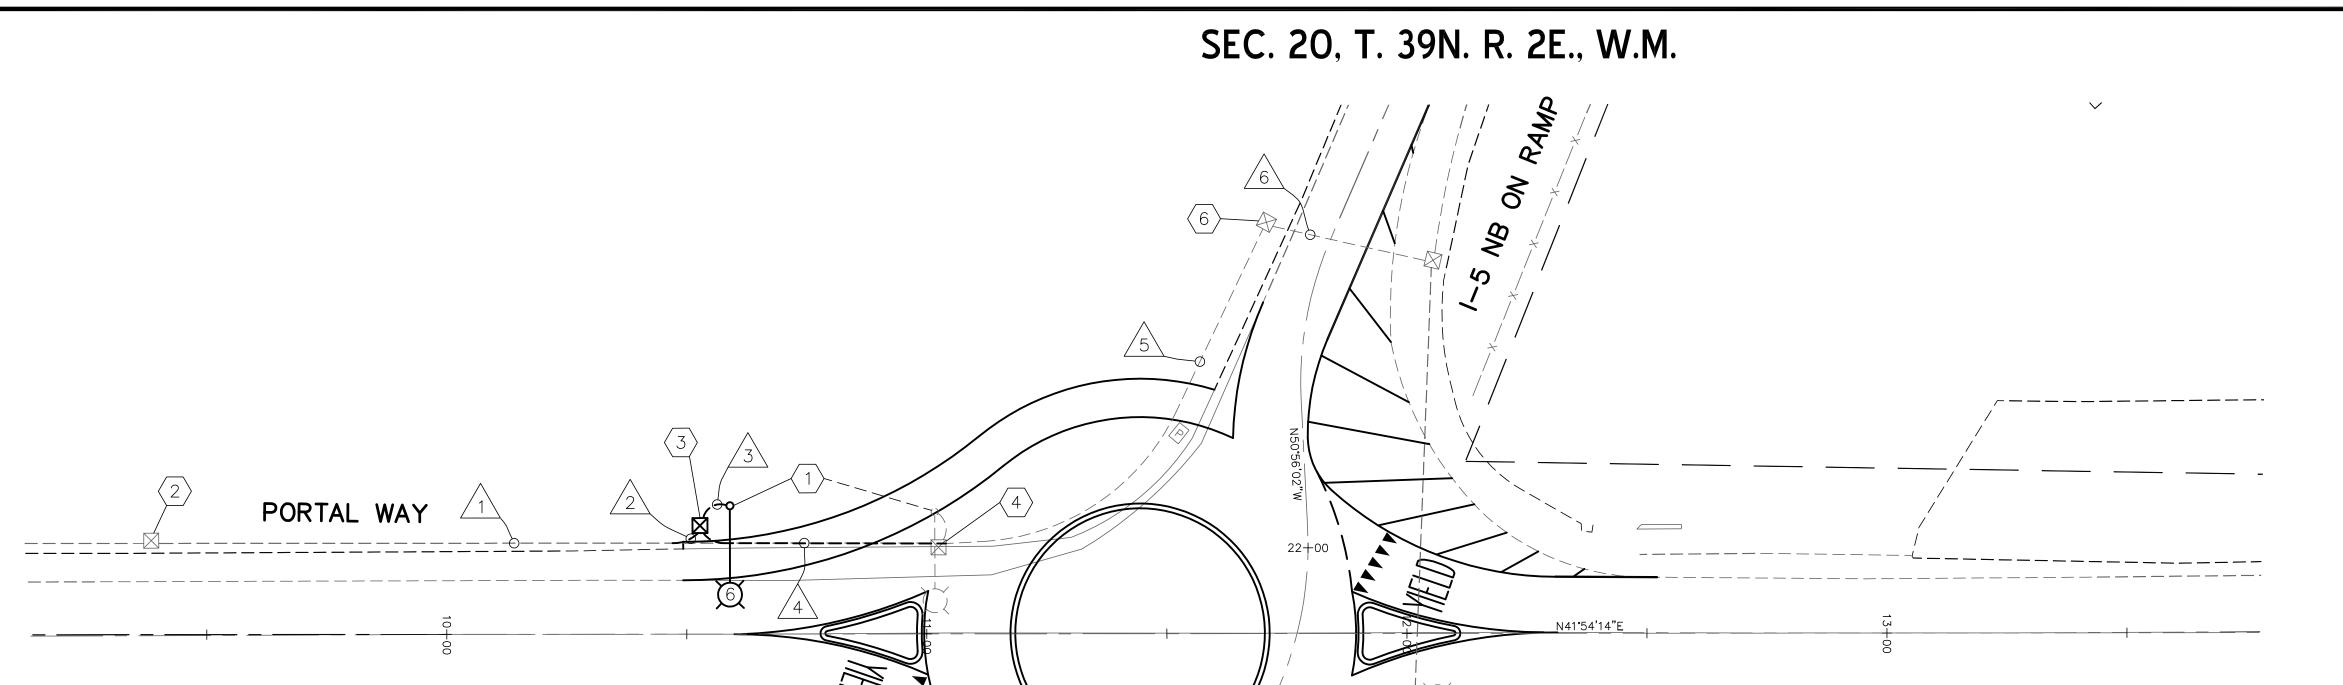

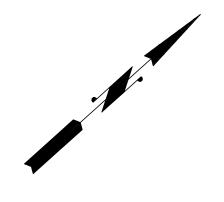

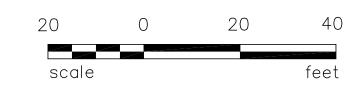

### <u>LEGEND</u>

<u>EXISTING</u>	<u>PROPOSED</u>	
·	$\overset{\bullet}{\smile}$	LIGHT STANDARD AND LUMINAIR
		TYPE 1 JUNCTION BOX
		CONDUIT
		CONSTRUCTION NOTE
		WIRE NOTE

### **GENERAL NOTES**

- 1. ALL WORK SHALL BE PERFORMED IN ACCORDANCE WITH THE 2016 WSDOT STANDARD SPECIFICATIONS FOR ROAD, BRIDGE AND MUNICIPAL CONSTRUCTION AND ITS AMENDMENTS, SPECIAL PROVISIONS, WSDOT STANDARD PLANS AND NATIONAL ELECTRICAL CODE (ALL CURRENT VERSIONS).
- 2. WORK SHALL BE STAGED SO NO PORTION OF EXISTING STREET LIGHTING SYSTEM IS INOPERABLE DURING HOURS OF DARKNESS.
- 3. INSTALL A ONE FOOT WIDE AND ONE FOOT DEEP RECTANGULAR CONCRETE COLLAR AROUND THE PERIMETER OF EACH NEW TYPE 1 AND TYPE 2 JUNCTION BOX INSTALLED IN GRADE. THE EXPOSED PORTIONS SHALL BE FORMED TO HAVE A NEAT APPEARANCE. THE TOP EDGES SHALL HAVE A 3/4—INCH CHAMFER ON THE TOP EDGE OF THE FOUNDATION. THE CONCRETE MIX DESIGN SHALL BE COMMERCIAL CONCRETE PER STANDARD SPECIFICATION 6—02.3(2)B.

#### **CONSTRUCTION NOTES**

- CONSTRUCT FOUNDATION AND RELOCATE EXISTING LIGHT STANDARD AND LUMINAIRE TO NEW FOUNDATION. REMOVE EXISTING FOUNDATION IN ITS ENTIRETY. SEE LUMINAIRE SCHEDULE. USE WSDOT STANDARD PLAN J-28.30-03.
- (2) DISCONNECT EXISTING CONDUCTORS AT JUNCTION BOX TO EAST AND PULL BACK TO JUNCTION BOX. REPULL EXISTING CONDUCTORS THROUGH NEW CONDUIT TO NEW JUNCTION BOX TO EAST.
- $\sqrt{3}$  intercept existing conduit and sweep into new junction box (west run only). Install other conduit and conductors per wiring schedule.
- REMOVE EXISTING JUNCTION BOX, CONDUIT SWEEPS AND CONDUCTORS. EXTEND EXISTING CONDUIT WEST TO JUNCTION BOX AT NEW LIGHT STANDARD LOCATION. ABANDON EXISTING CONDUIT TO WEST.
- $\langle 5 \rangle$  ADJUST EXISTING JUNCTION BOX TO GRADE.
- $\langle 6 \rangle$  splice existing conductors to new conductors in existing junction box.

# SUBMITTED WITH DESIGN PLAN

#### LUMINAIRE SCHEDULE

ELECTRICAL SERVICE CABINET FOR THIS ILLUMINATION SYSTEM (SAA967) IS LOCATED APPROXIMATELY 630' SOUTH OF YIELD

LINE OFF EAST SHOULDER IN FENCE LINE.

PORTAL WAY

LUM.				MAST ARM		FOUNDATION	
NO.	POLE LOCATION	CIRCUITS	TYPE-DISTRIBUTION-WATTAGE	LENGTH	H1	TYPE	BASE TYPE
6	STA 10+59.00, 26.73' LT.	EX A	EX	EX	EX	В	EX

#### WIRING SCHEDULE

CONDUIT	CONDUIT	CONDU	JCTORS		
RUN	SIZE	ILLUM	GROUND		
$\triangle$		#8	#8	CIRCUIT	REMARKS
1	EX 1.25"	EX 2	EX 1	В	REMOVE AND REPULL EX CONDUCTORS
2	1.25"	EX 2	EX 1	В	REROUTE EX CONDUCTORS THRU NEW CONDUIT
3	1"	2	1	Α	
4	1.25"	4	1	A,B	EXTEND EX CONDUIT TO NEW JUNCTION BOX
5	EX 1.25"	4	1	A,B	REPLACE EX CONDUCTORS
6	EX 2"	EX 4	EX 1	A,B	EX CONDUIT AND CONDUCTORS REMAIN

NOTE: WHERE EXISTING CONDUITS WILL BE EXTENDED, CONTRACTOR SHALL VERIFY EXISTING CONDUIT TYPE AND SIZE PRIOR TO PROCURING MATERIALS.

DRAWN	RMH				
DESIGNED	RMH				
CHECKED	3/29/18 RMH				
PROJ. ENGR.					
DRAWING FILE	IL_rev2.DWG				
		DATE	REVISION	BY	APP'D

REICHHARDT & EBE ENGINEERING, INC.
P.O. Box 978
Lynden, Washington 98264

CITY OF FERNDALE

P.O. Box 936 Ferndale, Washington 98248



HERMAN TRAFFIC ENGINEERING

11215 Southeast 220th Place, Kent, Washington 98031 253-236-4941 tel. hte@comcast.net

I-5 MP 263.48	
I-5 NB RAMPS/PORTAL WAY	IL1
FERNDALE, WHATCOM COUNTY MARCH, 2018	SHEET
ILLUMINATION PLAN	OF

SHEETS

# SEC. 20, T. 39N. R. 2E., W.M.

#### 1. ALL WORK SHALL BE PERFORMED IN ACCORDANCE WITH THE 2016 WSDOT STANDARD SPECIFICATIONS FOR ROAD, BRIDGE AND MUNICIPAL CONSTRUCTION AND ITS AMENDMENTS, SPECIAL PROVISIONS, WSDOT STANDARD PLANS AND NATIONAL ELECTRICAL CODE (ALL CURRENT VERSIONS).

- 2. A SINGLE CONTINUOUS SHUTDOWN OF THE WSDOT FIBER NETWORK SHALL ONLY BE ALLOWED FROM MONDAY NIGHT 9:00 PM TO FOLLOWING THURSDAY MORNING 6:00 AM. WEEKS WHEN SHUTDOWN WILL NOT BE ALLOWED ARE:
  - SEPTEMBER 1-11
  - OCTOBER 5-16 ● NOVEMBER 16-27


  - DECEMBER 21-JANUARY 8

SHUTDOWN OF ITS DETECTOR LOOPS SHALL BE LIMITED TO FIVE DAYS.

#### **CONSTRUCTION NOTES**

**GENERAL NOTES** 

- DISCONNECT AND REMOVE EXISTING LOOP LEAD-IN CABLE(S) IN EXISTING JUNCTION BOX. RE-INSTALL EXISTING CABLE(S) AND SPLICE TO EXISTING LOOP WIRES PER EXISTING CONDITION.
- DISCONNECT AND REMOVE EXISTING 48 SMFO CABLE (SOUTH) IN EXISTING CABLE VAULT. RE-INSTALL EXISTING CABLE AND SPLICE TO 48 SMFO CABLE (NORTH) AND 24 PPP PER EXISTING CONDITION.
- 3 PULL EXISTING LOOP LEAD—IN CABLES (TOTAL OF SIX) BACK TO EXISTING JUNCTION BOX. PROTECT CABLES FOR RE—INSTALLATION.
- 4 PULL EXISTING 48 SMFO CABLE BACK TO EXISTING PULL BOX. PROTECT CABLE FOR RE-INSTALLATION.
- REMOVE EXISTING 48 SMFO CABLE AND LOOP LEAD-IN CABLES (TOTAL OF SIX) FROM EXISTING PULL BOX. RELOCATE PULL BOX TO STA. A 23+00, 15' LT. ADJUST ALL CONDUIT ENTERING PULL BOX. RE-INSTALL EXISTING CABLES PER WIRING SCHEDULE.

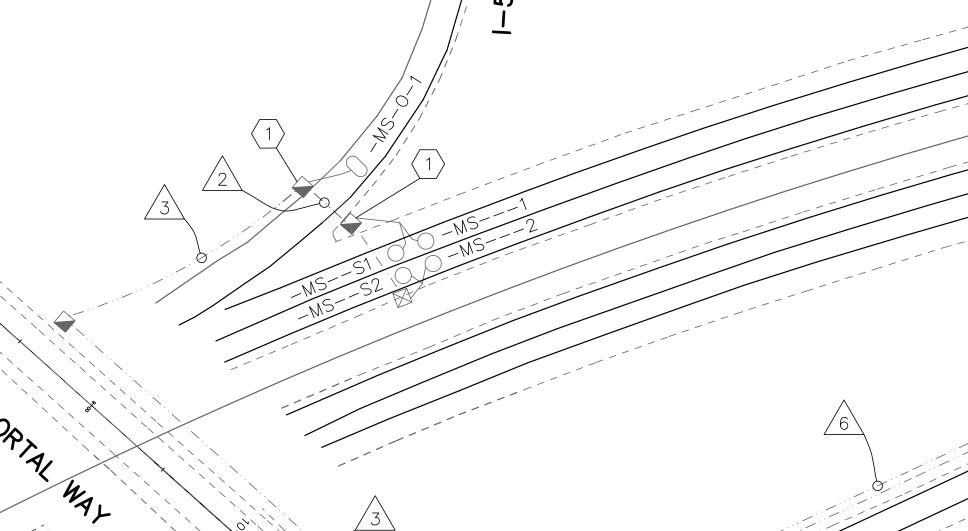

**LEGEND** 

I-5 SB OFF RAMP

**EXISTING** PROPOSED PB

005vc26363

DETECTOR LOOP TYPE 3 DETECTOR LOOP TYPE WR PULL BOX

005xf26363

TYPE 1 JUNCTION BOX TYPE 2 JUNCTION BOX SERVICE CABINET TRANSFORMER CABINET CCTV CAMERA

CCTV CONTROL CABINET ES CONTROL CABINET

CONSTRUCTION NOTE

CONDUIT

WIRE NOTE

## WIRING SCHEDULE

CONDUIT RUN	EXISTING CONDUIT	EXISTING INNERDUCT	EXISTING CONDUCTORS	REMARKS
$\triangle$				
1	2"		1 - 2C (SH)	DETECTOR LEAD—IN, REMOVE AND RE—INSTALL
2	2"		4 - 2C (SH)	DETECTOR LEAD—IN, REMOVE AND RE—INSTALL
	2"			FUTURE USE
3	2"		5 - 2C (SH)	DETECTOR LEAD—IN, REMOVE AND RE—INSTALL
	2"			FUTURE USE
4	2"		2 - 48 SMFO	DISTRIBUTION FIBER, REMOVE AND RE-INSTALL 1 - 48 SMFO (S)
	2"			FUTURE USE
5	4"	А	1 - 48 SMFO	DISTRIBUTION FIBER, REMOVE AND RE-INSTALL
		В		FUTURE USE
		С		FUTURE USE
		D		FUTURE USE
6	2"		6 - 2C (SH)	DETECTOR LEAD—IN, REMOVE AND RE—INSTALL
	2"			FUTURE USE

# **SUBMITTED WITH DESIGN PLAN**

DRAWN	RMH				
DESIGNED	RMH				
CHECKED	3/29/18 RMH				
PROJ. ENGR.					
DRAWING FILE	IT_rev2.DWG				
		DATE	DEVICION	DV	

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1-5 NB OFF RAMP

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1 0		1011 2
	I-5 NB RAMPS/PORTAL	WAY
FERNDALE,	WHATCOM COUNTY	MARCH,

ITS RELOCATION PLAN

MP 263.48 2018