
CONSTR. DOCS: SHEET INFORMATION 24"x36" SCALE: PLOT DATE:

PENCO/(CAPSTONE) BUILDING 'C' HAVE BEEN INSPECTED BY TERRAFORMA DESIGN GROUP AND TO THE BEST OF MY KNOWLEDGE, HAVE

GITY OF FERNDALE
PUBLIC WORKS DEPARTMENT

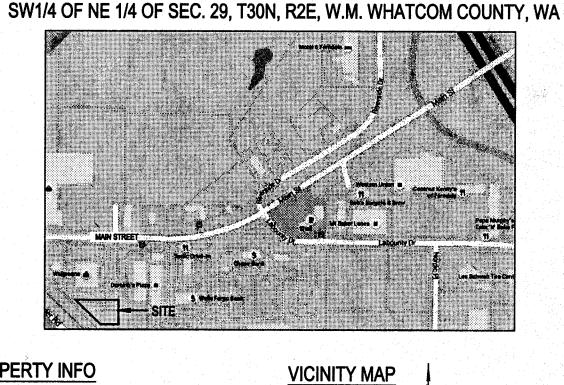

PROPERTY INFO

PROPERTY ID: 98545

PARCEL NO: 3902293303930000

LEGAL DESCRIPTION

LOT 3 WALGREEN'S LLA AS RECORDING WITH AUDITOR'S FILE NO. 2040402803, RECORDS OF WHATCOM COUNTY, WA.

VERTICAL DATUM

ASBUILT RIM OF SANITARY SEWER MANHOLE AS SHOWN ON SHEET 5 OF 30, MAIN STREET BRIDGE STREET IMPROVEMENTS AS PREPARED BY REICHHARDT & EBE ENGINEERING, INC. BENCHMARK: NORTH RIM OF SEWER MH NORTH OF NE PROPERTY CORNER ELEV= 30.70

BASIS OF BEARINGS:

N00'29'40"E BETWEEN THE NORTH 1/4 CORNER AND SOUTH 1/4 CORNER OF SECTION 29, TOWNSHIP 39 NORTH, RANGE 2 EAST, W.M. PER RECORD OF SURVEY IN BOOK 1 OF SURVEYS, AT PAGE 19 RECORDS OF WHATCOM COUNTY, WASHINGTON.

PROJECT DATA

SITE AREA: 65,894 SF (1.51 AC)

EARTHWORK QUANTITIES: SITE STRIPPING = 149 BCY

SUBGRADE CUT = 114 BCY SUBGRADE FILL = 1110 BCY * FOR PERMIT USE ONLY

DISTURBANCE AREA: 41,762 SF = 0.96 AC

EX. IMPERVIOUS AREA: 13,163 SF PROP. IMPERVIOUS AREA: 48,054 SF NET CHANGE IMPERVIOUS AREA: +34,891 SF

PERCENT IMPERVIOUS:

REFER TO ARCHITECTURAL PLANS FOR SITE HORIZONTAL CONTROL AND ON-SITE SURFACE DETAILS (I.E. CURBS, WALKWAYS, STRIPING, SIGNAGE, ETC.)

GENERAL NOTES

EX. RETAIL 1873 MAIN STREET

156.33

EX. ACCESS

LANSCAPE PLANTINGS

PER SHT. L1.1

EX. RETAIL

- CONC. CURB

(TYP) PER ARCH. PLANS

- CONC. LANDING

LSC

CURB RAMP

(TYP) PER ARCH. PLANS

NEW BUILDING 'C'

FF= 33.20

-A.C. PAVING PER -DTL. 1/C1.1

W/ TRUNCATED

-A.C. PAVING PER

DTL. 1/C1.1

EX. PAVING

CONC. CURB & -

SIDEWALK PER

ARCH. PLANS

FINISH GRADE OR

TOOLED EDGES

-COMPACTED SUBGRADE

CEMENT CONCRETE, CLASS 3000

C1.1 SCALE: N.T.S.

CONC. CURB W/ GUTTER

SAWCUT & SEAL LINE

- 1. ALL WORK SHALL BE DONE IN ACCORDANCE WITH THE 2015 EDITION WSDOT (WASHINGTON STATE DEPARTMENT OF TRANSPORTATION STANDARD SPECIFICATIONS FOR ROAD, BRIDGE AND MUNICIPAL CONSTRUCTION), ITS CURRENT AMENDMENTS, ATTACHED SPECIAL PROVISIONS, WSDOT STANDARD PLANS AND DETAILS, CITY OF FERNDALE STANDARD DRAWINGS.
- 2. THE CONTRACTOR SHALL COORDINATE WITH THE PERTINENT UTILITY COMPANIES FOR THIS WORK.
- 3. THE CONTRACTOR SHALL HIRE A LICENSED SURVEYOR TO PROVIDE AN ASBUILT OF THE SITE IMPROVEMENTS WITH THE PROPERTY, STRUCTURE AND UTILITIES TIED TO THE CITY OF FERNDALE MONUMENT NETWORK AND VERTICAL DATUM (HORIZ. DATUM: NAD83/91, VERT. DATUM: NGVD29). PROVIDE TWO (2) TO CITY MONUMENT SYSTEM.
- 4. CONTRACTOR SHALL PROVIDE REDLINED AS-BUILTS OF ALL UTILITY AND DRAINAGE CONSTRUCTION. THE BUILDING FINISH FLOOR ELEVATION, STORM/SEWER RIM & INVERTS SHALL BE CERTIFIED BY THE CONTRACTOR'S SURVEYOR.

SHEET INDEX

- C1.1 PAVING PLAN C1.2 EX. CONDITIONS &
- EROSION CONTROL PLAN GRADING & DRAINAGE PLAN
- UTILITY PLAN
- CIVIL DETAILS & NOTES
- C1.6 CIVIL DETAILS
- A1.1 SITE PLAN
- A1.2 SITE DETAILS A1.3 SITE DETAILS
- LANDSCAPE PLANTING PLAN L1.2 LANDSCAPE DETAILS & NOTES

PROJECT TEAM

SCALE: N.T.S.

DEVELOPER CAPSTONE 360, LLC 8862 BENDER ROAD #102, LYNDEN, WA 98264 CONTACT: GREG PENNER PHONE: (360) 255-7864

CIVIL ENGINEER

TERRAFORMA DESIGN GROUP, INC. 5027 51ST AVENUE SW, SEATTLE, WA 98136 CONTACT: PEDRO DEGUZMAN, PE PHONE: (206) 923-0590 EMAIL: pedro@terraformadesigngroup.com

DANIEL B. TAYLOR, AIA 1639 HARBOR AVE SW, SEATTLE, WA 98126 PHONE: (206) 465-2491

GOVERNING AGENCIES

GRADING, DRAINAGE, WATER, SEWER CITY OF FERNDALE 2095 MAIN STREET FERNDALE, WA 98248 PHONE: (360) 685-2379

NATURAL GAS: CASCADE NATURAL GAS PHONE: (888) 522-1130


ELECTRIC: PUGET SOUND ENERGY PHONE: (888) 321-7779

POWER: PUGET SOUND ENERGY CONTACT: JERRY PARTLOW

PHONE: (360) 715-7234 TELEPHONE: VERIZON


CONTACT: BELINDA DAVIS PHONE: (360) 757-1479

CABLE TV: COMCAST CONTACT: BOB TIERNEY PHONE: (360) 527-8244

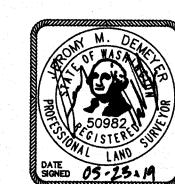

I CERTIFY TO THE BEST OF MY KNOWLEDGE THAT THE LOCATIONS, ELEVATIONS, DEPTHS, AND ASBUILT COMMENTS REFLECTING MATERIALS ACTUALLY USED DURING CONSTRUCTION ACCURATELY REFLECT EXISTING FIELD CONDITIONS AS DETERMINED BY ME OR UNDER MY DIRECT SUPERVISION ON THIS

DATE: 05 -23 -19

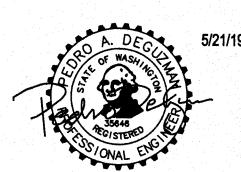

I HEREBY CERTIFY THAT THE IMPROVEMENTS II BEEN CONSTRUCTED IN CONFORMANCE WITH THE CITY OF FERNDALE DEVELOPMENT STANDARDS, THE CITY OF FERNDALE MUNICIPAL CODE, SUBSEQUENT STANDARDS ADOPTED BY REFERENCE THEREIN, AND STANDARD ENGINEERING PRACTICE.

APPROVED

PAVING PLAN

JOB NUMBER: 16004

DRAWN: PAD

DESIGN / CHECKED: PAD

1 inch = 100 ft.

LEGEND

PROPOSED

PROPERTY LINE

EASEMENT

CONCRETE

A.C. PAVING

MAIN STREET

EX. WALGREENS

SITE MAP

BUILDING 'C'

A.C. PAVING

SOIL SUBGRADE THE THE THE

HOT MIX ASPHALT - CLASS 1/2" (2" THICK - PARKING; 3" THICK - DRIVE AISLES)

PAVING SECTION (ON-SITE)

OVER 6" TOP COURSE CRUSHED SURFACING PER WSDOT SPEC. 9-03.9(3),

OVER COMPACTED SUBGRADE, 95% OF MAX. DRY DENSITY (ASTM D1557)

NOTE: FOR ADDITIONAL PAVING AND COMPACTION REQUIREMENTS,

REFER TO GEOTECHNICAL REPORT.

SCALE: N.T.S.

CRUSHED ROCK BASE

EX. PEOPLE'S BANK

EXISTING

EX. WALGREENS 1901 MAIN STREET

SAWCUT & SEAL LINE

TRASH ENCLOSURE -PER ARCH. PLANS

226.50 N90°00'00"E

- CONC. CURB

(TYP) PER ARCH. PLANS

CURB AROUND -CATCH BASIN

CONC. CURB & GUTTER -

1 inch = 20 ft.

PER DTL. 2/C1.1

CURB RAMP

(TYP) PER ARCH. PLANS

CONC. WALKWAY

(TYP) PER ARCH.

CONC. CURB & -

SIDEWALK PER

ARCH. PLANS

CAD FILE:

STATUS:


DESIGN / CHECKED: PAD

DRAWN: PAD

SHEET INFORMATIO 24"x36" SCALE: PLOT DATE: JOB NUMBER: 16004

STANDARD ENGINEERING PRACTICE.

APPROVED

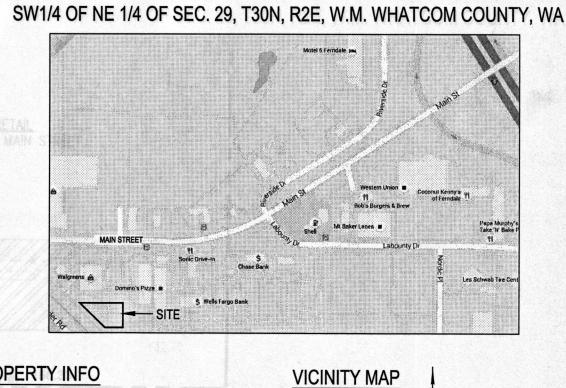

SCALE: N.T.S.

PROJECT TEAM

CAPSTONE 360, LLC

CONTACT: GREG PENNER PHONE: (360) 255-7864

TERRAFORMA DESIGN GROUP, INC.

CONTACT: PEDRO DEGUZMAN, PE

PHONE: (206) 923-0590

DANIEL B. TAYLOR, AIA

PHONE: (206) 465-2491

CITY OF FERNDALE

2095 MAIN STREET

FERNDALE, WA 98248 PHONE: (360) 685-2379

PHONE: (888) 522-1130

PHONE: (888) 321-7779

GOVERNING AGENCIES

GRADING, DRAINAGE, WATER, SEWER

NATURAL GAS: CASCADE NATURAL GAS

ELECTRIC: PUGET SOUND ENERGY

POWER: PUGET SOUND ENERGY

CONTACT: JERRY PARTLOW PHONE: (360) 715-7234

TELEPHONE: VERIZON

CONTACT: BELINDA DAVIS

8862 BENDER ROAD #102, LYNDEN, WA 98264

5027 51ST AVENUE SW, SEATTLE, WA 98136

EMAIL: pedro@terraformadesigngroup.com

1639 HARBOR AVE SW, SEATTLE, WA 98126

<u>DEVELOPER</u>

CIVIL ENGINEER

PROPERTY INFO

PARCEL NO: 3902293303930000

LEGAL DESCRIPTION

WITH AUDITOR'S FILE NO. 2040402803. RECORDS OF WHATCOM COUNTY, WA.

ASBUILT RIM OF SANITARY SEWER MANHOLE AS SHOWN ON SHEET 5 OF 30, MAIN STREET BRIDGE STREET IMPROVEMENTS AS PREPARED BY REICHHARDT & EBE ENGINEERING, INC. BENCHMARK: NORTH RIM OF SEWER MH NORTH OF NE PROPERTY CORNER ELEV= 30.70

BASIS OF BEARINGS:

N00°29'40"E BETWEEN THE NORTH 1/4 CORNER AND SOUTH 1/4 CORNER OF SECTION 29, TOWNSHIP 39 NORTH, RANGE 2 EAST, W.M. PER RECORD OF SURVEY IN BOOK 1 OF SURVEYS, AT PAGE 19 RECORDS OF WHATCOM COUNTY, WASHINGTON.

SITE AREA: 65,894 SF (1.51 AC)

48,054 SF NET CHANGE IMPERVIOUS AREA: +34,891 SF

PERCENT IMPERVIOUS: 73%

> REFER TO ARCHITECTURAL PLANS FOR SITE HORIZONTAL CONTROL AND ON-SITE SURFACE DETAILS (I.E. CURBS, WALKWAYS, STRIPING, SIGNAGE, ETC.)

GENERAL NOTES

- 1. ALL WORK SHALL BE DONE IN ACCORDANCE WITH THE 2015 EDITION WSDOT (WASHINGTON STATE DEPARTMENT OF TRANSPORTATION STANDARD SPECIFICATIONS FOR ROAD, BRIDGE AND MUNICIPAL CONSTRUCTION), ITS CURRENT AMENDMENTS, ATTACHED SPECIAL PROVISIONS, WSDOT STANDARD PLANS AND DETAILS, CITY OF FERNDALE STANDARD DRAWINGS.
- 2. THE CONTRACTOR SHALL COORDINATE WITH THE PERTINENT UTILITY COMPANIES FOR THIS WORK.
- 3. THE CONTRACTOR SHALL HIRE A LICENSED SURVEYOR TO PROVIDE AN ASBUILT OF THE SITE IMPROVEMENTS WITH THE PROPERTY, STRUCTURE AND UTILITIES TIED TO THE CITY OF FERNDALE MONUMENT NETWORK AND VERTICAL DATUM (HORIZ. DATUM: NAD83/91, VERT. DATUM: NGVD29). PROVIDE TWO (2) TO CITY MONUMENT SYSTEM.
- 4. CONTRACTOR SHALL PROVIDE REDLINED AS-BUILTS OF ALL UTILITY AND DRAINAGE CONSTRUCTION. THE BUILDING FINISH FLOOR ELEVATION, STORM/SEWER RIM & INVERTS SHALL BE CERTIFIED BY THE CONTRACTOR'S SURVEYOR.

SHEET INDEX

- C1.1 PAVING PLAN C1.2 EX. CONDITIONS & EROSION CONTROL PLAN GRADING & DRAINAGE PLAN
- C1.4 UTILITY PLAN
- CIVIL DETAILS & NOTES C1.6 CIVIL DETAILS
- A1.1 SITE PLAN SITE DETAILS A1.2
- A1.3 SITE DETAILS
- L1.1 LANDSCAPE PLANTING PLAN L1.2 LANDSCAPE DETAILS & NOTES

PROPERTY ID: 98545

LOT 3 WALGREEN'S LLA AS RECORDING

VERTICAL DATUM

PROJECT DATA


EARTHWORK QUANTITIES: SITE STRIPPING = 149 BCY SUBGRADE CUT = 114 BCY SUBGRADE FILL = 1110 BCY * FOR PERMIT USE ONLY

DISTURBANCE AREA: 41,762 SF = 0.96 AC

EX. IMPERVIOUS AREA: PROP. IMPERVIOUS AREA:


PHONE: (360) 757-1479

CABLE TV: COMCAST CONTACT: BOB TIERNEY PHONE: (360) 527-8244

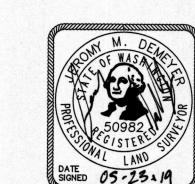


I CERTIFY TO THE BEST OF MY KNOWLEDGE THAT THE LOCATIONS. ELEVATIONS, DEPTHS, AND ASBUILT COMMENTS REFLECTING MATERIALS ACTUALLY USED DURING CONSTRUCTION ACCURATELY REFLECT EXISTING FIELD CONDITIONS AS DETERMINED BY ME OR UNDER MY DIRECT SUPERVISION ON THIS


DATE: 05 -23 -19

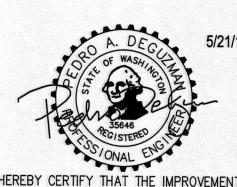

PENCO/(CAPSTONE) BUILDING 'C' HAVE BEEN INSPECTED BY TERRAFORMA DESIGN GROUP AND TO THE BEST OF MY KNOWLEDGE, HAVE BEEN CONSTRUCTED IN CONFORMANCE WITH THE CITY OF FERNDALE DEVELOPMENT STANDARDS, THE CITY OF FERNDALE MUNICIPAL CODE, SUBSEQUENT STANDARDS ADOPTED BY REFERENCE THEREIN, AND

PAVING PLA

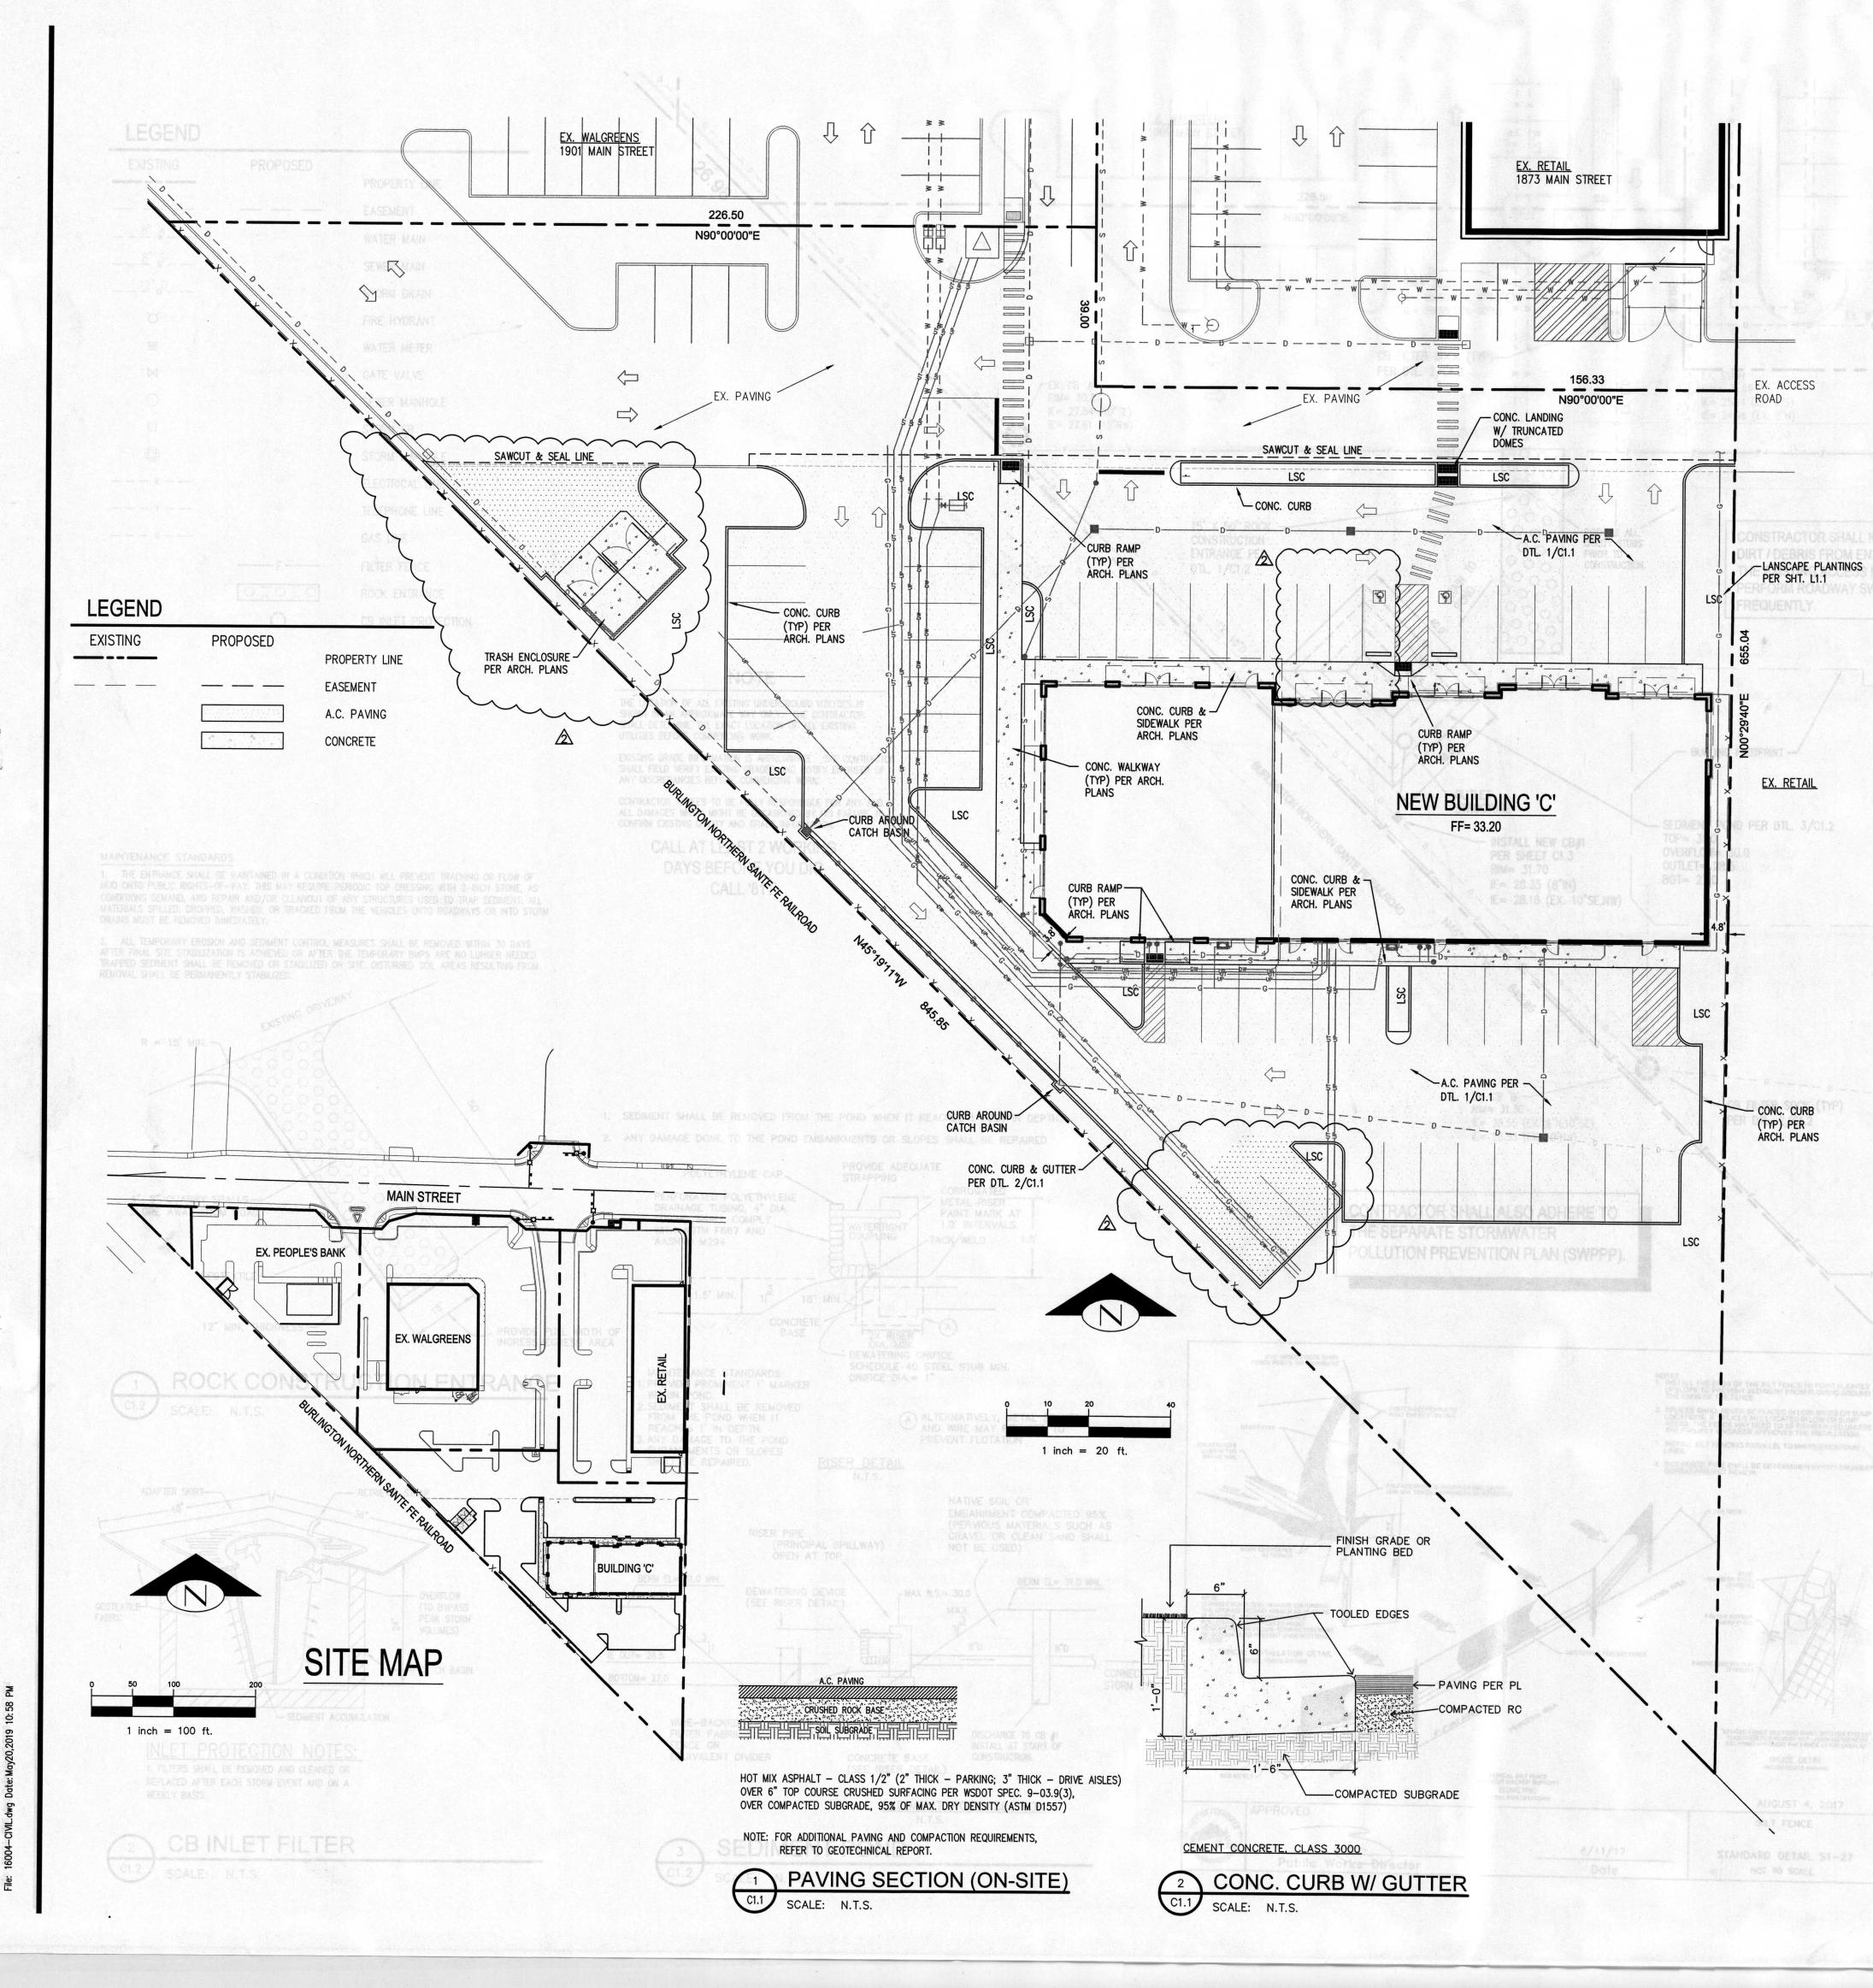

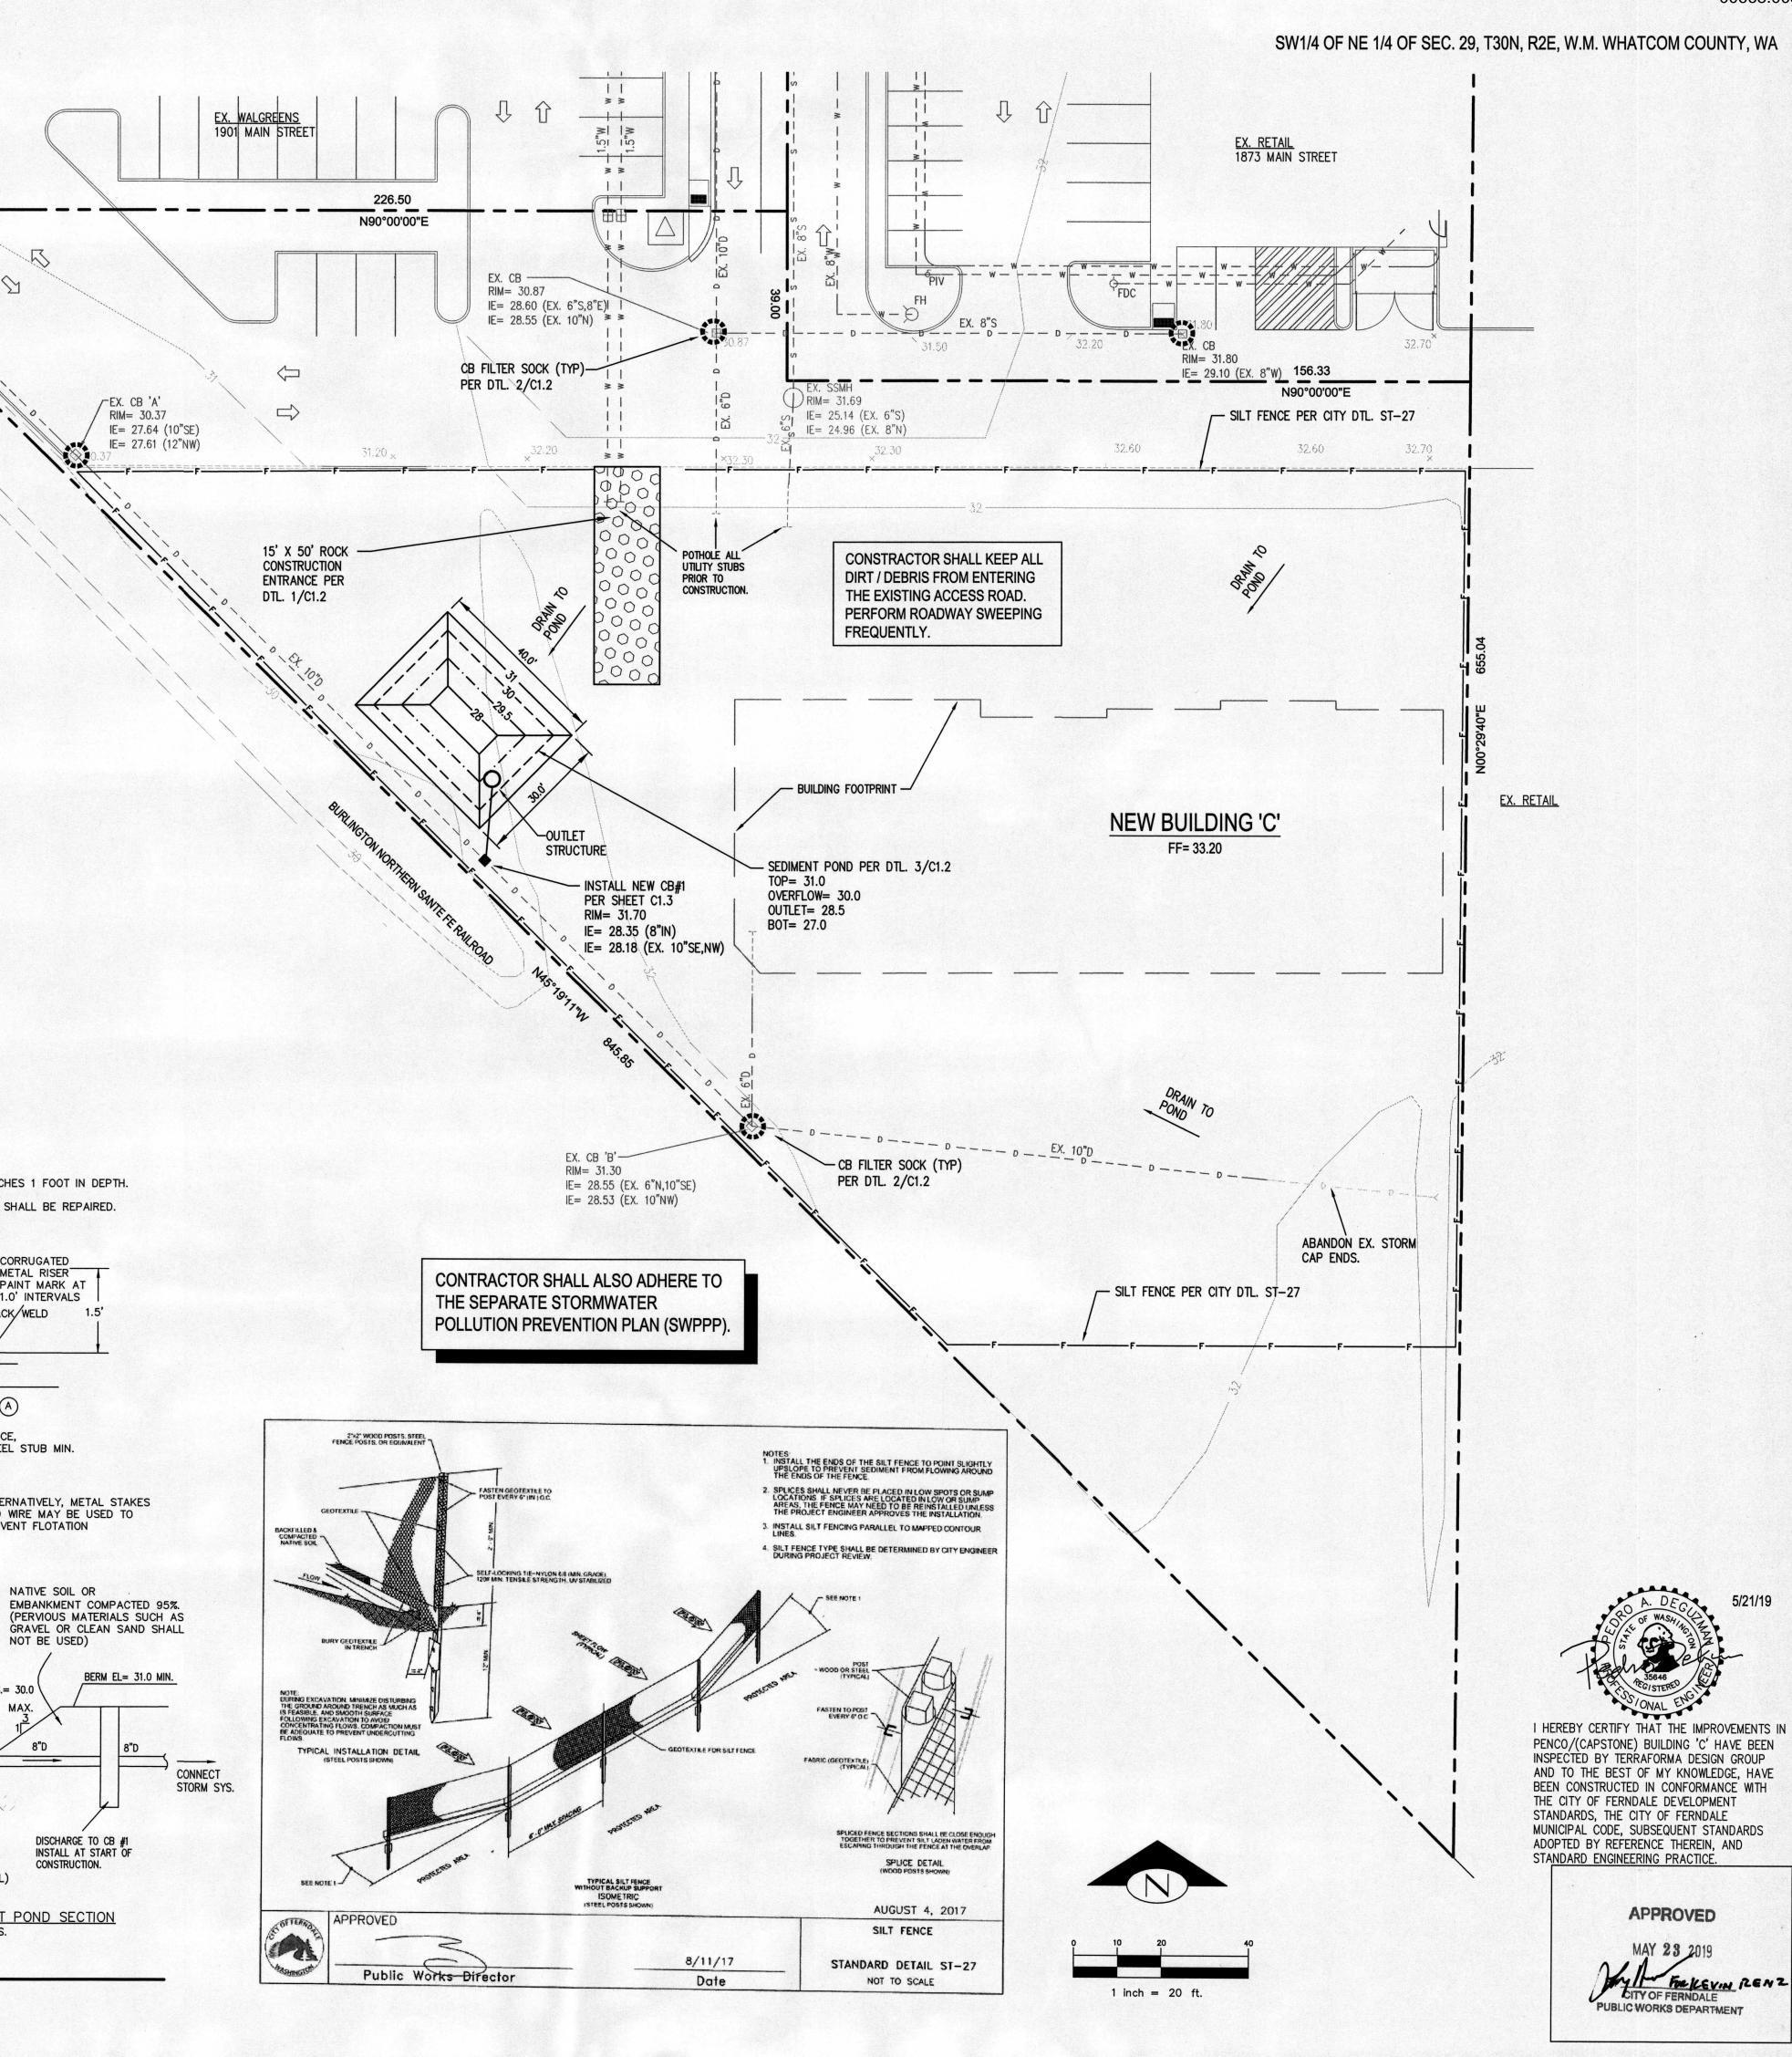

LEGEND

EXISTING PROPOSED PROPERTY LINE ____ EASEMENT _____ <u>8"</u> W_____ WATER MAIN _____8" \$____ SEWER MAIN ___12"_pD____ STORM DRAIN FIRE HYDRANT WATER METER GATE VALVE SEWER MANHOLE STORM CB STORM MANHOLE --- E ---ELECTRICAL LINE --- T---TELEPHONE LINE ___ G ___ GAS LINE —— F ——— FILTER FENCE ROCK ENTRANCE 0 CB INLET PROTECTION

EX. CB 'A' RIM= 30.37

NOTE

EXISTING GRADE INFORMATION IS APPROXIMATE. THE CONTRACTOR SHALL FIELD VERIFY EXISTING GRADES AND NOTIFY ENGINEER OF

CONTRACTOR AGREES TO BE FULLY RESPONSIBLE FOR ANY AND

ALL DAMAGES WHICH MIGHT BE OCCASIONED BY HIS FAILURE TO

CALL AT LEAST 2 WORKING

DAYS BEFORE YOU DIG

CALL '811'

POLYETHYLENE CAP

PERFORATED POLYETHYLENE DRAINAGE TUBING, 4" DIA.

MAINTENANCE STANDARDS: 1. PROVIDE PROMINENT 1' MARKER

2. SEDIMENT SHALL BE REMOVED FROM THE POND WHEN IT REACHES 1' IN DEPTH.

3. ANY DAMAGE TO THE POND

WIRE-BACKED /

EQUIVALENT DIVIDER

FILTER FABRIC

FENCE OR

SHALL BE REPAIRED.

EMBANKMENTS OR SLOPES

RISER PIPE

DEWATERING DEVICE

(SEE RISER DETAIL)

WITHIN POND.

IE OUT= 28.5

BOTTOM= 27.0

TUBING SHALL COMPLY

WITH ASTM F667 AND AASHTO M294

1. SEDIMENT SHALL BE REMOVED FROM THE POND WHEN IT REACHES 1 FOOT IN DEPTH.

PROVIDE ADEQUATE

DEWATERING ORIFICE,

ORIFICE DIA.= 1"

RISER DETAIL N.T.S.

(PRINCIPAL SPILLWAY)
OPEN AT TOP

DEWATERING

SEDIMENT POND

CONCRETE BASE

(SEE RISER DETAIL)

SCHEDULE 40 STEEL STUB MIN.

-MAX W.S.= 30.0

CORRUGATED

PAINT MARK AT

1.0' INTERVALS

ALTERNATIVELY, METAL STAKES AND WIRE MAY BE USED TO

NATIVE SOIL OR

NOT BE USED)

DISCHARGE TO CB #1

INSTALL AT START OF

CONSTRUCTION.

PREVENT FLOTATION

METAL RISER

2. ANY DAMAGE DONE TO THE POND EMBANKMENTS OR SLOPES SHALL BE REPAIRED.

THE LOCATION OF ALL EXISTING UNDERGROUND UTILITIES IS SHOWN IN AN APPROXIMATE WAY ONLY. THE CONTRACTOR SHALL DETERMINE THE EXACT LOCATION OF ALL EXISTING

UTILITIES BEFORE COMMENCING WORK.


ANY DISCREPANCIES BEFORE COMMENCING WORK.

CONFIRM EXISTING UTILITY AND GRADE INFORMATION.


MAINTENANCE STANDARDS 1. THE ENTRANCE SHALL BE MAINTAINED IN A CONDITION WHICH WILL PREVENT TRACKING OR FLOW OF MUD ONTO PUBLIC RIGHTS-OF-WAY. THIS MAY REQUIRE PERIODIC TOP DRESSING WITH 2-INCH STONE, AS CONDITIONS DEMAND, AND REPAIR AND/OR CLEANOUT OF ANY STRUCTURES USED TO TRAP SEDIMENT. ALL MATERIALS SPILLED, DROPPED, WASHED, OR TRACKED FROM THE VEHICLES ONTO ROADWAYS OR INTO STORM

DRAINS MUST BE REMOVED IMMEDIATELY.

2. ALL TEMPORARY EROSION AND SEDIMENT CONTROL MEASURES SHALL BE REMOVED WITHIN 30 DAYS AFTER FINAL SITE STABILIZATION IS ACHIEVED OR AFTER THE TEMPORARY BMPS ARE NO LONGER NEEDED. TRAPPED SEDIMENT SHALL BE REMOVED OR STABILIZED ON SITE. DISTURBED SOIL AREAS RESULTING FROM REMOVAL SHALL BE PERMANENTLY STABILIZED.

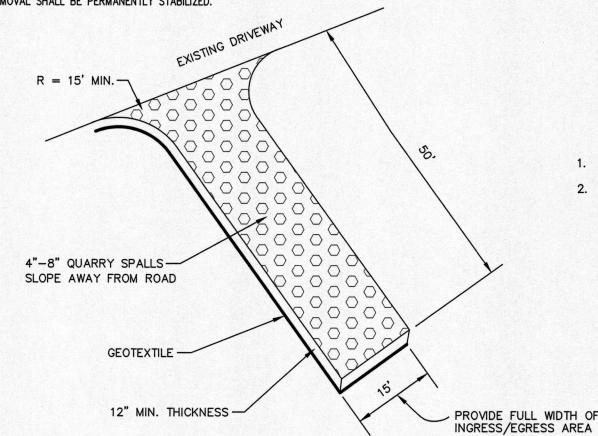

ROCK CONSTRUCTION ENTRANCE SCALE: N.T.S.

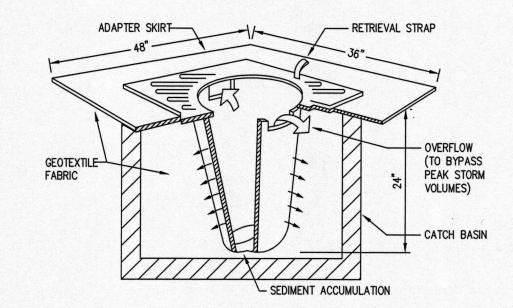

INLET PROTECTION NOTES: 1. FILTERS SHALL BE REMOVED AND CLEANED OR REPLACED AFTER EACH STORM EVENT AND ON A WEEKLY BASIS.

CB INLET FILTER

REVISIONS NO. DATE 12/18/17 | REV. PE 5/21/19 | CIVIL ASE

ISSUE DATES **DESIGN APPROVAL:** PERMIT SUBMITTAL:

PERMIT RECEIVED: BID DOCS:

CONSTR. DOCS: SHEET INFORMATION 24"x36" SCALE: PLOT DATE:

CAD FILE: JOB NUMBER: 16004 DESIGN / CHECKED: PAD

DRAWN: PAD STATUS:

EX. CONDITIO & EROSION CONTROL PLA

	REVI	SIONS
0.	DATE	В
/	12/18/17	REV. PE
7	5/21/19	CIVIL AS
\		
\		
\	10000000000000000000000000000000000000	
Σ.		

I CERTIFY TO THE BEST OF MY

DATE: 05-23-19

THE CITY OF FERNDALE DEVELOPMENT

ADOPTED BY REFERENCE THEREIN, AND

APPROVED

PUBLIC WORKS DEF

MAY 23 2019

My OF FERNON ZENZ

STANDARDS, THE CITY OF FERNDALE

STANDARD ENGINEERING PRACTICE.

KNOWLEDGE THAT THE LOCATIONS,

ELEVATIONS, DEPTHS, AND ASBUILT

COMMENTS REFLECTING MATERIALS ACTUALLY USED DURING CONSTRUCTION

ACCURATELY REFLECT EXISTING FIELD

CONDITIONS AS DETERMINED BY ME OR UNDER MY DIRECT SUPERVISION ON THIS ISSUE DATES


DESIGN APPROVAL: PERMIT SUBMITTAL: PERMIT RECEIVED: BID DOCS:

CONSTR. DOCS: SHEET INFORMATION 24"x36" SCALE:

I HEREBY CERTIFY THAT THE IMPROVEMENTS II PLOT DATE: PENCO/(CAPSTONE) BUILDING 'C' HAVE BEEN INSPECTED BY TERRAFORMA DESIGN GROUP CAD FILE: AND TO THE BEST OF MY KNOWLEDGE, HAVE JOB NUMBER: 16004 BEEN CONSTRUCTED IN CONFORMANCE WITH DESIGN / CHECKED: PAD MUNICIPAL CODE, SUBSEQUENT STANDARDS

DRAWN: PAD STATUS:

GRADING & DRAINAGE PL

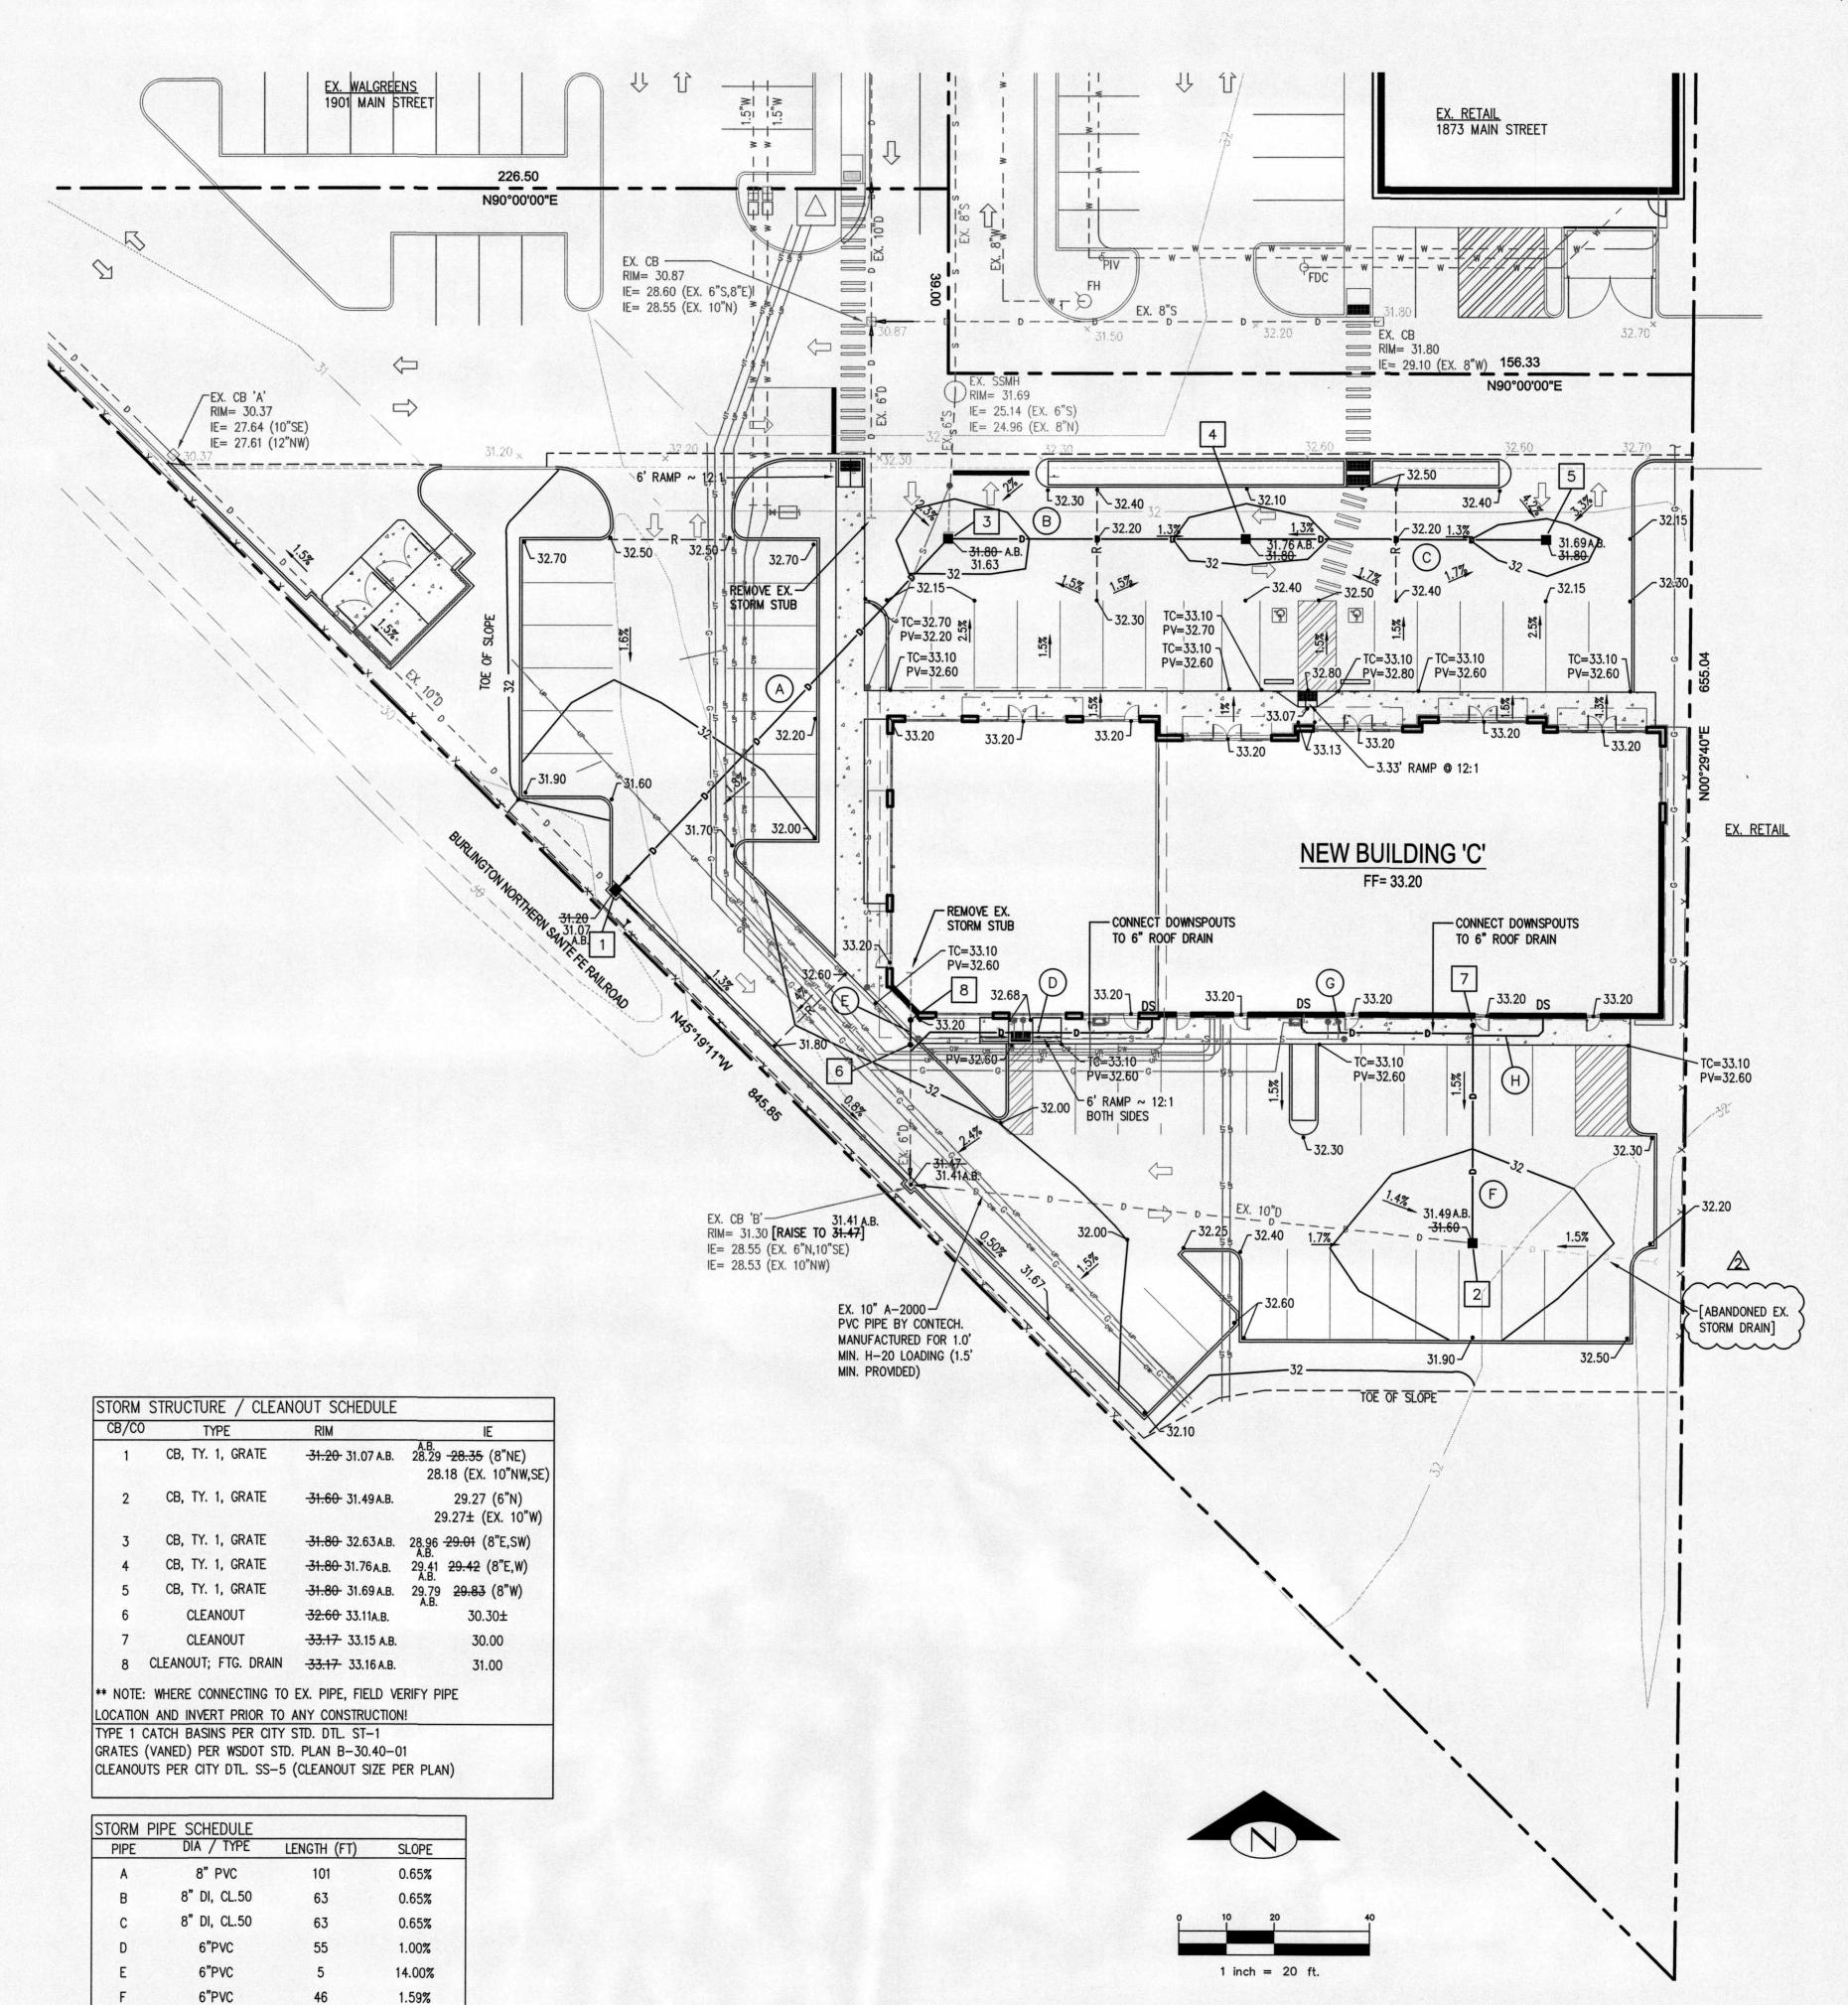

LEGEND

EXISTING

+90.00

_____8″ W____

____12"pD____

PROPOSED

-----100 -----

90.00

-0-

•—

PROPERTY LINE

GRADING CONTOUR

SPOT ELEVATION

GRADE BREAK

STORM DRAIN

FIRE HYDRANT

WATER METER

GATE VALVE

STORM CB

SEWER MANHOLE

STORM MANHOLE

ELECTRICAL LINE

TELEPHONE LINE

POWER VAULT

UTILITY POLE

PARKING LIGHT

6"PVC

6"PVC

PIPE SHALL HAVE 24" MIN. COVER, U.N.O. DI, CL.50 PIPE MAY HAVE 1.0' MIN. COVER

PIPE LENGTHS DIST. TO CTR. OF STRUCTURE, U.N.O.

CPE SHALL BE ADS, N-12 OR EQUAL.

PVC PIPE SHALL BE SDR35

1.00%

1.00%

GAS LINE

EASEMENT

EX. RETAIL

EX. RETAIL 1873 MAIN STREET

IE= 29.10 (EX. 8"W) 156.33

FF= 33.20

REVISIONS NO. DATE 12/18/17 | REV. PER CITY 5/21/19 CIVIL ASBUILTS

ISSUE DATES **DESIGN APPROVAL:** PERMIT SUBMITTAL:

PERMIT RECEIVED: BID DOCS: CONSTR. DOCS:

SHEET INFORMATION 24"x36" SCALE: PLOT DATE:

I HEREBY CERTIFY THAT THE IMPROVEMENTS IN PENCO/(CAPSTONE) BUILDING 'C' HAVE BEEN INSPECTED BY TERRAFORMA DESIGN GROUP CAD FILE: AND TO THE BEST OF MY KNOWLEDGE, HAVE BEEN CONSTRUCTED IN CONFORMANCE WITH

I CERTIFY TO THE BEST OF MY

DATE: 05-23-19

THE CITY OF FERNDALE DEVELOPMENT

MUNICIPAL CODE, SUBSEQUENT STANDARDS

APPROVED

CITY OF FERNDALE PUBLIC WORKS DEPARTMENT

ADOPTED BY REFERENCE THEREIN, AND

STANDARDS, THE CITY OF FERNDALE

STANDARD ENGINEERING PRACTICE.

KNOWLEDGE THAT THE LOCATIONS,

ELEVATIONS, DEPTHS, AND ASBUILT

COMMENTS REFLECTING MATERIALS

ACTUALLY USED DURING CONSTRUCTION

CONDITIONS AS DETERMINED BY ME OR


UNDER MY DIRECT SUPERVISION ON THIS

ACCURATELY REFLECT EXISTING FIELD

JOB NUMBER: 16004 DESIGN / CHECKED: PAD DRAWN: PAD

STATUS:

UTILITY PLAN

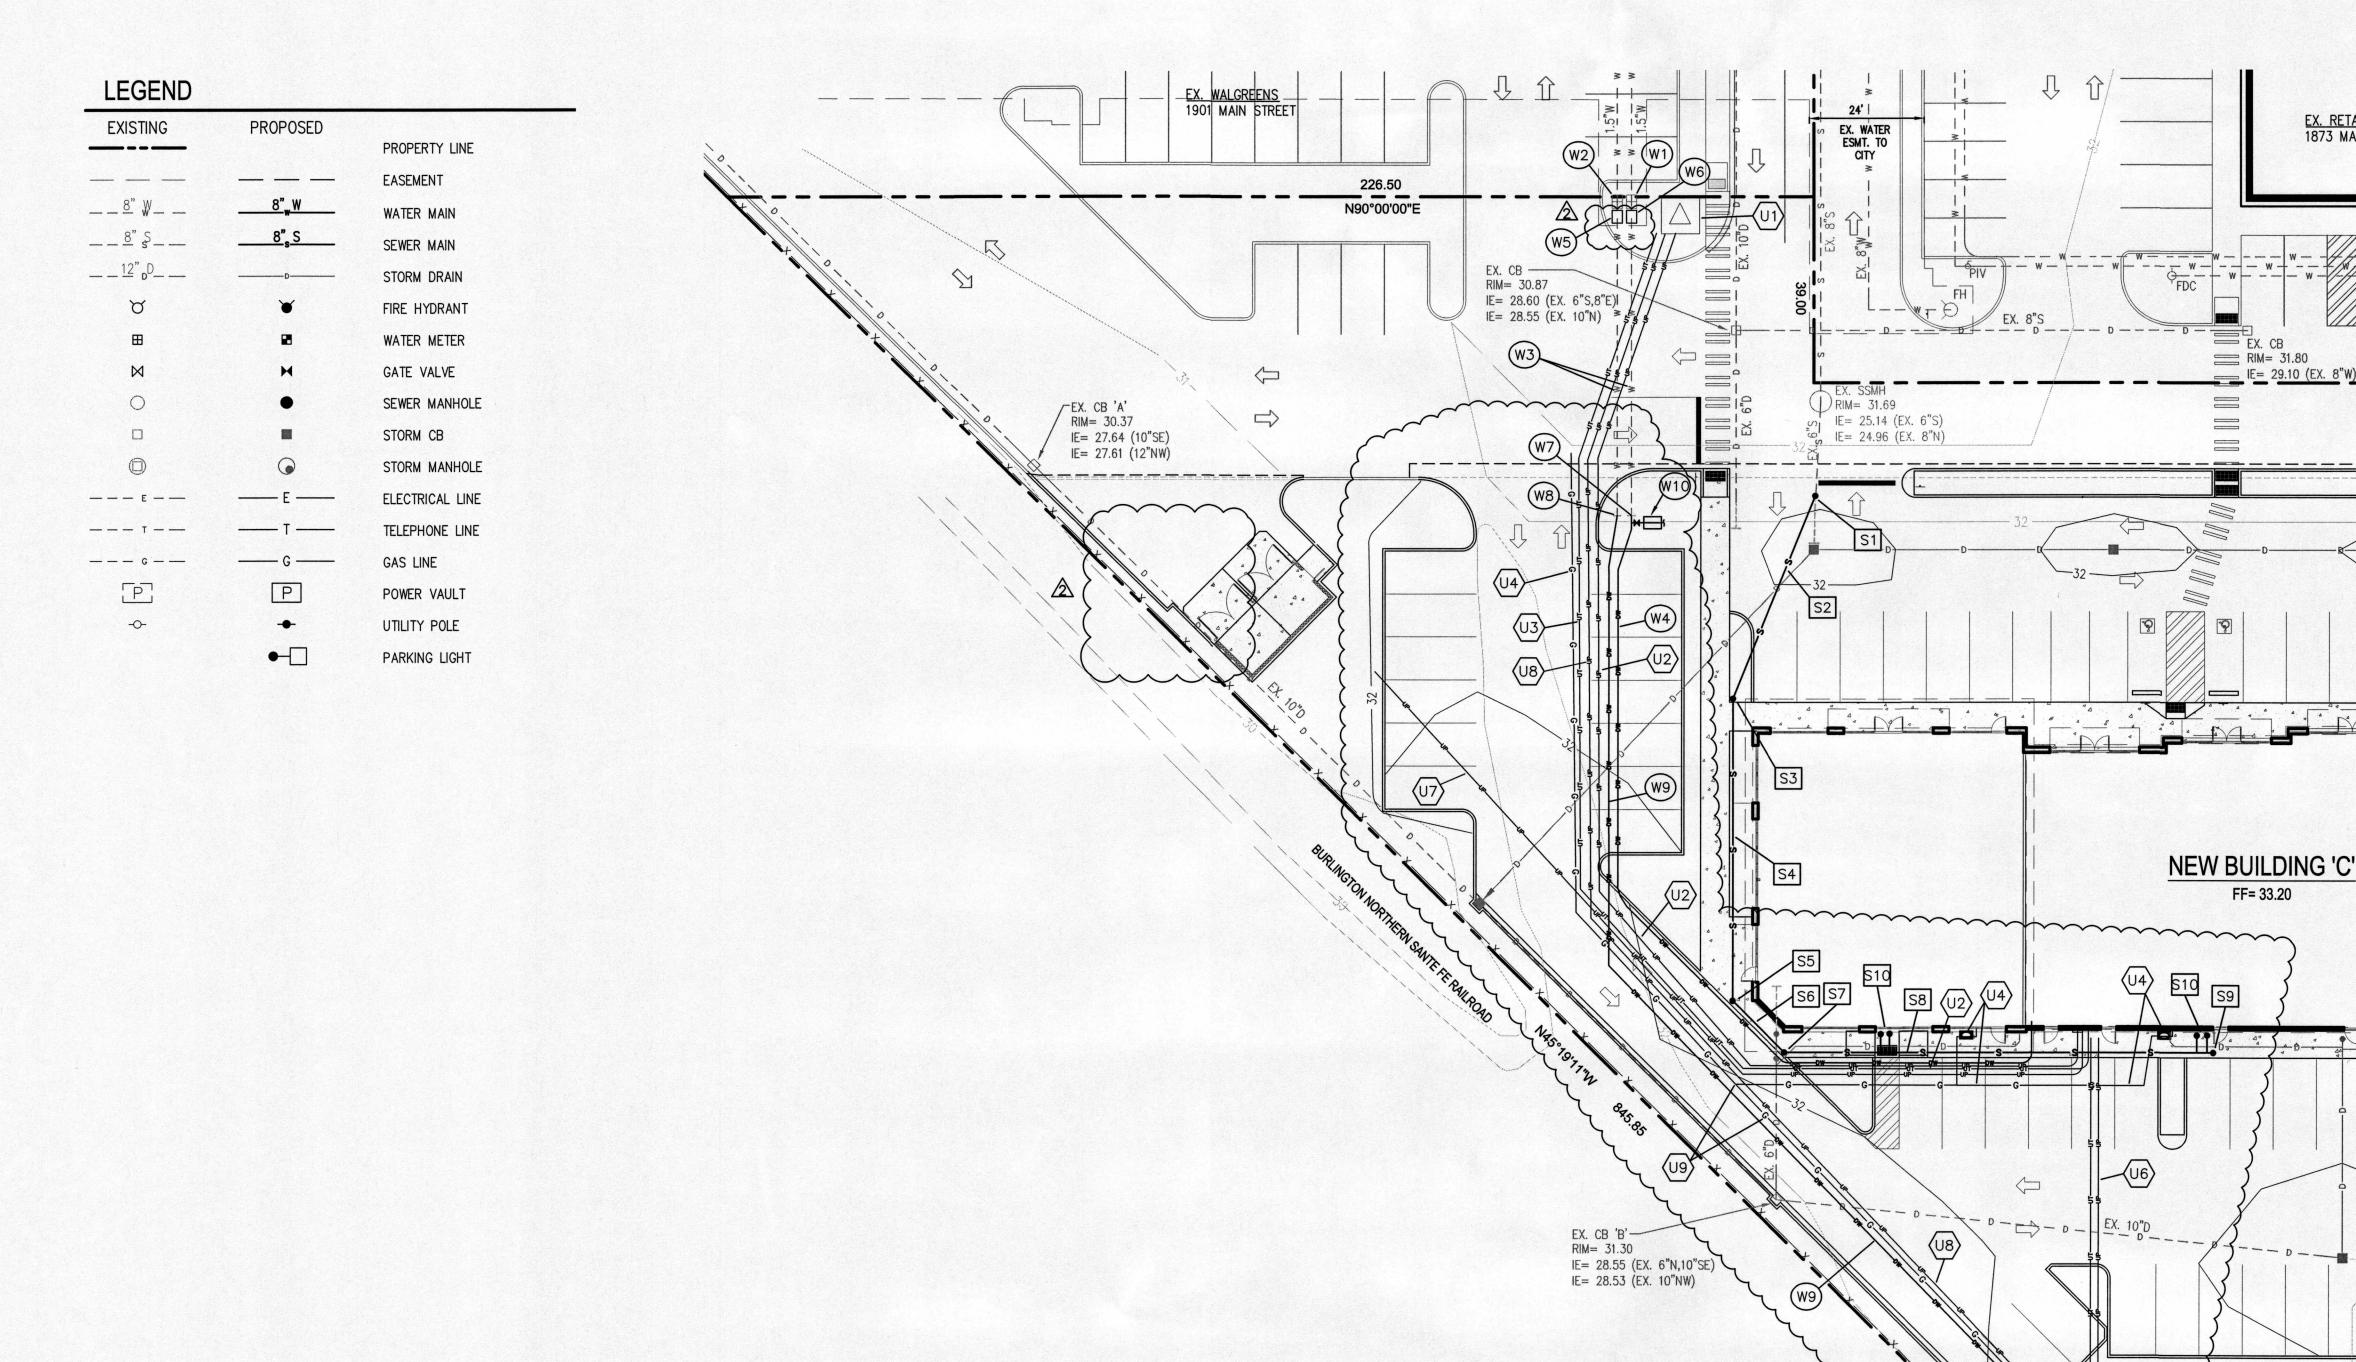

SEWER NOTES

- * REFER TO CITY OF FERNDALE STANDARD SEWER DETAILS & NOTES
- ** PER IBC & WASHINGTON STATE CRITERIA FOR SEWAGE WORKS DESIGN MANUAL, 6" SIDESEWERS MAY BE INSTALLED AT 1% MIN.
- S1 SEWER CLEANOUT PER DTL. 1/C1.5 (TYP) $RIM = \frac{32.20}{32.02} 32.02 A.B.$ IE= 27.7± CONNECT TO EX. SIDESEWER ** FIELD VERIFY LOCATION/ INVERT PRIOR TO ANY CONSTRUCTION!
- S2 48' ~ 6" PVC,SDR35 @ 1.0%
- S3 SEWER CLEANOUT RIM= 33.00 32.98 A.B. IE = 28.20 A.B.
- S4 65' ~ 6" PVC,SDR35 @ 1.0% ~~~~~ S5 SEWER CLEANOUT $RIM = \frac{32.60}{33.09}$ A.B. IE = 28.85 A.B.
- SEWER CLEANOUT RIM= 33.10 A.B. IE= 29.00 A.B.
- S8 89' ~ 6" PVC,SDR35 @ 1.0% <
- S9 SEWER CLEANOUT RIM= 33.12 A.B. IE = 29.89 A.B.
- S10 2 ~ SEWER CLEANOUTS & WASTE CONNECTIONS

O WATER NOTES

- REFER TO CITY OF FERNDALE STANDARD
- ** STATIC WATER PRESSURE = 88 PSI W1 EX. 1" WATER METER BOX/SETTER USE FOR BUILDING 'C' DOMESTIC & IRRIGATION

WATER DETAILS & NOTES

- COORD. NEW METER INSTALLATION WITH CITY USE FOR POTENTIAL FUTURE BUILDING.
 - COORD. NEW METER INSTALLATION WITH CITY W3 EX. 1.5" WATER SERVICE STUBS
 - W4 CONNECT TO EX. 1.5" WATER STUB 192' ~ 1.5" WATER SERVICE TO BLDG (POLY OR COPPER) W5 NEW 1" DCVA (STATE APPRV'D ASS'Y) FOR FUTURE DOMESTIC PER CITY DTL W-18, WITHIN 3 FEET OF METER
 - W6 NEW 1" DCVA (STATE APPRV'D ASS'Y) FOR BUILDING DOMESTIC AND IRRIGATION PER CITY DTL W-18, WITHIN 3 FEET OF METER
- W7 DOMESTIC SERVICE POINT OF CONNECTION
- W8 FUTURE STRUCTURE DOMESTIC POINT OF CONNECTION

UTILITY NOTES

- CONTRACTOR SHALL COORDINATE WITH THE POWER, GAS, TELEPHONE AND CABLE TV SERVICE PROVIDERS REGARDING APPLICABLE EXISTING SERVICE ABANDONMENT AND NEW SERVICE INSTALLATION. CONTRACTOR SHALL PROVIDE NECESSARY DEMOLITION, TRENCHING, BACKFILL AND RESTORATION UNLESS NOTED OTHERWISE.
- U1 EX. POWER TRANSFORMER COORD. WITH PUGET SOUND ENERGY ON NEW SERVICE
- U2 NEW SECONDARY SERVICE TO BLDG 'C'
- COORDINATE WITH ELEC. ENGR. & PSE
- U3 2 ~ 2" PVC CONDUITS FOR TELEPHONE & CATV FOR BLDG 'C'
- U4 NEW GAS METER & SERVICE. COORD. WITH MECH. ENGR. AND CASCADE NATURAL GAS
- U5 OMITTED. BUILDING MOUNTED LIGHTING INSTALLED.
- U6 UNDERGROUND POWER & TELE CONDUIT FOR FUTURE USE U7 UNDERGROUND ELECTRICAL CONDUIT
- U8 UNDERGROUND POWER CONDUIT FOR FUTURE USE U9 GAS SPLITTER WITH SERVICE STUB TO FUTURE USE

1 inch = 20 ft.

S6 15' ~ 6" PVC,SDR35 @A1B0%

W9 221' ~ 1" WATER SERVICE FOR FUTURE USE (POLY)

W10 1" IRRIGATION VALVE, 1" IRRIGATION DCVA

NOTE THE LOCATION OF ALL EXISTING UNDERGROUND UTILITIES IS SHOWN IN AN APPROXIMATE WAY ONLY. THE CONTRACTOR SHALL DETERMINE THE EXACT LOCATION OF ALL EXISTING UTILITIES BEFORE COMMENCING WORK. EXISTING GRADE INFORMATION IS APPROXIMATE. THE CONTRACTOR SHALL FIELD VERIFY EXISTING GRADES AND NOTIFY ENGINEER OF

ANY DISCREPANCIES BEFORE COMMENCING WORK.

CONTRACTOR AGREES TO BE FULLY RESPONSIBLE FOR ANY AND ALL DAMAGES WHICH MIGHT BE OCCASIONED BY HIS FAILURE TO CONFIRM EXISTING UTILITY AND GRADE INFORMATION.

> CALL AT LEAST 2 WORKING DAYS BEFORE YOU DIG CALL '811'

As acceptable alternatives to the rebar shown in the PRECAST BASE SECTION, fibers (placed according to the WSDOT Standard Specifications), or wire mesh having a minimum area of 0.12 square inches per foot shall be used with the minimum required rebar shown in the ALTERNATIVE PRECAST BASE SECTION. Wire mesh shall not

The knockout diameter shall not be greater than 20". Knockouts shall have a wall thickness of 2" minimum to 2.5" maximum. Provide a 1.5" minimum gap between the knockout wall and the outside of the pipe. After the pipe is installed, fill the gap with joint mortar in accordance with WSDOT Standard Specification 9-04.3.

The maximum depth from the finished grade to the lowest pipe invertishall be 5'.

The frame and grate may be installed with the flange down, or integrally cast into the adjustment section with flange up.

(SEE NOTE 1)

NOVEMBER 23, 2016

CATCH BASIN TYPE 1

STANDARD DETAIL ST-1

NOT TO SCALE

ALTERNATIVE PRECAST BASE SECTION

The Precast Base Section may have a rounded floor, and the walls may be sloped at a rate of 1;24 or sleeper.

6. The opening shall be measured at the top of the Precast Base Section.

7. All pickup holes shall be grouted full after the basin has been placed.

#3 BAR EACH CORNER

8/11/17

#3 BAR HOOP-

TDG# 16004

REVISIONS			
NO.	DATE	BY	
1	12/18/17	REV. PER CITY	
2	5/21/19	CIVIL ASBUILTS	
\triangle			
ISSUE DATES			

DESIGN APPROVAL: PERMIT SUBMITTAL PERMIT RECEIVED: BID DOCS: CONSTR. DOCS:

SHEET INFORMATION 24"x36" SCALE:

DRAWN: PAD

PLOT DATE: CAD FILE: JOB NUMBER: 16004 DESIGN / CHECKED: PAD

STATUS:

INSPECTED BY TERRAFORMA DESIGN GROUP AND TO THE BEST OF MY KNOWLEDGE, HAVE BEEN CONSTRUCTED IN CONFORMANCE WITH THE CITY OF FERNDALE DEVELOPMENT STANDARDS, THE CITY OF FERNDALE MUNICIPAL CODE, SUBSEQUENT STANDARDS ADOPTED BY REFERENCE THEREIN, AND

I HEREBY CERTIFY THAT THE IMPROVEMENTS

PENCO/(CAPSTONE) BUILDING 'C' HAVE BEEN

STANDARD ENGINEERING PRACTICE.

MAY 23 2019 CITY OF FERNDALE PUBLIC WORKS DEPARTMENT

SANITARY SEWER

SIDE SEWERS

- ALL WORK SHALL BE DONE IN ACCORDANCE WITH 2015 EDITION WSDOT (WASHINGTON STATE DEPARTMENT OF TRANSPORTATION STANDARD SPECIFICATIONS FOR ROAD, BRIDGE AND MUNICIPAL CONSTRUCTION), ITS CURRENT AMENDMENTS, ATTACHED SPECIAL PROVISIONS, WSDOT STANDARD PLANS AND DETAILS, CITY OF FERNDALE STANDARD DRAWINGS. IN CASE OF A CONFLICT BETWEEN PLANS, REGULATORY STANDARDS OR SPECIFICATIONS, THE MORE STRINGENT REQUIREMENT WILL PREVAIL.
- PRIOR TO THE START OF CONSTRUCTION, THE CONTRACTOR SHALL VERIFY THAT ALL REQUIRED PERMITS AND APPROVALS HAVE BEEN OBTAINED. NO CONSTRUCTION OR FABRICATION SHALL BEGIN UNTIL THE CONTRACTOR HAS RECEIVED AND THOROUGHLY REVIEWED ALL PLANS AND OTHER CONSTRUCTION DOCUMENTS APPROVED BY ALL OF THE PERMITTING AUTHORITIES.
- 3. THE CONTRACTOR SHALL OBTAIN REVOCABLE ENCROACHMENT PERMITS FROM THE CITY OF FERNDALE AND WHATCOM COUNTY PRIOR TO COMMENCING WORK WITHIN PUBLIC RIGHTS-OF-WAY.
- 4. THE CONTRACTOR SHALL SCHEDULE A PRE-CONSTRUCTION MEETING WITH REPRESENTATIVES OF THE CITY OF FERNDALE PUBLIC WORKS DEPARTMENT AND THE PROJECT ENGINEER A MINIMUM OF THREE (3) WORKING DAYS PRIOR TO THE START OF CONSTRUCTION.
- 5. ALL WORK AND MATERIALS SHALL BE SUBJECT TO APPROVAL BY THE CITY OF FERNDALE. REPRESENTATIVES FROM THE CITY OF FERNDALE PUBLIC WORKS DEPARTMENT MUST INSPECT ALL WORK. THE CONTRACTOR
- SHALL CALL AT LEAST 24 HOURS IN ADVANCE TO SCHEDULE INSPECTIONS AS FOLLOWS: A. PLACEMENT OF TEMPORARY EROSION CONTROL MEASURES.
- B. PLACEMENT OF WATER MAIN AND BACKFILLING OF WATER MAIN TRENCH WITHIN ROAD RIGHTS-OF-WAY OR IN WATERLINE EASEMENTS TO BE DEDICATED TO THE CITY OF FERNDALE.
- C. PLACEMENT AND BACKFILLING OF UNDERGROUND UTILITIES, STORM SEWER AND SANITARY SEWER WITHIN ROAD RIGHTS-OF-WAY OR IN EASEMENTS TO BE DEDICATED TO THE CITY OF FERNDALE.
- D. GRADING OF PUBLIC ROADWAY AT:) COMPLETION OF EXCAVATION TO SUBGRADE
- COMPLETION OF BALLAST COURSE PLACEMENT. S) COMPLETION OF CRUSHED SURFACING COURSE PLACEMENT
- POURING OF CURB AND GUTTER AND SIDEWALK IN PUBLIC ROADWAY.
- ASPHALT PAVING IN PROGRESS IN PUBLIC ROADWAY. G. OVERALL INSPECTION FOR FINISHED SHOULDERS, DITCHES, PERMANENT SEEDING AND MONUMENT
- PLACEMENT. H. END OF MAINTENANCE PERIOD.

GENERAL REQUIREMENTS

- 6. SITE CLEARING SHALL INCLUDE THE LOCATION AND REMOVAL OF ALL ABOVE GROUND AND BURIED DEBRIS AND WASTE THAT MAY BE PRESENT. THE CONTRACTOR SHALL BE RESPONSIBLE FOR DETERMINING SUB-SURFACE
- THE CONTRACTOR SHALL BE RESPONSIBLE FOR PROVIDING ADEQUATE SAFEGUARDS, SAFETY DEVICES PROTECTIVE EQUIPMENT, FLAGGERS, AND ANY OTHER NEEDED ACTIONS TO PROTECT THE LIFE, HEALTH AND SAFETY OF THE PUBLIC, AND TO PROTECT PROPERTY IN CONNECTION WITH THE PERFORMANCE OF WORK COVERED BY THE CONTRACTOR. ANY WORK WITHIN THE TRAVELED RIGHT-OF-WAY THAT MAY INTERRUPT NORMAL TRAFFIC FLOW SHALL REQUIRE AT LEAST ONE FLAGGER FOR EACH LANE OF TRAFFIC AFFECTED. ALL SECTIONS OF THE WSDOT STANDARD SPECIFICATIONS 1-07.23-TRAFFIC CONTROL, SHALL
- 8. A COPY OF THESE APPROVED PLANS MUST BE ON THE JOB SITE WHENEVER CONSTRUCTION IS IN
- THE CONTRACTOR SHALL INFORM THE ENGINEER AND OBTAIN APPROVAL FROM THE CITY OF FERNDALE PUBLIC WORKS DIRECTOR OF ANY PROPOSED DEVIATIONS FROM THE APPROVED PLANS PRIOR TO CONSTRUCTION OF THE REVISED IMPROVEMENTS. THE CONTRACTOR SHALL KEEP RECORDS OF ALL DEVIATIONS AND SHALL FORWARD THEM TO THE ENGINEER AND TO THE CITY OF FERNDALE PUBLIC WORKS DEPARTMENT.
- 10. THE LOCATIONS OF EXISTING UNDERGROUND UTILITIES ARE BASED UPON A COMBINATION OF FIELD RECONNAISSANCE, FIELD SURVEY AND UTILITY COMPANY RECORDS AND ARE SHOWN ON THESE PLANS IN AN APPROXIMATE WAY ONLY. IT IS THE CONTRACTOR'S RESPONSIBILITY TO CONTACT ALL OF THE VARIOUS UTILITY COMPANIES TO ARRANGE FOR FIELD LOCATIONS OF ALL EXISTING UTILITY FACILITIES PRIOR TO STARTING CONSTRUCTION. NO EXTRA COMPENSATION WILL BE PAID TO THE CONTRACTOR FOR COSTS INCURRED BECAUSE OF DAMAGE DONE TO EXISTING FACILITIES BY THE CONTRACTOR'S WORK FORCE, INCLUDING COSTS FOR REPAIRS, WHICH WILL BE CONTRACTOR'S SOLE RESPONSIBILITY. THE CONTRACTOR SHALL BE RESPONSIBLE FOR MAINTAINING THE INTEGRITY OF ALL EXISTING UTILITIES AND TO NOTIFY THE ENGINEER PROMPTLY OF ANY CONFLICT BETWEEN THE APPROVED PLANS AND THE LOCATION OF ANY EXISTING UTILITIES. THE CONTRACTOR SHALL CONTACT UTILITY LOCATION SERVICE AT LEAST 48 HOURS PRIOR TO STARTING CONSTRUCTION. PHONE: 1-800-424-5555.
- 11. THE CONTRACTOR SHALL PROTECT ALL PRIVATE AND PUBLIC UTILITIES FROM DAMAGE RESULTING FROM THE WORK. CONTRACTOR SHALL RESTORE ALL PRIVATE AND PUBLIC PROPERTY DISRUPTED BY THE PROJECT IMMEDIATELY AFTER CONSTRUCTION.
- 12. ALL DIMENSIONS AND GRADES SHOWN ON THE PLANS SHALL BE FIELD VERIFIED BY THE CONTRACTOR PRIOR TO CONSTRUCTION. CONTRACTOR SHALL NOTIFY THE CONSTRUCTION MANAGER IF ANY DISCREPANCIES EXIST BETWEEN ACTUAL FIELD CONDITIONS AND THE ASSUMED CONDITIONS SHOWN ON THE APPROVED PLANS PRIOR TO PROCEEDING WITH CONSTRUCTION, SO THAT NECESSARY PLAN OR DESIGN CHANGES CAN BE MADE. NO EXTRA COMPENSATION SHALL BE PAID TO THE CONTRACTOR FOR EXTRA WORK, INCLUDING REMOVAL AND RECONSTRUCTION OF NEWLY BUILT IMPROVEMENTS, MADE NECESSARY BY ERRORS OF DIMENSION OR GRADE ON THE APPROVED PLANS, UNLESS SUCH NOTIFICATION WAS GIVEN.
- 13. THROUGHOUT THE PERIOD OF CONSTRUCTION, CONTRACTOR SHALL COMPLY WITH THE TERMS OF ALL PERMITS.
- 14. THE CONTRACTOR SHALL BE RESPONSIBLE FOR MAINTAINING EROSION CONTROL MEASURES THROUGHOUT THE DURATION OF THE PROJECT. EROSION CONTROL MEASURES SHALL BE INSTALLED PRIOR TO ANY CLEARING OR
- 15. ALL MATERIALS TESTING REQUIREMENTS FOR THE IMPROVEMENTS SHALL BE THE RESPONSIBILITY OF THE CONTRACTOR AND SHALL BE PERFORMED IN ACCORDANCE WITH THE INSTRUCTIONS OF THE CITY OF FERNDALE PUBLIC WORKS DIRECTOR. CONTRACTOR SHOULD DETERMINE THESE REQUIREMENTS PRIOR TO THE START OF
- 16. ALL PORTLAND CEMENT CONCRETE SHALL BE APWA CLASS 3000, PER APWA STANDARD SPECIFICATIONS, SECTION 6-02.3(2)B.
- 17. UNDERGROUND UTILITIES CONSTRUCTION
- A. THE CONTRACTOR IS RESPONSIBLE FOR COORDINATING WITH THE ENGINEER TO ASSURE ACCURATE AND TIMELY COLLECTION OF ALL REQUIRED AS-BUILT DATA. THIS DATA MUST ACCURATELY REFLECT THE LOCATIONS OF ALL UNDERGROUND UTILITIES, BOTTOM OF PIPE ELEVATIONS, INVERT ELEVATIONS, MANHOLE LOCATIONS, BLOW-OFF LOCATIONS AND INVERTS OF SERVICE CONNECTIONS (BOTH AT PIPE AND AT PROPERTY LINE), VERTICAL AND HORIZONTAL BENDS, SERVICE BOXES AND METERS, VALVES AND HYDRANTS. CALL AT LEAST 48-HOURS BEFORE BURYING UNDERGROUND PIPE TO ASSURE AND FACILITATE REQUIRED AS-BUILT SURVEY. THE ENGINEER WILL PROVIDE CERTIFIED AS-BUILT MYLARS TO PUBLIC WORKS UPON PROVISIONAL ACCEPTANCE OF ROAD AND UTILITY IMPROVEMENTS.
- B. THE CONSTRUCTION OF UNDERGROUND UTILITY LINES SHALL BE SUBJECT TO THE FOLLOWING CRITERIA:
 - NO MORE THAN 500 FEET OF TRENCH SHALL BE OPENED AT ONE TIME.
 - ii. WHERE CONSISTENT WITH SAFETY AND SPACE CONSIDERATIONS, EXCAVATED MATERIAL SHALL BE PLACED ON THE UPHILL SIDE OF DITCHES.
- iii. TRENCH DEWATERING DEVICES SHALL DISCHARGE INTO SEDIMENT TRAPS OR SEDIMENT PONDS. iv. WHERE PRACTICAL, INSTALL GRAVITY PIPE UTILITIES PRIOR TO INSTALLATION OF OTHER UTILITIES.
- C. UTILITY CONSTRUCTION SHALL BE DONE IN ACCORDANCE WITH THE REQUIREMENTS OF THE CITY OF FERNDALE DEVELOPMENT STANDARDS.
- D. TESTING OF NEW WATER LINES, SANITARY SEWER LINES, AND STORM SEWER SYSTEMS SHALL NOT BE PERFORMED UNTIL ALL OTHER ADJACENT UTILITIES HAVE BEEN INSTALLED.
- 18. CONTRACTOR SHALL PROVIDE REDLINED AS-BUILTS OF ALL UTILITY AND DRAINAGE CONSTRUCTION. THE BUILDING FINISH FLOOR ELEVATION, POND WALL ELEVATIONS, STORM/SEWER RIM & INVERTS SHALL BE CERTIFIED BY THE CONTRACTOR'S SURVEYOR.

CONCRETE CLEANUP BMP'S

- 1. CONCRETE TRUCK CHUTES, PUMPS AND INTERNALS SHALL BE WASHED OUT ONLY INTO FORMED AREAS AWAITING INSTALLATION OF CONCRETE OR ASPHALT.
- UNUSED CONCRETE REMAINING IN THE TRUCK AND PUMP SHALL BE RETURNED TO THE ORIGINATING BATCH PLANT FOR RECYCLING.
- 3. HAND TOOLS INCLUDING, BUT NOT LIMITED TO, SCREEDS, SHOVELS, RAKES, FLOATES AND TROWELS SHALL BE WASHED OFF ONLY INTO FORMED AREAS AWAITING INSTALLATION OF CONCRETE OR ASPHALT.
- 4. EQUIPMENT THAT CANNOT BE EASILY MOVED, SUCH AS CONCRETE PAVERS, SHALL ONLY BE WASHED IN AREAS THAT DO NOT DIRECTLY DRAIN TO NATURAL OR CONSTRUCTED STORMWATER CONVEYANCES.
- 5. WASHDOWN FROM AREAS SUCH AS CONCRETE AGGREGATE DRIVEWAYS SHALL NOT DRAIN DIRECTLY TO NATURAL OR CONSTRUCTED STORMWATER CONVEYANCES.
- WHEN NO FORMED AREAS ARE AVAILABLE, WASHWATER AND LEFTOVER PRODUCT SHALL BE CONTAINED IN A LINED CONTAINER. CONTAINED CONCRETE SHALL BE DISPOSED OF IN A MANNER THAT DOES NOT VIOLATE GROUNDWATER OR SURFACE WATER QUALITY STANDARDS. CONTAINERS SHALL BE CHECKED FOR HOLES IN THE LINER DAILY DURING CONCRETE POURS AND REPAIRED THE SAME DAY.

1. THE FOLLOWING STANDARD DETAILS SHALL BE USED IN CONSTRUCTING SANITARY SEWER IMPROVEMENTS: CITY OF FERNDALE STANDARD DETAIL (COFSD) SS-1 PIPE BEDDING COFSD SS-15 & SS-1 & WSDOT STD. SPEC. SEC. 9-03.12 TRENCH BACKFILL SS CLEANOUTS

COFSD SS-6, SS-8 & SS-13

- 2. ALL WORK AND MATERIALS SHALL BE IN ACCORDANCE WITH A.P.W.A. STANDARD SPECIFICATIONS, 1996 EDITION, AND SHALL BE SUBJECT TO APPROVAL BY THE CITY OF FERNDALE.
- 3. ALL WORK MUST BE INSPECTED TO THE SATISFACTION OF THE CITY OF FERNDALE. 24 HOUR NOTICE MUST BE GIVEN PRIOR TO STARTING WORK. TESTING OF THE SEWER SYSTEM AND ALL CONNECTIONS TO EXISTING MAINS SHALL BE DONE IN THE PRESENCE AND UNDER THE SUPERVISION OF A CITY OF FERNDALE REPRESENTATIVE.
- 4. SANITARY SEWER PIPE BEDDING SHALL BE PEA GRAVEL PER COFSD SS-1. ALL TRENCHES SHALL BE BACKFILLED WITH CLASS B BANK RUN GRAVEL OR SUITABLE NATURAL MATERIAL AS DIRECTED BY THE ENGINEER, AND COMPACTED TO 95% MODIFIED PROCTOR DENSITY.
- 5. ALL SIDE SEWERS SHALL BE INSTALLED PER CITY OF FERNDALE STANDARD DETAILS SS-6, SS-8 OR SS-13, EXCEPT THAT SINGLE SIDE SEWERS SHALL HAVE A MINIMUM DIAMETER OF 4".
- 6. CONTRACTOR SHALL EXTEND SEWER STUBS 5 FEET BEYOND UTILITY CORRIDOR OR 15 FEET BEYOND RIGHT-OF-WAY LINE.

- 1. THE FOLLOWING STANDARD DETAILS SHALL BE USED IN CONSTRUCTING WATER SUPPLY SYSTEM IMPROVEMENTS: TRENCH BACKFILL COFSD W-11 & WSDOT STD. SPEC. SEC. 9-03.12 WATER SERVICE COFSD W-6, & DETAIL SHEET 16
- 2. CONNECTIONS TO EXISTING WATER MAINS THE CONTRACTOR MUST NOTIFY THE CITY OF FERNDALE PUBLIC WORKS DIRECTOR OF A PROPOSED CONNECTION AT LEAST FOUR WORKING DAYS IN ADVANCE. ALL CONNECTIONS SHALL BE DONE BY THE CONTRACTOR. CONNECTION TO EXISTING CITY WATER SYSTEM SHALL BE PAID IN ADVANCE BY A DEPOSIT.
- 3. ALL HYDROSTATIC TESTING AND DISINFECTION OF WATER MAINS SHALL CONFORM TO SECTION 7-09.3 OF THE WASHINGTON STATE DEPARTMENT OF TRANSPORTATION STANDARD SPECIFICATIONS FOR ROAD, BRIDGE OR MUNICIPAL CONSTRUCTION - CURRENT EDITION. HYDROSTATIC TEST PRESSURE FOR WATER MAIN ACCEPTANCE SHALL BE 225 PSI AND SHALL BE DONE ACCORDING TO CITY OF FERNDALE REQUIREMENTS. ALL DISINFECTION AND BACTERIOLOGICAL TESTS SHALL BE CONDUCTED BY THE CITY OF FERNDALE LABORATORY. THE PIPE WILL NOT PASS TESTING UNLESS A ZERO BACTERIAL COUNT IS MEASURED ON TWO CONSECUTIVE TESTS, CONDUCTED 24 HOURS APART.
- 4. BACKFILL SHALL BE GRAVEL BASE, CLASS B, IN ALL STREET RIGHTS-OF-WAY, COMPACTED TO MINIMUM 95% OPTIMUM DENSITY. IN UNIMPROVED AREAS, MINIMUM COMPACTION SHALL BE 90% OF OPTIMUM DENSITY.
- 5. ALL PIPE SHALL HAVE A MINIMUM COVER OF 42".
- 6. WATER SERVICE TAP INSTALLATIONS SHALL MEET THE REQUIREMENTS OF THE CITY OF FERNDALE DEVELOPMENT STANDARDS. ALL WATER SERVICE STUB ENDS SHALL BE MARKED FOR LOCATION WITH A 4' LONG 2" X 4" TIMBER, PAINTED BLUE.
- 7. CONTRACTOR IS RESPONSIBLE TO SET WATERMETER BOXES TO THE FINISHED GRADE BEHIND SIDEWALK. FINISHED GRADE BEHIND SIDEWALK SHALL MEET CITY APPROVAL.

STORM DRAINAGE

- 1. THE FOLLOWING STANDARD DETAILS SHALL BE USED FOR CONSTRUCTION OF STORM DRAIN IMPROVEMENTS:
- "MAIN LINE" CATCH BASINS TYPE 1, 1L OR 2, WSDOT STD. DETAILS B-1, B-1A OR B-1E 2. ALL PIPE AND APPURTENANCES SHALL BE LAID ON A PROPERLY PREPARED FOUNDATION IN ACCORDANCE WITH WSDOT STANDARD SPECIFICATIONS SECTION 7-08.3(1). THIS SHALL INCLUDE LEVELING AND COMPACTING THE TRENCH BOTTOM, THE TOP OF THE FOUNDATION MATERIAL AND ANY REQUIRED PIPE BEDDING TO A UNIFORM GRADE SO THAT THE ENTIRE PIPE IS SUPPORTED BY A UNIFORMLY DENSE UNYIELDING BASE. DRAINAGE MATERIALS SHALL CONFORM TO WSDOT STANDARD SPECIFICATIONS SECTION 9-05.
- 3. STORM SEWER PIPE HAVING DIAMETERS GREATER THAN 8" SHALL BE CORRUGATED POLYETHYLENE PIPE (CPEP) AND SHALL CONFORM TO WSDOT STANDARD SPECIFICATIONS, SECTION 9-05.20. STORM SEWER PIPE HAVING DIAMETERS 8" AND SMALLER SHALL BE POLYVINYL CHLORIDE (PVC) PIPE AND SHALL CONFORM TO WSDOT STANDARD SPECIFICATIONS, SECTION 9-05.12.
- 4. BACK OF WALK DRAIN SHALL BE 4" SMOOTH WALL PERFORATED PVC PIPE, ASTM D 3034 SDR35. INSTALLED IN CUT SECTIONS PER COFSD ST-15.
- ALL CATCH BASIN GRATES SHALL INCLUDE THE STAMPING "OUTFALL TO STREAM, DUMP NO POLLUTANTS"
- 6. UNLESS OTHERWISE SPECIFIED, CAST IRON PRODUCTS SHALL CONFORM TO ASTM DESIGNATION "A 48 CLASS 30" AND DUCTILE IRON PRODUCTS TO ASTM DESIGNATION "A 536 GRADE 80-55-06".
- 7. ALL DRAINAGE STRUCTURES, SUCH AS CATCH BASINS AND MANHOLES, NOT LOCATED WITHIN A TRAVELED ROADWAY OR SIDEWALK, SHALL HAVE SOLID LOCKING LIDS. ALL DRAINAGE STRUCTURES ASSOCIATED WITH A PERMANENT RETENTION/DETENTION FACILITY SHALL HAVE SOLID LOCKING LIDS.
- 9. LOT/ROOF DRAIN SERVICES SHALL BE MIN. 4" PVC PIPE, ASTM D 3034 SDR35. MULTIPLE RESIDENTIAL STORM DRAIN SERVICES SHALL BE 6" PVC PIPE, DRAINING TO A COFSD ST-7 INLET. 8" PVC PIPE SHALL BE USED TO CONNECT EACH ST-7 INLET TO A NEARBY TYPE 1, TYPE 1L, OR TYPE 2 CATCH BASIN.

CITY LAND DISTURBANCE NOTES

- 1. LAND DISTURBANCE PERMITS, AUTHORIZATION, AND EXEMPTION NOTICES, OR ANY OTHER LAND USE PERMIT INVOLVING LAND DISTURBANCE, MUST BE POSTED AND CLEARLY VISIBLE AT THE ACCESS TO THE SITE.
- 2. NOTICE TO THE CITY MUST BE GIVEN 24 HOURS PRIOR TO STARTING WORK. AND 24 HOURS PRIOR TO COMPLETION OF THE PERMITTED LAND DISTURBANCE. FAILURE TO DO SO MAY NULLIFY THE PERMIT AND SUBJECT THE APPLICANT TO PENALTIES PURSUANT TO SECTION 204 OF THE DEVELOPMENT STANDARDS FOR THE CITY OF FERNDALE.
- 3. PROVIDE A CLEAN, HARD SURFACE FOR VEHICLES ENTERING THE SITE TO ELIMINATE TRACKING SOIL PNTO THE STREET. SURFACE MATERIAL MAY INCLUDE QUARRY SPALLS, CRUSHED ROCK, OR RIVER ROCK (SEE ILLUSTRATION OF STABILIZED CONSTRUCTION ENTRANCE ATTACHED).
- 4. CONSTRUCT A SILT BARRIER DOWN SLOPE OF ACTIVITY AND MAINTAIN IT IN WORKING ORDER UNTIL PERMANENT VEGETATION IS FULLY ESTABLISHED; AND/OR
- 5. DIRECT ON-SITE RAINFALL RUNOFF TO A SINGLE POINT ON THE PROPERTY. CONSTRUCT AN ADEQUATELY SIZED SUMP OR BASIN FILTERING SYSTEM TO ACCOMMODATE THE DIRECTED RUNOFF. DISCHARGE THE FILTERED
- 6. WHERE AREAS HAVE BEEN STRIPPED OF VEGETATION AND NO FURTHER WORK IS ANTICIPATED FOR A PERIOD OF THIRTY (30) DAYS, LAND SHALL BE STABILIZED THROUGH SEEDING AND/OR MULCHING.
- 7. TOPSOIL SHALL NOT BE USED AS FILL MATERIAL. SITES BEING STRIPPED FOR GRADING OR EXCAVATION MUST STOCKPILE ON SITE FOR TOP DRESSING ROAD BANKS, LAWNS, AND MINING RECLAMATION.
- 8. CRITICAL AREAS: IN AREAS SUCH AS WETLANDS AS SHOWN IN CRITICAL AREAS ORDINANCE #955 ON THE WETLANDS MAP, THE APPLICANT MUST HAVE A PERMIT FROM THE CORPS OF ENGINEERS OR A LETTER OF EXEMPTION. FOR ALTERATION OF LAND IN THE 100-YEAR FLOODPLAIN, A FLOODPLAIN PERMIT FROM THE CITY OF FERNDALE IS REQUIRED.
- 9. FORESTED AREAS: A PERMIT FROM THE STATE OF WASHINGTON DEPARTMENT OF NATURAL RESOURCES IS REQUIRED FOR LOGGING ACTIVITY. IF THE FORESTED AREA IS LOCATED IN A CRITICAL AREA, SUCH AS A WETLAND, A WETLAND PERMIT FROM THE CORPS OF ENGINEERS WOULD BE REQUIRED.
- REQUIRED FOR ANY WORK PERFORMED NOTE: UNLESS OTHERWISE NOTED ON THE FACE OF THE PERMIT ALL LAND DISTURBANCE ACTIVITY IS PROHIBITED BETWEEN OCTOBER 1 AND APRIL 1

10. WORK IN THE CITY RICIHT-OF-WAV: AN ENCROACHMENT PERMIT FROM THE CITY OF FERNDALE IS

EROSION CONTROL NOTES

1. APPROVAL OF THIS EROSION/SEDIMENTATION CONTROL (ESC) PLAN DOES NOT CONSTITUTE AN APPROVAL OF PERMANENT ROAD OR DRAINAGE DESIGN (E.G. SIZE AND LOCATION OF ROADS, PIPES, RESTRICTORS, CHANNELS, RETENTION FACILITIES, UTILITIES, ETC.).

PIPE ALLOWANCES

15"

PIPE MATERIAL

PLAIN CONCRETE

ALL METAL PIPE

CPSSP* (WSDOT STD. SPEC. 9-05.20)

SOLID WALL PVC (WSDOT STD. SPEC. 9-05.12(1))

PROFILE WALL PVC (WSDOT STD. SPEC. 9-05.12(2))

CORRUGATED POLYETHYLENE STORM SEWER PIPE

PRECAST BASE SECTION

FRAME AND VANED GRATE

RECTANGULAR ADJUSTMENT SECTION

ONE #3 BAR FOR 6" HEIGHT

#3 BAR EACH CORNER


#3 BAR EACH WAY-


#3 BAR HOOP EACH SID

Public Works Directo

NCREMENT (SPACED EQUALLY)

- 2. THE IMPLEMENTATION OF THESE ESC PLANS AND THE CONSTRUCTION, MAINTENANCE, REPLACEMENT, AND UPGRADING OF THESE ESC FACILITIES IS THE RESPONSIBILITY OF THE APPLICANT/CONTRACTOR UNTIL ALL CONSTRUCTION IS COMPLETED AND APPROVED AND VEGETATION / LANDSCAPING IS ESTABLISHED.
- 3. THE BOUNDARIES OF THE CLEARING LIMITS SHOWN ON THIS PLAN SHALL BE CLEARLY FLAGGED IN THE FIELD PRIOR TO CONSTRUCTION. DURING THE CONSTRUCTION PERIOD, NO DISTURBANCE BEYOND THE FLAGGED CLEARING LIMITS SHALL BE PERMITTED. THE FLAGGING SHALL BE MAINTAINED BY THE APPLICANT/CONTRACTOR FOR THE DURATION OF CONSTRUCTION.
- 4. THE ESC FACILITIES SHOWN ON THIS PLAN MUST BE CONSTRUCTED IN CONJUNCTION WITH ALL CLEARING AND GRADING ACTIVITIES, AND IN SUCH A MANNER AS TO INSURE THAT SEDIMENT AND SEDIMENT LADEN WATER DO NOT ENTER THE DRAINAGE SYSTEM, ROADWAYS, OR VIOLATE APPLICABLE WATER STANDARDS. THE ESC FACILITIES SHOWN ON THIS PLAN ARE THE MINIMUM REQUIREMENTS FOR ANTICIPATED SITE CONDITIONS. DURING TH CONSTRUCTION PERIOD, THESE ESC FACILITIES SHALL BE UPGRADED AS NEEDED FOR UNEXPECTED STORM EVENTS AND TO ENSURE THAT SEDIMENT AND SEDIMENT-LADEN WATER DO NOT LEAVE THE SITE.
- 5. THE ESC FACILITIES SHALL BE INSPECTED DAILY BY THE APPLICANT/CONTRACTOR AND MAINTAINED AS NECESSARY TO ENSURE THEIR CONTINUED FUNCTIONING. THE ESC FACILITIES ON INACTIVE SITES SHALL BE INSPECTED AND MAINTAINED A MINIMUM OF ONCE A MONTH OR WITHIN THE 48
- 6. AT NO TIME SHALL MORE THAN ONE FOOT OF SEDIMENT BE ALLOWED TO ACCUMULATE WITHIN A TRAPPED CATCH BASIN. ALL CATCH BASINS AND CONVEYANCE LINES SHALL BE CLEANED PRIOR TO PAVING. THE CLEANING OPERATION SHALL NOT FLUSH SEDIMENT LADEN WATER INTO THE
- 7. STABILIZED CONSTRUCTION ENTRANCES SHALL BE INSTALLED AT THE BEGINNING OF CONSTRUCTION AND MAINTAINED FOR THE DURATION OF THE PROJECT. ADDITIONAL MEASURES MAY BE REQUIRED TO INSURE THAT ALL PAVED AREAS ARE KEPT CLEAN FOR THE DURATION OF THE PROJECT.

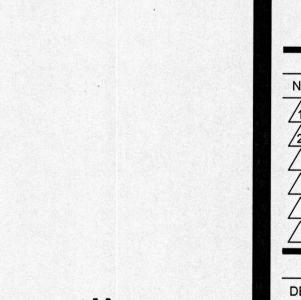

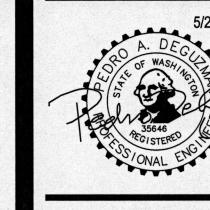

ISSUE DATES **DESIGN APPROVAL:** PERMIT SUBMITTAL

REVISIONS

12/18/17 | REV. PE


5/21/19 | CIVIL AS


PERMIT RECEIVED: BID DOCS: CONSTR. DOCS:


SHEET INFORMATION 24"x36" SCALE:


PLOT DATE: CAD FILE: JOB NUMBER: 16004

DESIGN / CHECKED: PAD DRAWN: PAD STATUS:

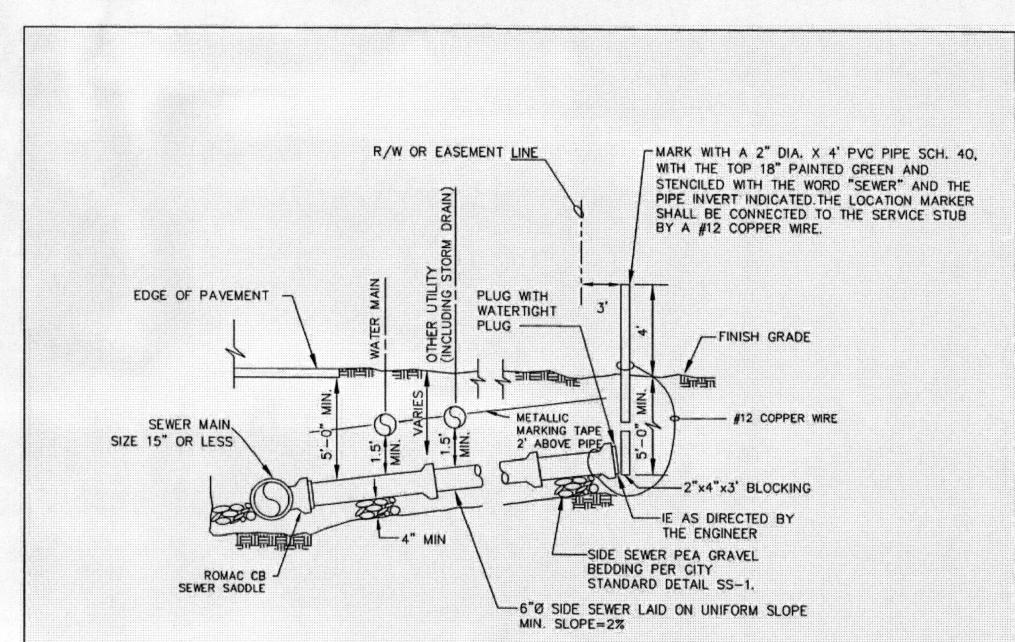


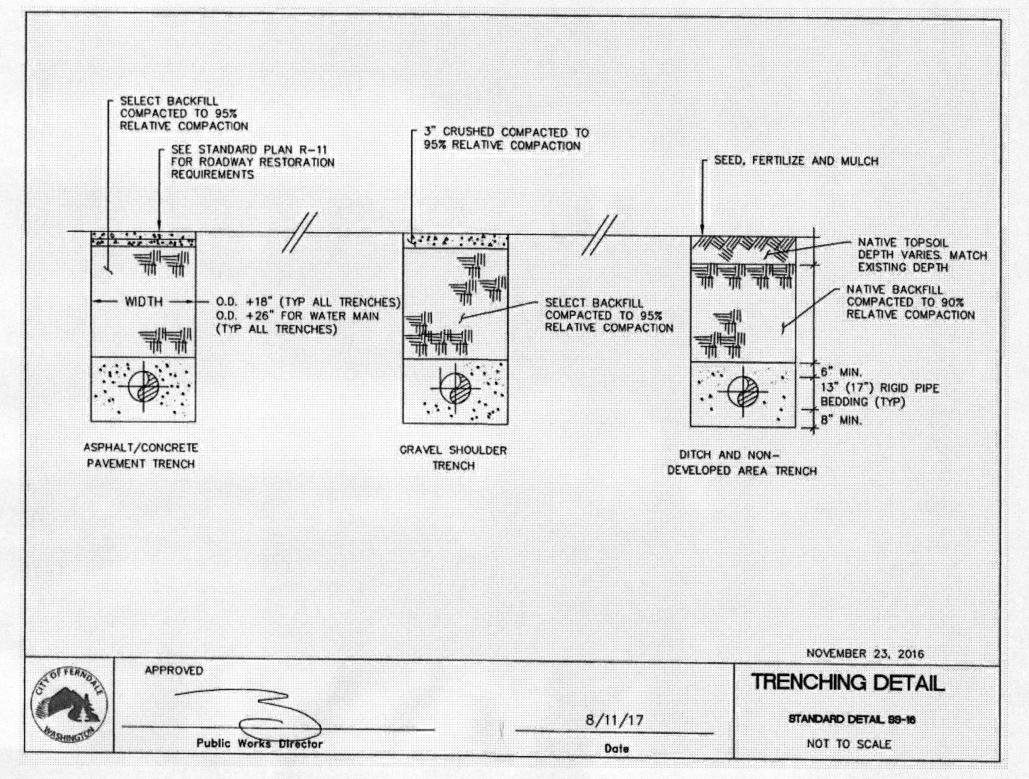


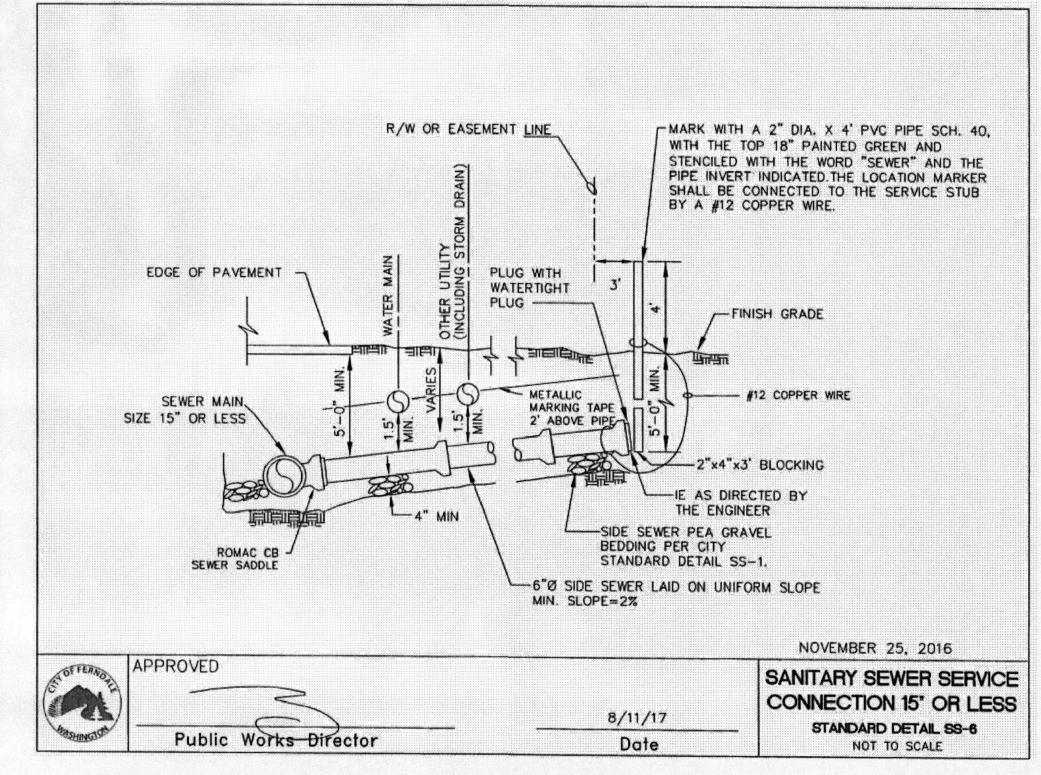


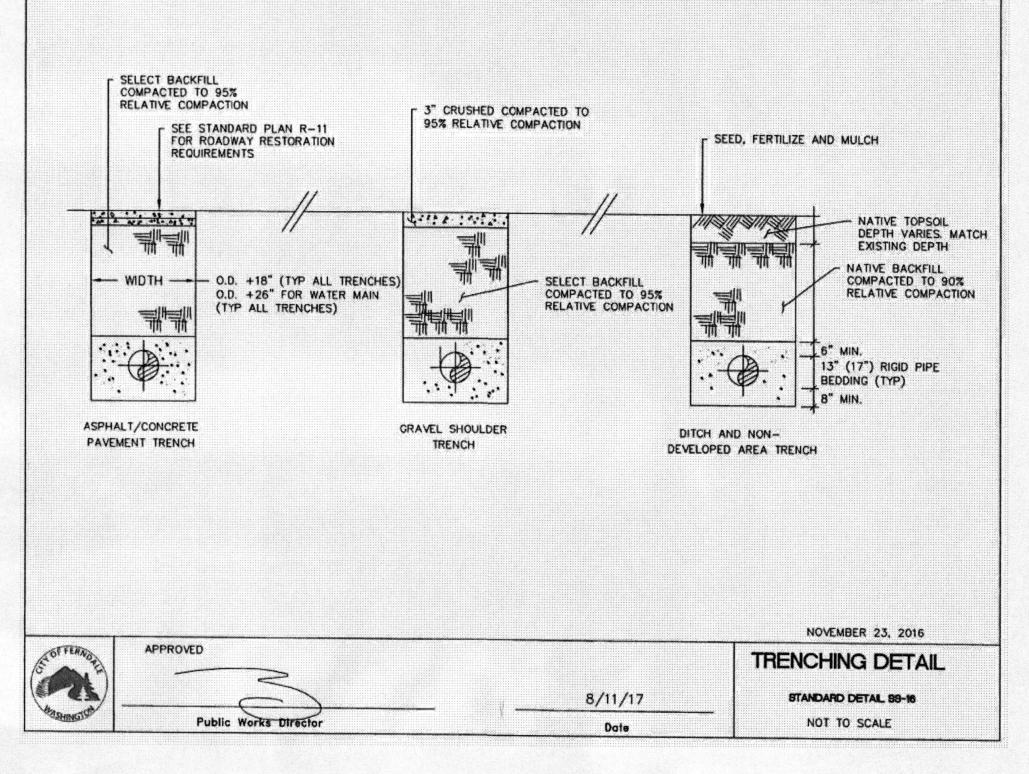





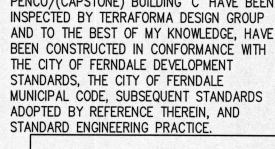

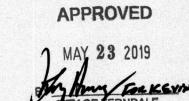

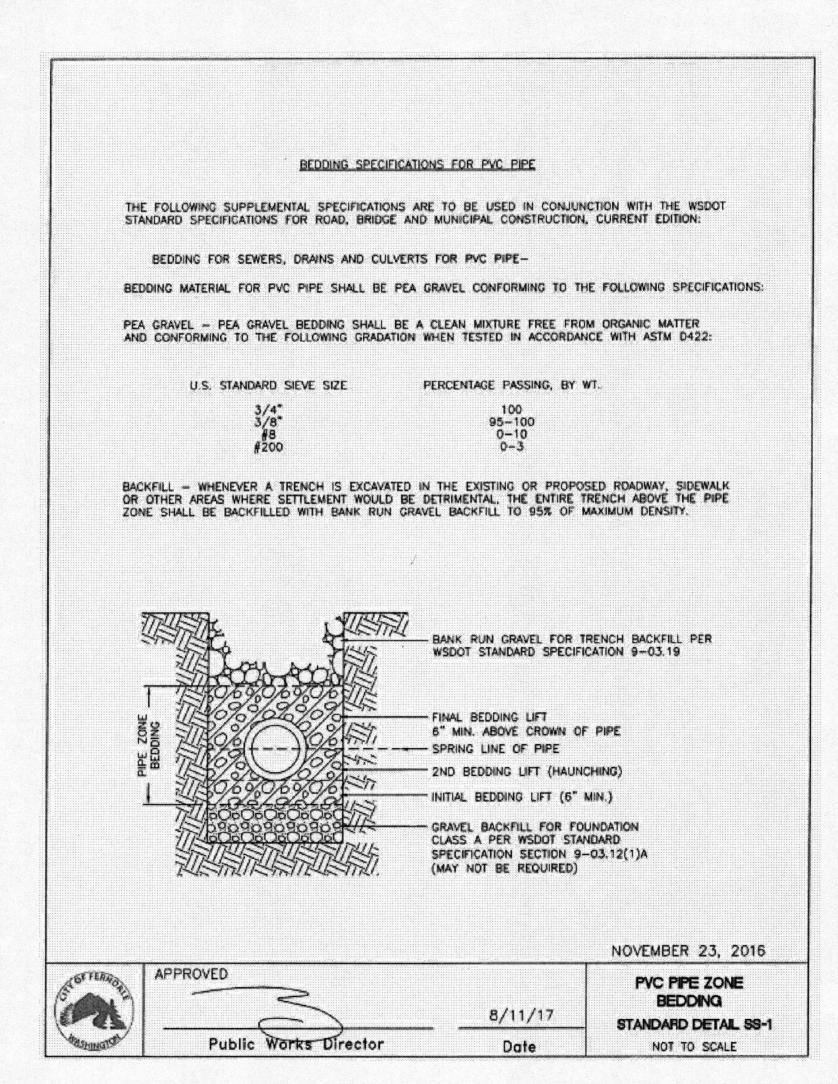

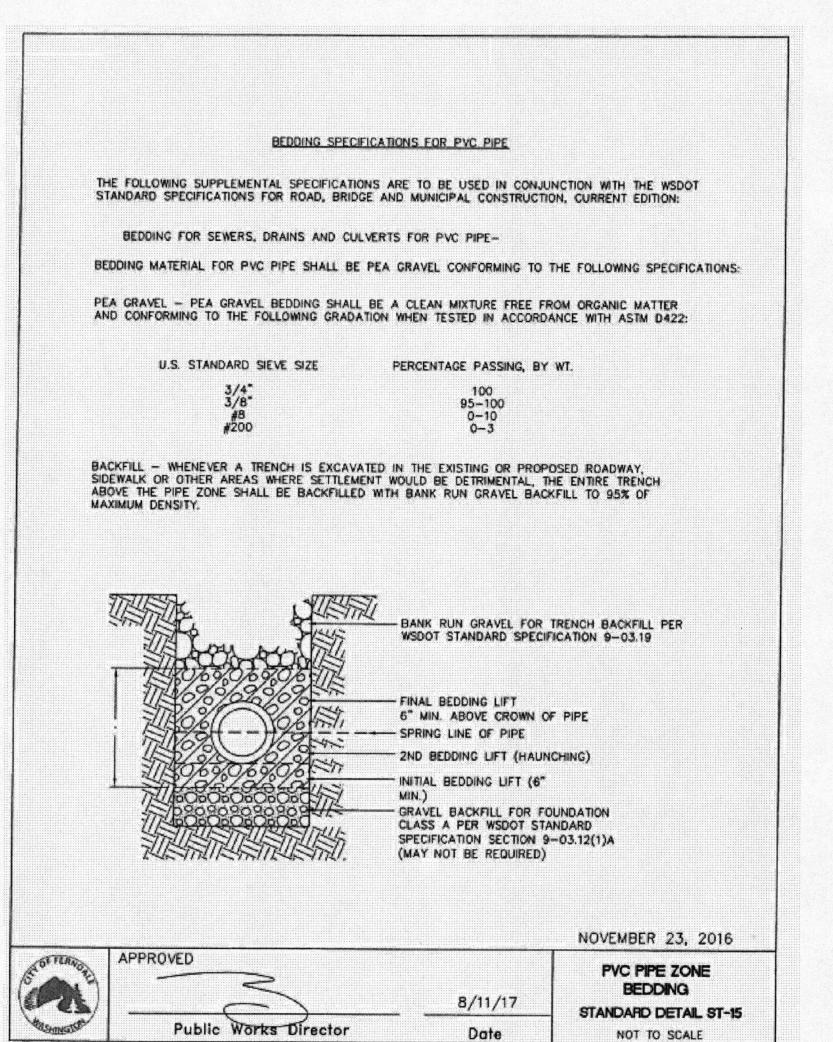

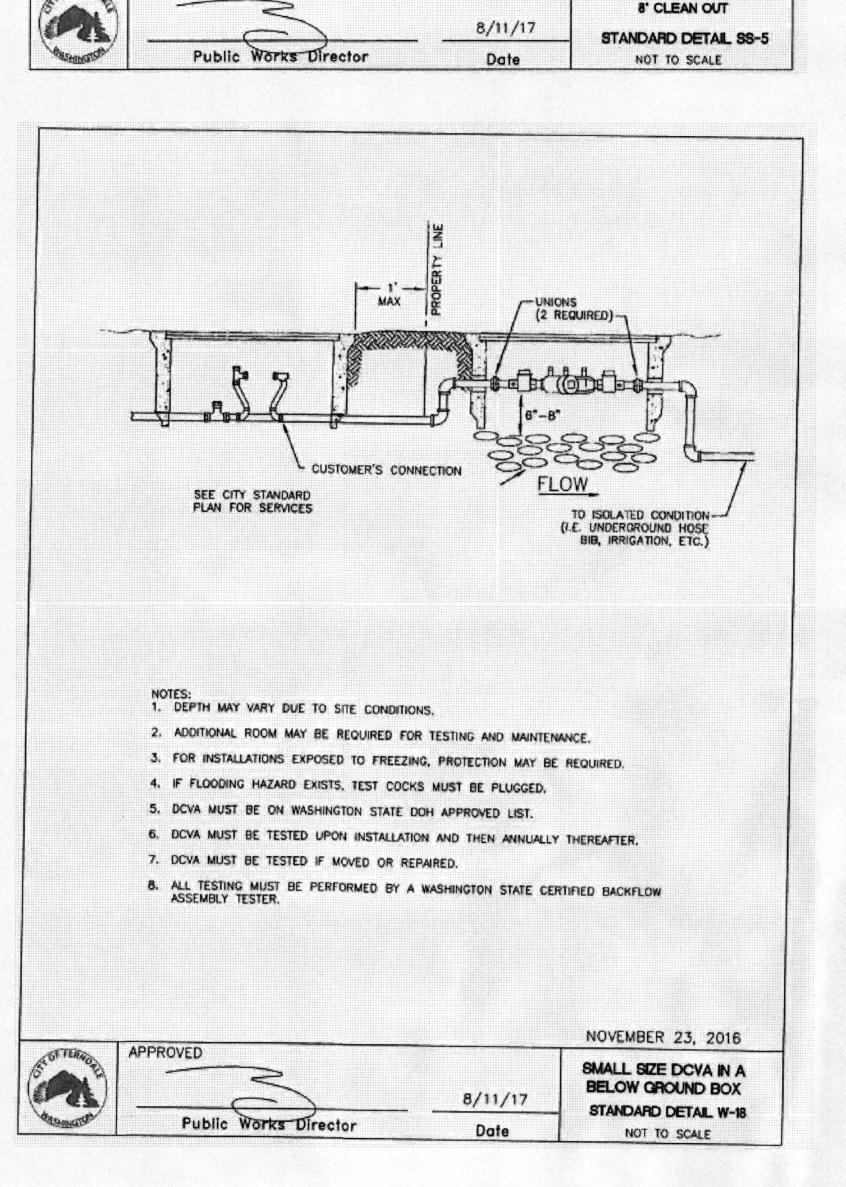

% RAISED SQUARES

PLAN FOR CLEANOUT SPACING

LACE PIPE ON APPROVED

AUGUST 4, 2017

SANITARY SEWER

BEDDING MATERIAL OR

UNDISTURBED SOIL PER CITY STANDARD SS-1.

PLUG TO BE SEALED IN SAME MANNER AS MAIN

SEWER JOINTS.

15" HEX BOLTS

1/2" WIDE, 1/8" HIGH RAISED BORDER

' SQUARE CONCRETE BLOCK TO ENCASE CLEAN-OUT. IF CLEAN-OUT

IS IN ASPHALT, THE BLOCK IS TO BE LEFT 2" LOW TO ALLOW FOR AN ASPHALT TOPPING OF LIKE MIXTURE AS THE SURROUNDING AREA. IN

ALL CASES THE CONCRETE BLOCK WILL BE 1-FOOT THICK AND FINAL ELEVATION SHALL BE FLUSH WITH THE SURROUNDING SURFACE.

BECTION (A)

CAST FRON RING AND COVER

APPROVED

NOT NECESSARY TO BOND COVER PIPE TO RING AT THIS POINT. BUTT TO RING AND ENCASE IN CONCRETE BLOCK.

NO. DATE

TY OF FERNDALE PUBLIC WORKS DEPARTMENT

CIVIL DETAIL

SITE PLAN NOTES

- ACCESSIBLE ROUTES OF TRAVEL ON THE SITE NOT TO EXCEED 5% SLOPE IN THE DIRECTION OF TRAVEL AND 2% CROSS SLOPE. LOCATION OF PROPOSED HC STALL NOT IDEAL DUE TO SITE CONSTRAINTS. THE WEST SIDE OF THE PROPERTY EXCEEDS 2% SLOPE AND PROPOSED DRIVE LOCATION CANNOT BE FURTHER NORTH.
- FIRE APPARATUS ACCESS: GC TO VERIFY FIRE LANES ARE MARKED AND SIGNED IN ACCORDANCE WITH THE CITY OF KENT REQUIREMENTS.
- C. THE GC IS RESPONSIBLE FOR PROCURING NECESSARY PERMITS, AS REQUIRED, FOR: FIRE HYDRANTS & WATER MAIN INSTALLATIONS, SPRINKLER SYSTEM SUPPLY MAIN AND FDC, SPRINKLER SYSTEM, AUTOMATIC FIRE ALARM SYSTEM AND MONITORING SYSTEMS, AS APPROPRIATE.
- G.C. TO COORD. WITH LOCAL FIRE DEPARTMENT THE LOCATION FOR THE LOCK BOX FOR ACCESS TO THE BUILDING AND
- PERIMETER FENCE AND EXTERIOR BUILDING AND SITE SIGNAGE TO BE APPLIED FOR AND PERMITTED SEPARATELY.
- THE ADDRESS ON THE BUILDING NEEDS TO BE VISIBLE FROM THE STREET PER FIRE DEPARTMENT REQUIREMENTS.
- GC TO COORDINATE ALL SITE AND SIGNAGE POWER NEEDS WITH THE TENANT.

FIRE DEPT. NOTES

FIRE HYDRANTS: REQUIRED FIRE FLOW, WILL DETERMINE THE REQUIRED MINIMUM NUMBER OF FIRE HYDRANTS, AVERAGE SPACING AND MAXIMUM DISTANCE AS OUTLINED IN 2012 IFC APPENDIX C, TABLE C105.1

AND AS OUTLINED IN CITY OF FERNDALE MUNICIPAL CODE

REQUIRED SYSTEMS: FIRE SPRINKLER SYSTEM, PERMIT AND PLAN REVIEW IS REQUIRED (CITY OF FERNDALE MUNICIPAL CODE AND 2012 IFC, SECTION 903.2). FIRE ALARM SYSTEM, PERMIT AND PLAN REVIEW IS REQUIRED.

ADDRESS IDENTIFICATION: COMMERCIAL BUILDINGS SHALL HAVE APPROVED ADDRESS NUMBERS, PLAINLY LEGIBLE AND VISIBLE FROM THE STREET OR ROAD FRONTING THE PROPERTY. THESE NUMBERS SHALL CONTRAST WITH THE BACKGROUND, NUMBERS SHALL BE A MINIMUM TWELVE INCHES IN HEIGHT.

EMERGENCY VEHICLE ACCESS:


EMERGENCY VEHICLE ACCESS AS RELATED TO ACCESS ROAD AND GATE ACCESS, NEED TO BE PROVIDED IN ACCORDANCE WITH CITY OF FERNDALE MUNICIPAL CODE.

A KNOX FIRE DEPARTMENT KEY LOCK BOX SHALL BE INSTALLED AT AN APPROVED LOCATION DETERMINED BY THE FIRE MARSHAL (2012 IFC, SECTION 506.1). THE KNOX BOX PART NO IS #3201 FOR SURFACE MOUNT OR #3220 FOR RECESS MOUNT. KNOX PRODUCTS CAN BE ORDERED ON LINE AT WWW.KNOXBOX.COM.

FIRE EXTINGUISHER(S):

FIRE EXTINGUISHERS WITH A MINIMUM RATING OF 2A: 10B:C SHALL BE ACCESSIBLE AT EVERY 75 FEET OF TRAVEL (2012 IFC, SECTION 906) OR AS SPECIFIED BY HAZARD LISTED IN 2012 IFC, TABLE 906.1. • RETAIL & OFFICE - 2A:10B:C WITHIN 75' TRAVEL DISTANCE

- INTERNATIONAL FIRE CODE PERMITS AND PLAN REVIEW: AN INTERNATIONAL FIRE CODE CONSTRUCTION PERMIT IS REQUIRED FOR THE INSTALLATION OF OR MODIFICATION TO AN AUTOMATIC FIRE-EXTINGUISHING SYSTEMS, PLANS ARE REQUIRED TO BE SUBMITTED FOR REVIEW AND APPROVAL (2012 IFC, SECTION 105.7.1).
- AN INTERNATIONAL FIRE CODE CONSTRUCTION PERMIT IS REQUIRED FOR THE INSTALLATION OR MODIFICATION OF AN UNDERGROUND WATER SUPPLY FOR AUTOMATIC FIRE SPRINKLER SYSTEMS. PLANS ARE REQUIRED TO BE SUBMITTED FOR REVIEW AND APPROVAL (2012 IFC, SECTION 105).
- AN INTERNATIONAL FIRE CODE CONSTRUCTION PERMIT IS REQUIRED FOR THE INSTALLATION OF OR MODIFICATION TO A FIRE ALARM AND DETECTION SYSTEM, PLANS ARE REQUIRED TO BE SUBMITTED FOR REVIEW AND APPROVAL (2012 IFC, SECTION 105.7.6).

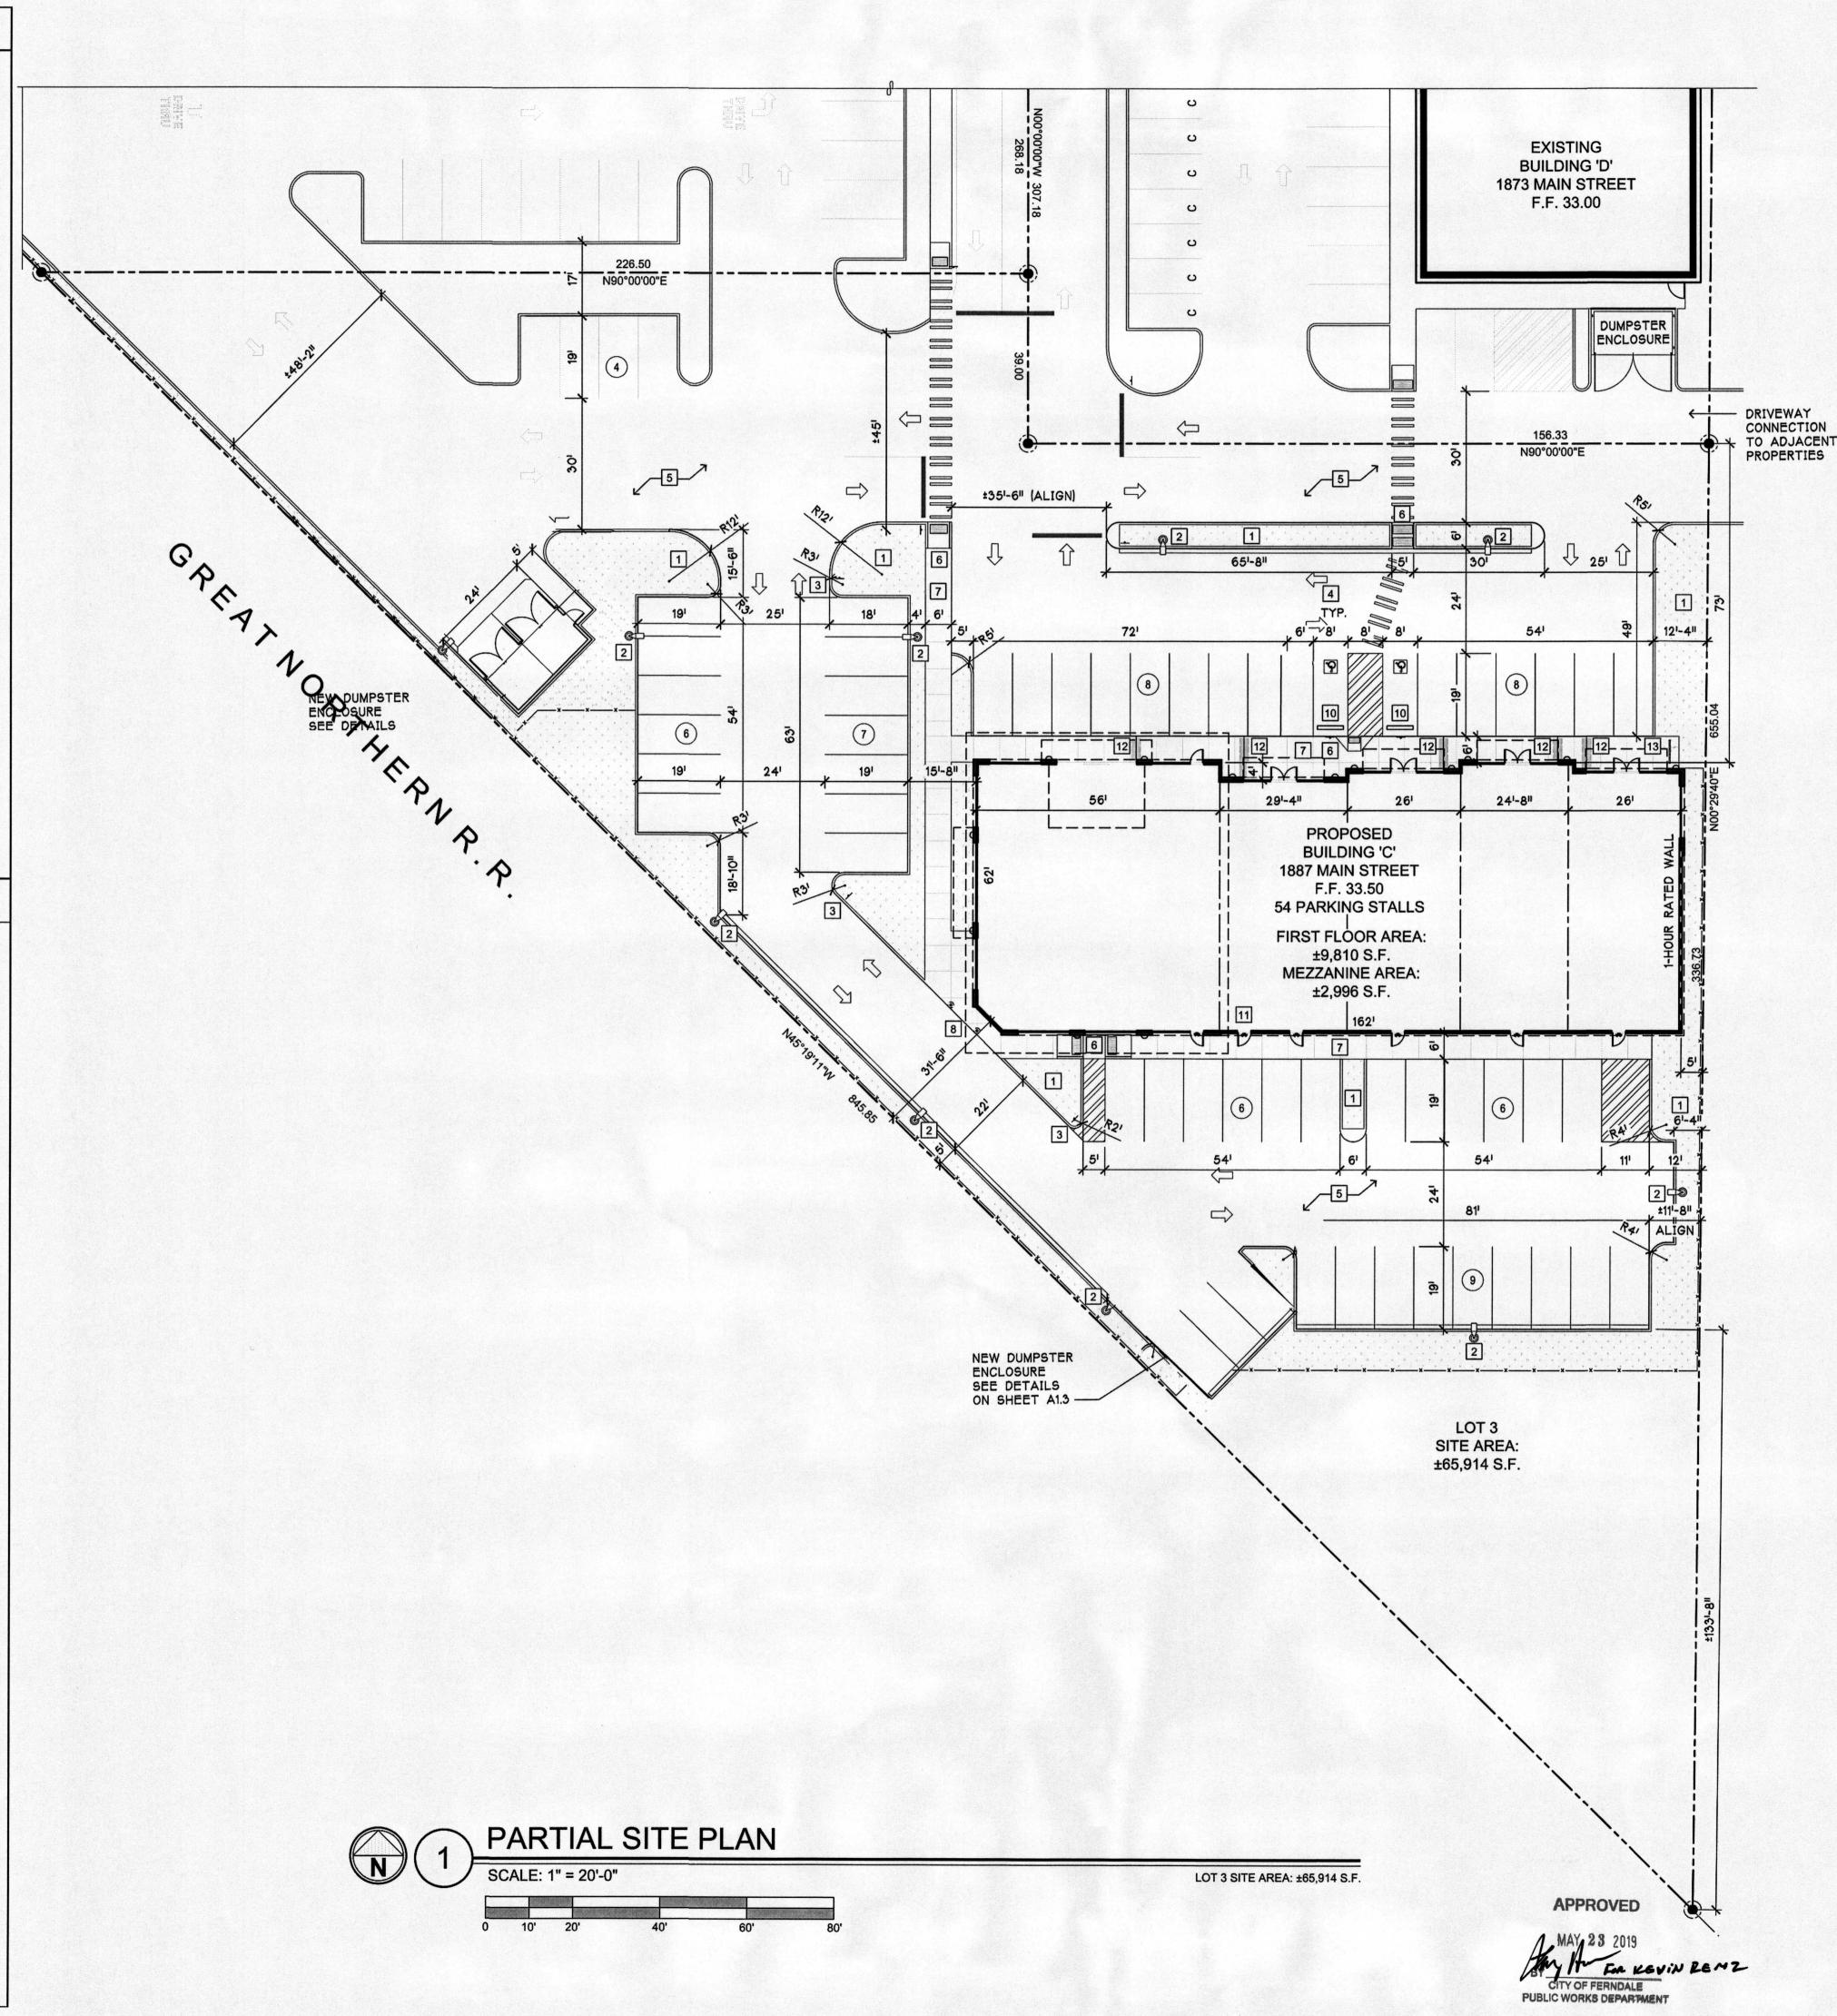

KEY NOTES

1 NEW LANDSCAPE AREAS SHOWN HATCHED PER LANDSCAPE DWGS. WITH 6" HIGH CONCRETE CURB PER DTLS 788

APPROX. LOCATION OF NEW LIGHTING FIXTURE, TYP. REFER TO ELECTRICAL DWGS AND DETAIL Q

SIGN TO BE POSTED STATING, "CAUTION - TRUCK MAY BE BACKING FOR REFUSE PICK-UP" ALONG THIS DRIVE AISLE, TYP. 3, (PER E-MAIL FROM RODD PEMBLE AT SANITARY SERVICE COMPANY, INC).

4 PAINTED DIRECTIONAL ARROW, TYP. PER DETAIL LOCATE ARROWS AND MARKINGS PER TENANT AND CITY OF FERNDALE REQ.

5 ASPHALT PAVING, TYP. PER CIVIL DWGS.

6 RAMP PER ENLARGED DETAIL (7)

6" HIGH SIDEWALK PER CIVIL DWGS. REFER TO FLOOR PLAN FOR ADDITIONAL DIMENSIONS AND RADIUS INFORMATION.

8 NEW BOLLARDS, TYP. X. COORDINATE EXACT LOCATION WITH TENANT. REFER TO FLOOR PLAN AND DETAIL 10

9 TRASH ENCLOSURE AND FLUSH CONCRETE PAD PER A1.2 ENLARGED DETAILS ON SHEET A1.3 AND CIVIL DWGS.

NEW HANDICAPPED STALLS PER CITY OF FERNDALE REQ. REFER TO DETAILS ON SHEET A1.2 FOR REQUIRED SIGNAGE AND WHEEL STOP INFORMATION.

11 GC TO COORDINATE WITH THE MECHANICAL, PLUMBING AND ELECTRICAL DWGS THE EXTERIOR BUILDING UTILITY LOCATIONS, INCLUDING BUT NOT LIMITED TO: EXTERIOR SIGNAGE POWER, POLE TRANSFORMER & UTILITY METERS, GAS METER AND HOSE BIBS.

12 METAL CANOPY THRU-CURB DRAINAGE PER DETAIL (8)

BIKE RACK FOR 2 BIKES PERMANENTLY AFFIXED TO CONCRETE SIDEWALK, SEE FIXTURE SCHEDULE.

SITE AND BUILDING DATA

LEGAL DESCRIPTION:

LOT 3 WALGREEN'S LLA AS REC AF 2040402803

EXISTING SITE & BUILDING DATA

SITE ADDRESS: PARCEL ID; NUMBER:

1887 MAIN STREET 98545; 3902293303930000 JURISDICTION: CITY OF FERNDALE, WHATCOM COUNTY

SECTION-TOWNSHIP-RANGE: PROPERTY NAME/OWNER: EXISTING/PRIOR USE: BLDGS ON PARCEL: LAND USE CODE:

29-T39N-R02E PENCO FERNDALE LLC VACANT LOT NONE

MC (ZONING MAP), C3/MXD MIXED USE COMMERCIAL

SITE IMPROVEMENT DATA:

BUILDING SETBACKS: FRONT: NONE; REAR: NONE; SIDE: NONE MAX. SITE COVERAGE: NONE; MAXIMUM HEIGHT: 45' OR 3 STORIES

LANDSCAPE SETBACKS:
PARKING LOT SIDE & REAR: 7'-O" MIN. PER FMC 18.74.140 PARKING LOT LANDSCAPE STANDARDS. DEVIATIONS ALLOWED PER DESIGN

GROSS PARCEL AREA: CONCRETE CURB/WALKWAY AREAS: ±65,894 S.F. ±3,604 S.F. TRASH ENCLOSURE & PAD AREA: ASPHALT PAVING AREAS: ±33,852 S.F. LANDSCAPE AREAS: ±9,846 S.F. UNDEVELOPED PERVIOUS AREA: ±7,838 S.F. PROPOSED BUILDING FOOTPRINT AREA: ±9,810 S.F.

PROPOSED BUILDING DATA

B AND/OR M AND/OR A-3 OCCUPANCY TYPE(S) (NON-SEPARATED USES PER IBC SEC. 508.3)

BUILDING CONSTRUCTION TYPE: V-B, FIRE-SPRINKLERED ALLOWABLE AREA PER FLOOR BASED ON IBC 504.2 AUTOMATIC SPRINKLER SYSTEM INCREASE & TABLE 503: 6,000 S.F., 1 STORY (A-3 OCCUPANCY), 6,000 x 3 = 18,000 S.F. MAX. BUILDING AREA FOR SINGLE STORY, ONE ADDITIONAL STORY ALLOWED.

PROPOSED USE:

RETAIL & OFFICE 12,806 S.F., ONE STORY W/ MEZZANINE PROPOSED BUILDING AREA: PROPOSED BUILDING HEIGHT: ±29'-6" OCCUPANCY BREAKDOWN: 12,806 / 100 = 128 OCC.

FIRE RESISTIVE & FIRE PROTECTION REQUIREMENTS PER IBC TABLES 601 AND 602 THERE ARE NO FIRE RESISTANCE RATINGS FOR ANY ELEMENTS OF THIS BUILDING, EXCEPT THE 1-HOUR RATED WALL ASSEMBLY ALONG THE EAST PROPERTY LINE PER FLOOR PLAN ON SHEET A2.1. AN APPROVED NFPA 13 FIRE SPRINKLER SYSTEM SHALL BE INSTALLED THROUGHOUT THE BUILDING PER FIRE DEPT REQ. (SEPARATE PERMIT). SEE ADDITIONAL NOTES ON SHEET A1.1.

ENERGY CODE REQUIREMENTS

REFER TO "LEVELS OF INSULATION" NOTES ON SHEET A2.1

PARKING REQUIREMENTS: TABLE 2: OFF-STREET PARKING REQUIREMENTS USE: RETAIL & PROFESSIONAL OFFICE MINIMUM PARKING REQUIREMENTS: RETAIL: 1 SPACE PER EACH 333 SQ. FEET; OFFICE: 1 SPACE PER EACH 300 SQ. FEET REQUIRED BICYCLE SPACES: 1 SPACE PER EACH 10 VEHICLE PARKING STALLS, 5 BICYCLE SPACES PROVIDED.

PARKING BREAKDOWN: 6,356 (RETAIL) / 333 = 19 + 6,450 (OFFICE) / 300 - 22 = 41 SPACES REQUIRED, 54 SPACES PROVIDED: 52 STANDARD STALLS AND 2 HANDICAPPED VAN STALLS.

OFF-STREET PARKING DIMENSION REQUIREMENTS: BASED ON FMC 18.76.140 PARKING LOT STANDARDS FOR 90-DEGREE PARKING: PARKING STALL WIDTH: 9' (COMPACT: 8'); PARKING STALL LENGTH: 191 (COMPACT: 161); WIDTH OF MAIN DRIVEWAY AISLE: 251 WIDTH OF PARKING LOT ACCESS DRIVEWAY: 24

REGISTERED ARCHITECT DANIEL B. TAYLOR

ARCHITECT:

DANIEL B. TAYLO CONTACT: DANIEL B. TAYLO 1639 HARBOR AVE. SW, #30 SEATTLE, WA 98126 PHONE: (206) 465-2491 EMAIL: dan@nicholsondev.

- PERMIT SET NOT FOR CONSTRUCTI

REVISIONS

ISSUE DATES **DESIGN APPROVAL:**

PERMIT SUBMITTAL: PERMIT RECEIVED: BID DOCS: CONSTR. DOCS: SHEET INFORMATION

24"x36" SCALE: AS NO PLOT DATE: 07/1 CAD FILE: 16-11 JOB NUMBER: DBT/ CHECKED: DRAWN: STATUS: PERMIT :

PARTIAL SITE PLAN