

GENERAL CONDITIONS

NORDIC YACHT Draining

1. All materials, workmanship and testing shall conform to A.P.W.A., 1981 Edition Specifications, unless otherwise noted within these plans.

2. The vertical datum is a U.S.G.S. Bench mark (brass disk) located at the southeast corner of the main

3. A two year maintenance bond for 10% of the project cost for the City of Ferndale's portion, shall be submitted to the City of Ferndale prior to acceptance of the project.

4. The ditch located at the outlet of the storm pipe, shall be dug to the south property line and aligned with the existing culvert on the ajoining property.

GRAVITY STORM SEWER SYSTEM

1. Sewers shall be constructed as shown on the plane and as specified herein.

2. Non-reinforced concrete sewer pipe with bell spigot ends shall conform to Section 60-3.01A of the Standard Specifications. All pipe shall be coupled with a "Standard ()-Ring" type of rubber gasket.

3. PVC pipe shall meet the requirements of Section 60-3.01G with joints using restrained gasket and con-

4. Pipe installation at locations, lines and grades as shown on the plans, shall be in conformance with provisions of Sections 60, 61, and 62 of the Standard Specifications.

5. Bedding shall be Type 2 for flexible pipe except that pea gravel shall be used for PVC storm pipe, and shall conform to Section 61-5 of the Standard Specifications.

6. All backfill in trenches within the street right-of-way shall be Class "B" bankrun gravel and shall be compacted to 95% of its maximum dry density as defined in Section 13-3.10E5.

7. Trench backfill outside the street right-of-way shall meet the requirements of Section 61-6 of the

8. Catch basins shall conform to the material and installation requirements of Section 64 of the Standard Specifications, and the castings shall have the diagonal grate pattern (Bicycle Type) as noted on Standard Plan Numbers 48 and 49.

PAVING AND GRADING SPECIFICATIONS

1. The subgrade preparation shall meet the requirements of Section 12, 13, and 15 of the General Specifications. Payment, however, will be by lump sum.

Bank run gravel base shall be Class "B" and shall be installed in conformance with Section 26 of the General Specifications. Payment will be by cubic yard calculated by compaction in place volume.

3. Asphalt treated base shall meet the material and installation requirements of Section 33 of the General 3. Aspnair treated base shall meet the material and installation requirements of Section 33 of the General Specifications. Payment will be by a square yard measurement, which shall be considered full compensation for furnishing all labor, equipment, and materials for fullfilling the requirements of the

4. Asphalt concrete pavement shall meet the requirements as outlined in Sections 27 and 32 of the A.P.W.A. 4. Aspnait concrete pavement snail meet the requirements as outlined in Sections 21 and 32 of the A.P.W.A. Specifications. Payment shall be per square yard and shall be full compensation for furnishing, heating hauling, spreading, rolling and all other work incidental to fullfilling the requirements.


SPECIFICATIONS FOR SIDEWALKS AND CURB & GUTTER

1. Cement concrete sidewalks shall meet material and installation requirements of the City of Ferndale and Section 42 of the Standard Specifications. If any differences arise between the two Specifications, the City of Ferndale's shall prevail. The width of the sidewalk shall be 5 feet.

2. Before the forms are set, the subgrade shall be graded to within one inch of established grade and the area between the sidewalk and the adjacent private property shall be shaped to line, grade and section

3. Any low areas in the subgrade shall be backfilled and compacted with bank run gravel and/or 1 1/2"

4. Cement concrete curb and gutter shall be type A-1 and shall meet material and installation requirements the two specifications, the City of Ferndale's shall prevail.

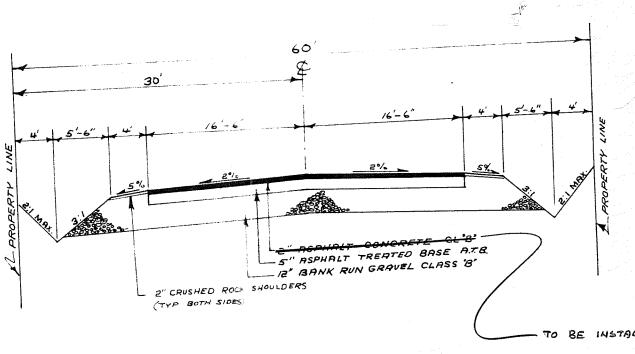

ROAD SECTION


NORTHWEST CONSULTANTS CIVIL & STRUCTURAL ENGINEERING 1401 ASTOR BELLINGHAM, WA. (206) 676 · 9058

OF FERNDALE NORDIC YACHT

SCALE AS SHOWN DATE: 7-16-85 DRAWN BY PSK CHECKED BY: EF JOB NO: 85-12-16

NORTHWEST INDUSTRIAL PARK

ROAD AND STORM DRAINAGE PLAN PROFILE AND SPECIFICATIONS

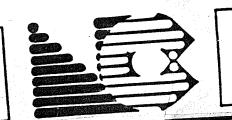

3. The vertical datum is a U.S.G.S. Bench mark (brass disk) located at the southeast corner of the main street bridge. Elevation = 34.90. 4. All pipe grades and inverts are computed from centerline of manhole to centerline of manhole, or

GENERAL CONDITIONS

otherwise noted within these plans.

centerline of catch basin to centerline of catch basin. 5. A two year maintenance bond for 10% of the project cost shall be submitted to the City of Ferndale


prior to acceptance of the project. 6. The contractor shall obtain and keep in force during the term of the contract, public liability and


property damage insurance as outlined in Section 7-1.18 of the A.P.W.A. Specifications. 7. The contractor shall comply with the Public Convenience and Safety Requirements as detailed in Section 7-1.23 of the A.P.W.A. Specifications.

SPECIFICATIONS FOR SANITARY SEWERS


GRAVITY SEWER

- 1. Non-reinforced concrete sewer pipe with bell and spigot ands shall conform to ASTM Designation C-14 Extra Strength. All pipe shall be coupled with a "Standard O-Ring" type of rubber gasket.
- 2. PVC pipe and fittings shall conform to ASTM D-3034, SDR 35 latest issue. All pipe and fittings shall be made for PVC compounds as defined and described in ASTM D1784. Joints made with pipe fittings or with belled end pipe shall have elastomeric gasket joints.
- 3. Fittings, unless otherwise indicated, for various pipe shall be the same as the pipe material.
- 4. Manhole installation and testing shall conform to the requirements of Section 63 of the Standard Specifications and shall be constructed at such locations and to such dimensions as shown on the plans and standard detail. Manholes, Type I-48 shall be used for depths greater than 8! - 0".
- 5. Cleanouts shall be constructed as per Standard Plan No. 45 of the A.P.W.A. Specifications. Cleanouts on service lines shall be constructed as shown in the side sewer details.
- 6. Pipe installation and testing at locations, lines and grades as shown on the plans, shall be in conformance with provisions of Secitons 60, 61, and 62 of the Standard Specifications.
- 7. Bedding for PVC pipe shall be Type 2 and shall be in accordance with Section 61-5 of the Standard Specifications.
- 8. All backfill in trenches shall be bank run gravel Class "B" and compacted to 95% density as determined by the sand-cone method. ASTM D-1556.
- 9. Backfill above the pipe zone shall be installed in such a manner that the pipe will not be shifted out of position nor damaged by impact or overloading.
- 13. Materials excavated from the trench shall be disposed of by the contractor to an off-site location.

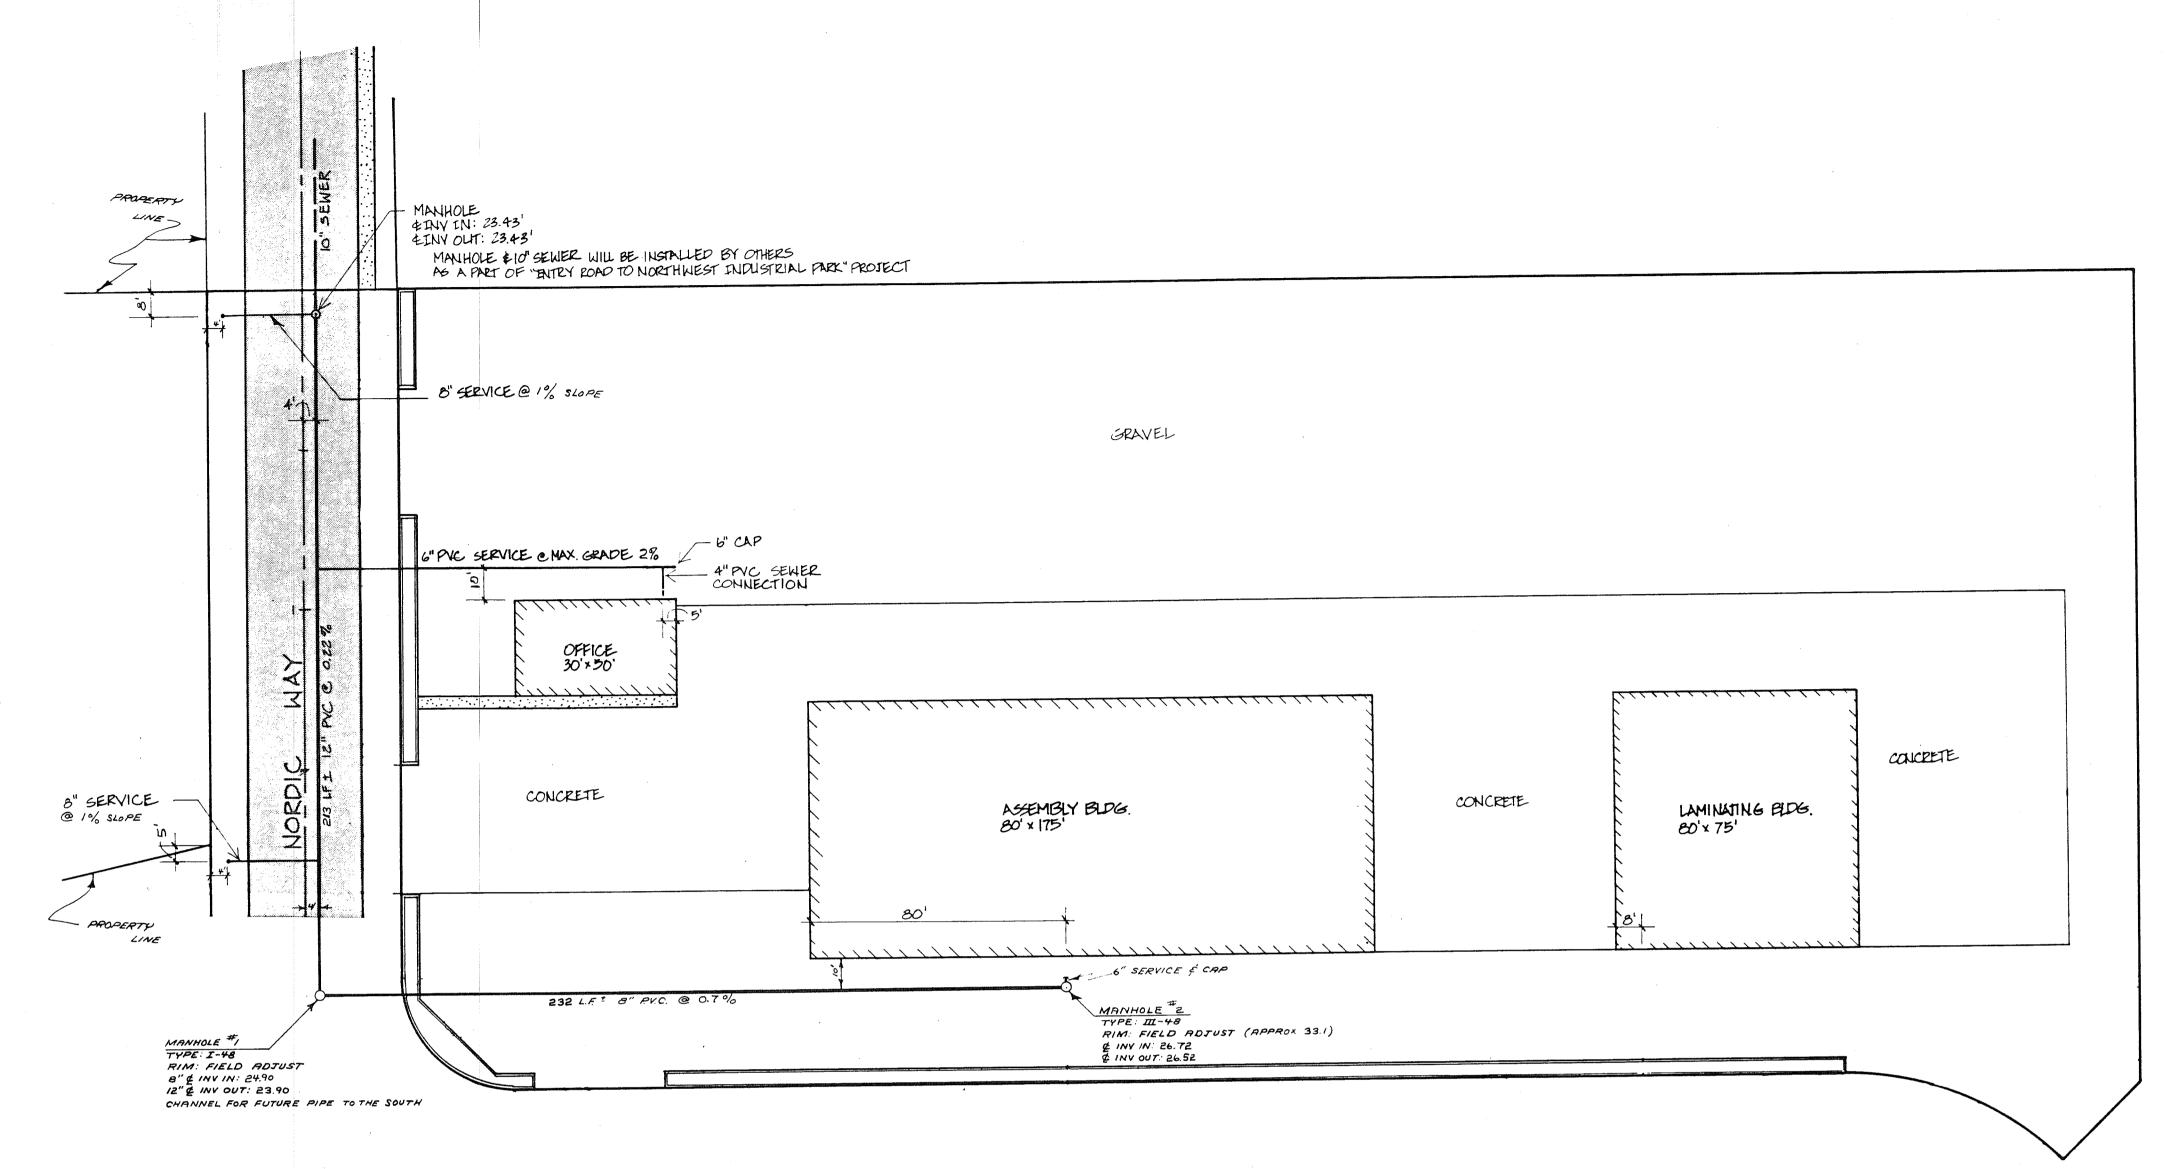

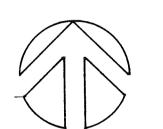

PLAN SCALE I"= 30'

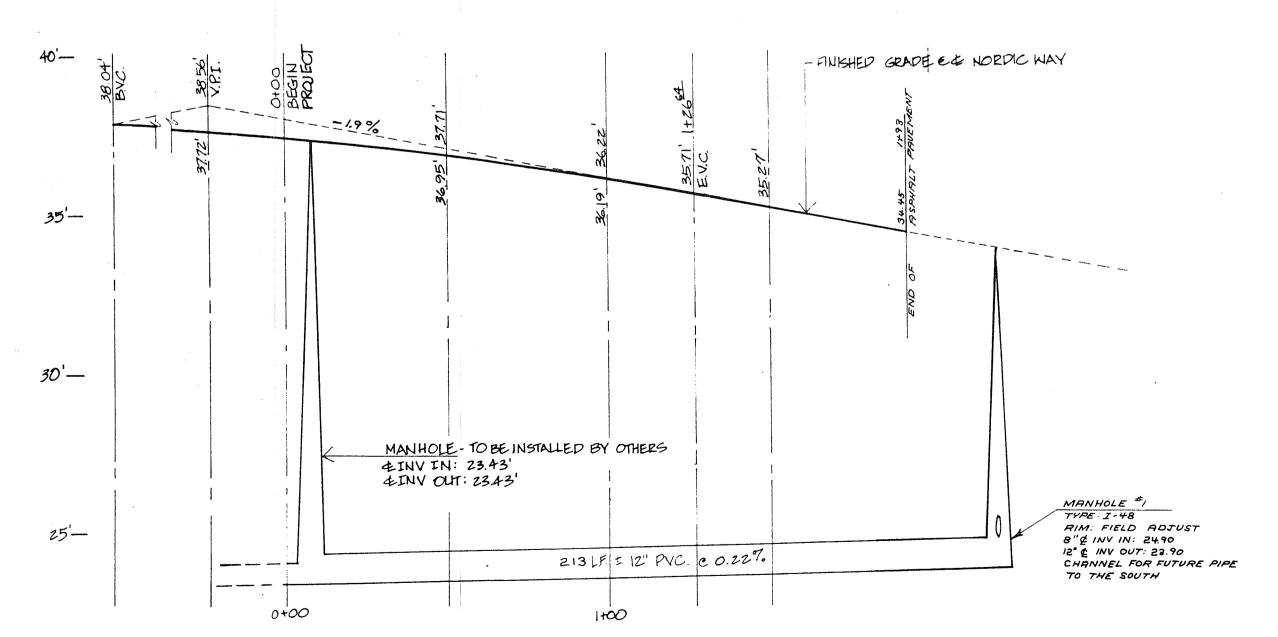

PROFILE HORIZ. SCALE 1"= 30' VERT. SCALE 1"= 3'

CONSULTANTS CIVIL & STRUCTURAL ENGINEERING 1401 ASTOR BELLINGHAM, WA. (206) 676 · 9058

CITY OF FERNDALE NORDIC YACHT

SCALE: AS SHOWN DATE: 7-16-05 DRAWN BY: PSW CHECKED BY: EF JOB NO: 85-1216

MARK DESCRIPTION DATE BY EYAT REQUESTED COSEPSE TO NORTHWEST INDUSTRIAL

SANITARY SEWER PLAN PROFILE, AND SPECIFICATIONS



GENERAL CONDITIONS

2. The contractor must assume the risk of meeting quicksand, hardpan, boulders, clay, rubbish, existing utility lines, water table and other unforseen obsta-

3. The vertical datum is a U.S.G.S. Bench mark (brass disk) located at the southeast corner of the main street bridge. Elevation = 34.90.


4. A two year maintenance bond for 10% of the project cost for the City of Ferndales portion, shall be submitted to the City of Ferndale prior to acceptance of the project.


5. The contractor shall obtain and keep in force during the term of the contract, public liability and property damage insurance as outlined in Section 7-1.18 of the A.P.W.A. Specifications.

6. The contractor shall comply with the Public Convenience and Safety Requirements as detailed in Section 7-1.23 of the A.P.W.A. Specifications.

WATER DISTRIBUTION SYSTEM

- 1. Water mains, service lines, valves and fittings shall be constructed as shown on the plans, as required by the State Department of Public Health, the City of Ferndale, and as specified hereon.
- 2. Water pipe and fittings shall be Ductile iron pipe Class 50 with cement lining and shall comply with Section 72-3 of the Standard Specifications.
- 3. All PVC pipe and fittings shall be Class 200 and shall conform to ASTM D2241 or 1785 Specifications current issue.
- 4. Buried gate valves shall meet the material and installation requirements as outlined in Section 75 of the Standard Specifications. They shall have a non-rising stem and shall open counterclockwise.
- 5. All gate valves adjacent to a tee or cross shall be flange connected.
- 6. Valve boxes shall be cast iron, 2-piece slip type extension, equal to Atlas Foundry Company or Olympic Foundry Company and shall conform to Section 75 of the Standard Specifications.
- 7. Fire hydrants shall meet the material and installation requirements as outlined in Section 77 of the Standard Specifications. Hydrant shall be of traffic type with designated replaceable break points.
- 8. The hydrant shall be installed so that the direction of the pumper connection faces the roadway.
- 9. The fire hydrants shall be an Iowa F5110 or approved equal.
- 10. All backfill in trenches shall be bank run gravel Class "B" and it shall meet the material requirements of Section 73-2.04 and 73-2.02A of the Standard Specifications or as approved by the Public Works Department and shall be compacted to 95% of its maximum dry density as defined by ASTM D-1557-64T.
- 11. The 6", 8" and 10" pipe shall be laid to the alignment and grades furnished by the engineer. Deflections from a straight line or grade as required by vertical curves, horizontal curves or offsets shall not exceed the maximum deflections.recommended by the pipe manufacturer. Where the alignment or grade requires deflections in excess of recommended limits with standard pipe lengths, a sufficient number or shorter lengths shall be used.
- 12. Trench depth where 6", 8" and 10" pipe is used shall be as required to provide a minimum of 42" cover from finished grade. All other water line shall be a minimum of 36" cover from finished grade.
- 13. No pipe shall be covered until it has been inspected and permission to backfill has been obtained. Backfilling and surface restoration shall follow closely the installation and the testing of the pipe.
- 14. Concrete blocking shall meet the requirements of Section 74-2.13 of the Standard Specifications.
- 15. Concrete blocking shall be placed at all abrupt bends, both horizontal and vertical, and at tees and dead ends. No blocking shall be required at hydrant tees if hydrant is secured to water main by flanged pipe, restraining joints or by rods and shackles.
- 16. Prior to acceptance of the work, all sections of pipe shall be subjected to a hydrostatic test as per Section 74-2.11 of the Standard Specifications.
- 17. Sterilization of the water mains shall be accomplished by the contractor in accordance with the requirements of the State Fealth Department, the City of Ferndale and in a manner satisfactory to the engineer and as outlined in Section 74-2.12 of the Standard Specifications.
- 18. Butterfly valves are acceptable and shall meet all the requirements of Section 75-2.05 of the Standard Specifications.
- 19. The water services including the corporation stop shall meet all the material and workmanship requirements of the City of Ferndale.

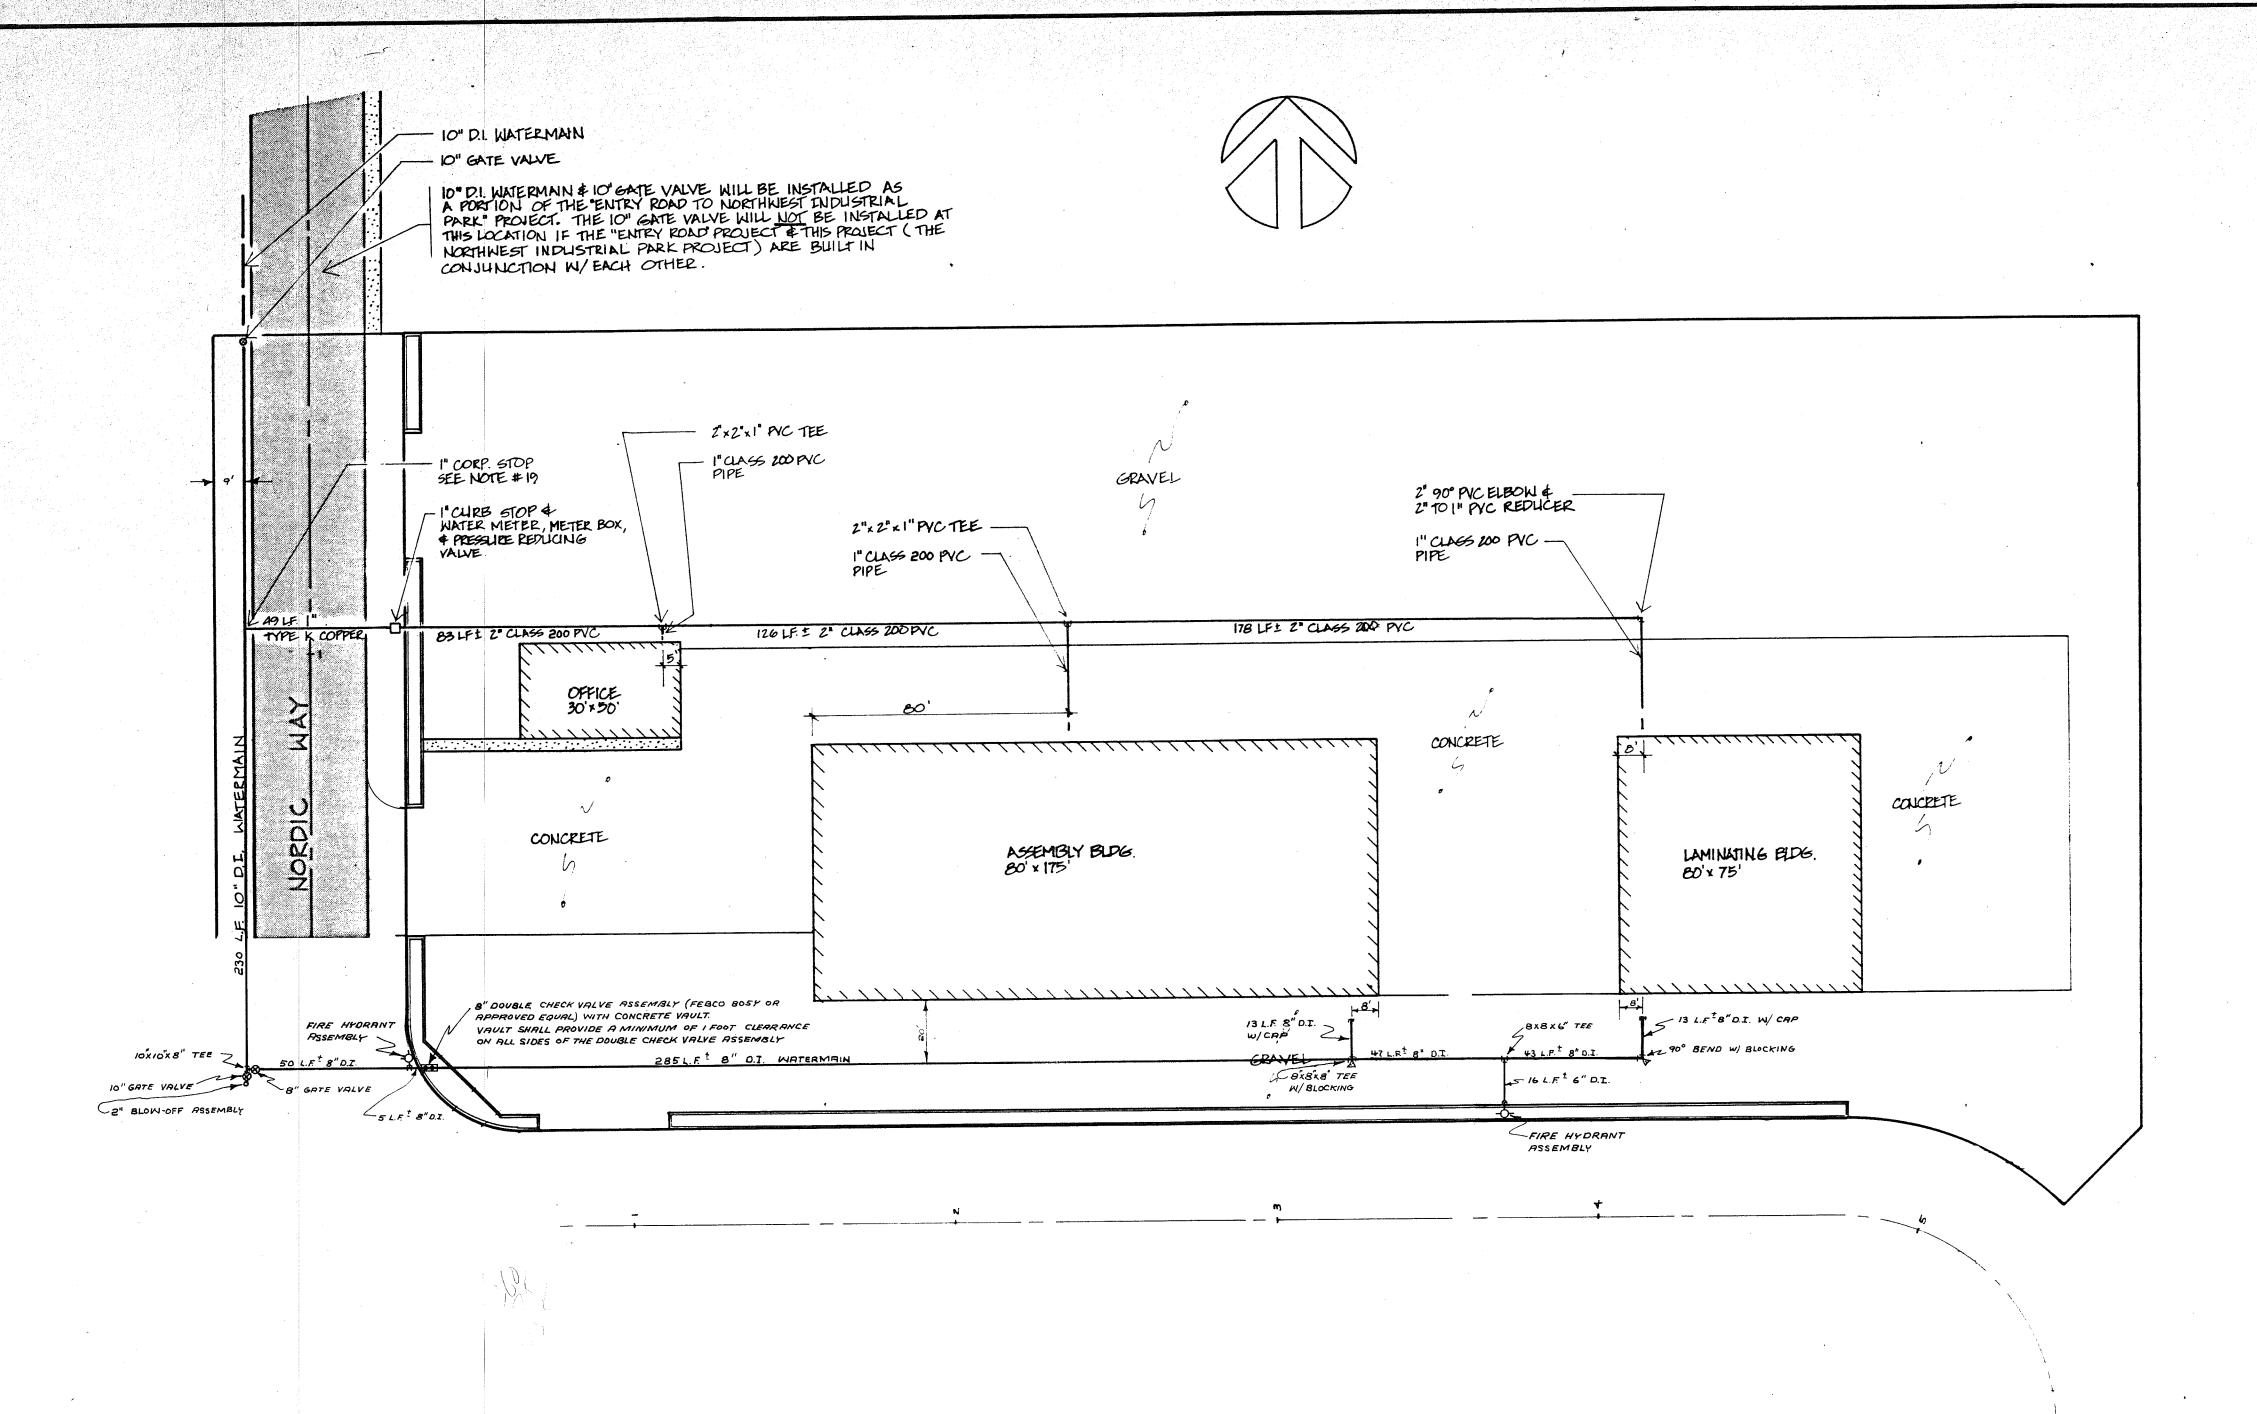

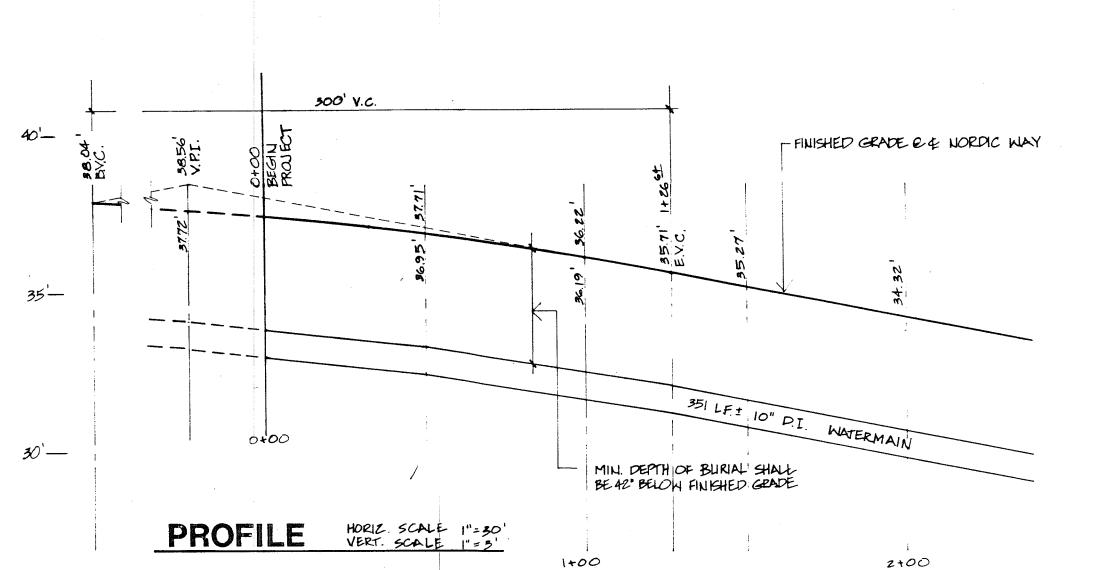

NORTHWEST CONSULTANTS CIVIL & STRUCTURAL ENGINEERING 1401 ASTOR BELLINGHAM, WA. (206) 676 · 9058


OF FERNDALE NORDIC YACHT

SCALE AS SHOWN DATE: 7-16-05 DRAWN BY: PSW CHECKED BY: EF JOB NO: 85-1216

MARK DESCRIPTION DATE

NORTHWEST INDUSTRIAL PARK

WATER DISTRIBUTION SYSTEM PLAN, PROFILE, AND SPECIFICATIONS

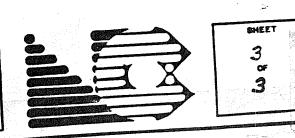

JOB NO. 85-1326

