# **GENERAL NOTES:**

- WITHIN ROAD RIGHT—OF—WAY OR IN EASEMENTS TO BE DEDICATED TO THE CITY OF FERNDALE
- 4. SITE CLEARING SHALL INCLUDE THE LOCATION AND REMOVAL OF ALL ABOVE GROUND AND BURIED
- CONTRACTOR SHALL RESTORE ALL PRIVATE AND PUBLIC PROPERTY DISRUPTED BY THE PROJECT IMMEDIATELY AFTER CONSTRUCTION.
- 6. CONTRACTOR SHALL INFORM THE ENGINEER AND OBTAIN APPROVAL FROM THE CITY OF FERNDALE PUBLIC WORKS DEPARTMENT OF ANY PROPOSED CHANGES IN PLAN PRIOR TO CONSTRUCTION OF THAT CHANGE. CONTRACTOR SHALL KEEP RECORD OF DEVIATIONS AND FORWARD TO THE
- 7. THE LOCATIONS OF UNDERGROUND FACILITIES SHOWN ON THESE PLANS ARE BASED. ON FIELD SURVEYS AND LOCAL UTILITY COMPANY RECORDS. IT SHALL BE THE CONTRACTORS FULL RESPONSIBILITY TO CONTACT THE VARIOUS UTILITY COMPANIES TO LOCATE THEIR FACILITIES PRIOR TO STARTING CONSTRUCTION, NO ADDITIONAL COMPENSATION SHALL BE PAID TO THE CONTRACTOR FOR DAMAGE AND REPAIR TO THESE FACILITIES CAUSED BY HIS WORK FORCE. CALL 1-800-424-5555.
- 8. ALL DIMENSIONS AND GRADES SHOWN ON THE PLANS SHALL BE FIELD VERIFIED BY THE CONTRACTOR PRIOR TO CONSTRUCTION. CONTRACTOR SHALL NOTIFY THE CONSTRUCTION MANAGER IF ANY DISCREPANCIES EXIST PRIOR TO PROCEEDING WITH CONSTRUCTION FOR NECESSARY PLAN OR GRADE CHANGES. NO EXTRA COMPENSATION SHALL BE PAID TO THE CONTRACTOR FOR WORK HAVING TO BE REDONE DUE TO DIMENSIONS OR GRADES SHOWN INCORRECTLY ON THESE PLANS IF SUCH NOTIFICATION HAS NOT BEEN GIVEN.
- 9. THE CONTRACTOR SHALL BE RESPONSIBLE FOR PROVIDING ADEQUATE SAFEGUARDS, SAFETY DEVICES, PROTECTIVE EQUIPMENT, FLAGGERS, AND ANY OTHER NEEDED ACTIONS TO PROTECT THE LIFE, HEALTH AND SAFETY OF THE PUBLIC, AND TO PROTECT PROPERTY IN CONNECTION WITH THE PERFORMANCE OF WORK COVERED BY THE CONTRACTOR. ANY WORK WITHIN THE TRAVELED RIGHT-OF-WAY THAT MAY INTERRUPT NORMAL TRAFFIC FLOW SHALL REQUIRE AT LEAST ONE FLAGGER FOR EACH LANE OF TRAFFIC AFFECTED. ALL SECTIONS OF THE WSDOT STANDARD SPECIFICATIONS 1-07.23(1) - TRAFFIC CONTROL SHALL APPLY.
- 10. ALL DISTURBED AREAS SHALL BE COVERED WITH MULCH OR WOOD CHIPS WHILE NOT UNDER CONSTRUCTION.
- 11. AN APPROVED COPY OF THESE PLANS MUST BE ON-SITE WHENEVER CONSTRUCTION IS IN PROGRESS.

### STORM NOTES:

1 AS-BUILT REVISIONS FOR RECORD DRAWINGS

2 REVISED PER CITY AS-BUILT REVIEW DATED MAY 5, 2008

- A. TYPE 1 CATCH BASINS SHALL BE PER WS-DOT STANDARD PLAN B-1. TYPE 2 CATCH BASINS SHALL BE PER WS-DOT STANDARD PLAN B-1E. CONCRETE INLETS SHALL BE PER WS-DOT STANDARD PLAN B-26. WHERE LOCATED IN CURB GUTTER LINE CATCH BASIN SHALL BE THRU-CURB INLET FRAME AND GRATE IN ACCORDANCE WITH CITY OF FERNDALE STD. DRAWING R-8. VANED GRATES SHALL BE USED IN ACCORDANCE WITH WSDOT STD PLAN B-2b.
- B. STORM DRAINAGE PIPE SHALL CONFORM TO WSDOT SECTION 7-01, AND CITY OF FERNDALE STANDARDS, SECTION 619.

DRAWN BY: DATE: CHECKED BY: DATE:

ADT 03/25/08

NGR 07/24/08


# STREET NOTES:

- D. SIDEWALK RAMPS SHALL BE IN ACCORDANCE WITH WSDOT STANDARD PLAN
- E. CONTRACTOR SHALL VERIFY ALL GRADES AND DIMENSIONS PRIOR TO CURE

- A. ALL WATER MAIN PIPE SHALL BE DUCTILE IRON, CLASS 50, WITH CEMENT LINING ACCORDING TO AWWA STANDARD H3-71, C151-71, AND C104-71, AND CITY OF FERNDALE STANDARDS 702 AND 705.
- B. CONCRETE THRUST BLOCKING SHALL BE INSTALLED IN ACCORDANCE WITH CITY OF FERNDALE STANDARD DETAILS W-2, W-3, AND W-4. ALL THRUST BLOCKING SHALL BE IN ACCORDANCE WITH WSDOT 7-09.3(21).
- C. FIRE HYDRANTS SHALL BE INSTALLED PER FERNDALE STANDARDS DETAIL W-1.
- D. CHLORINATION AND DISINFECTION OF WATER MAINS SHALL BE IN ACCORDANCE WITH AWWA SECTION C651.
- E. TEST PRESSURE FOR WATER MAIN ACCEPTANCE SHALL BE 225 PSI AND TESTING SHALL BE PERFORMED ACCORDING TO CITY OF FERNDALE REQUIREMENTS. ALL DISINFECTION AND BACTERIOLOGICAL TESTS SHALL BE CONDUCTED BY THE CITY OF FERNDALE LABORATORY. THE PIPE WILL NOT PASS UNLESS A ZERO BACTERIA COUNT IS OBTAINED FOR TWO CONSECUTIVE TESTS 24 HOURS APART.
- F. BACKFILL FOR WATER MAINS SHALL BE GRAVEL BASE IN ALL TRAFFIC AREAS. COMPACTED TO 95% OPTIMUM DENSITY. BEDDING AND BACKFILL FOR ALL WATER PIPE SHALL BE PER WSDOT 7-09.3(9), 7-09.3(10), AND 7-09.3(11).
- G. ALL PIPE SHALL HAVE A MINIMUM COVER OF 3.5-FEET FROM THE CROWN OF THE PIPE TO THE FINISHED SURFACE GRADE.
- H. ALL VALVES SHALL BE EITHER GATE OR BUTTERFLY TYPE VALVES AND SHALL HAVE SLIP TYPE CAST IRON VALVE BOXES. SHORT BODY VALVES SHALL BE SUITABLE FOR A NON-SHOCK SHUT-OFF PRESSURE OF 130 PSI. ALL VALVES SHALL BE RESILIENT SEAT VALVES AND SUITABLE FOR DIRECT BURIAL. VALVES SHALL BE IRON BODY FULL BRONZE MOUNTED. AND SUITABLE FOR INSTALLATION WITH THE TYPE AND CLASS OF PIPE USED. ALL VALVES SHALL HAVE NON-RISING STEMS, SHALL OPEN COUNTERCLOCKWISE, AND SHALL BE EQUIPPED WITH A 2-INCH SQUARE OPERATING NUT. VALVES WILL HAVE EITHER FLANGED OR MECHANICAL-JOINT ENDS.
- I. CONNECTION TO EXISTING WATER MAINS: THE CONTRACTOR MUST NOTIFY THE FERNDALE PUBLIC WORKS DEPARTMENT OF A PROPOSED CONNECTION TIME AT LEAST FOUR WORKING DAYS IN ADVANCE, ALL CONNECTIONS SHALL BE MADE BY THE CONTRACTOR IN THE PRESENCE OF A REPRESENTATIVE OF THE FERNDALE PUBLIC WORKS DEPARTMENT.

### **SEWER NOTES:**

- B. SEWER PIPE SHALL BE IN ACCORDANCE WITH WSDOT 9-05.12. BEDDING AND BACKFILL FOR SEWER PIPE SHALL BE IN ACCORDANCE WITH CITY OF FERNDALE SS-15.
- C. CONNECTIONS TO EXISTING SEWER SHALL BE PERFORMED IN THE PRESENCE OF A REPRESENTATIVE OF THE CITY OF FERNDALE.
- D. SANITARY SEWER SERVICES SHALL BE PVC PIPE CONFORMING TO ASTM D3034 SDR 35 AND IN IN ACCORDANCE WITH CITY OF FERNDALE STANDARD PLAN SS-6. BEDDING AND BACK FILL SHALL BE AS SHOWN IN THE STANDARD DETAILS. ALL SIDE SEWERS SHALL BE INSTALLED AT A MINIMUM 2.0% SLOPE.

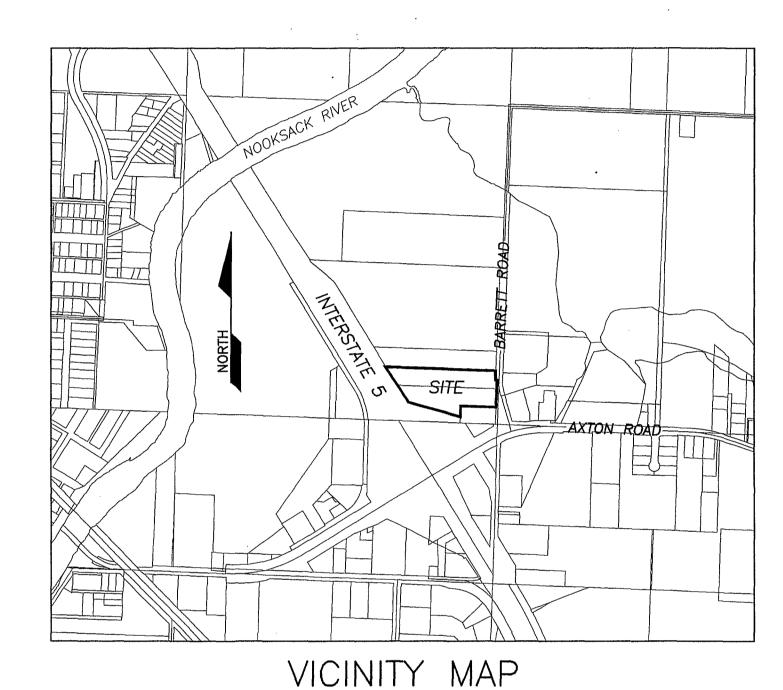

SCALE: 1"=800'

CALL 2 DAYS BEFORE YOU DIG 1-800-424-5555

### CIVIL PLAN INDEX

- COVER SHEET AND GENERAL NOTES
- EXISTING CONDITIONS PLAN
- HORIZONTAL CONTROL/SURVEY BOUNDARY MAP
- CIVIL SITE IMPROVEMENTS
- BARRETT ROAD IMPROVEMENTS
- DETAILS
- EROSION CONTROL PLAN

ENGINEER'S CERTIFICATION HEREBY CERTIFY THAT THE IMPROVEMENTS FOR JAVA TOWN ESPRESSO HAVE BEEN INSPECTED BY ASSOCIATED PROJECT CONSULTANTS, INC., P.S. AND CONSTRUCTED IN CONFORMANCE WITH THE PLANS APPROVED BY THE PUBLIC WORKS DIRECTOR FOR SAID DEVELOPMENT AND THE GENERAL SPECIFICATIONS ADOPTED BY THE CITY OF FERNDALE DEPARTMENT OF PUBLIC WORKS.




CITY OF FERNDALE PROJECT #DE2007-08


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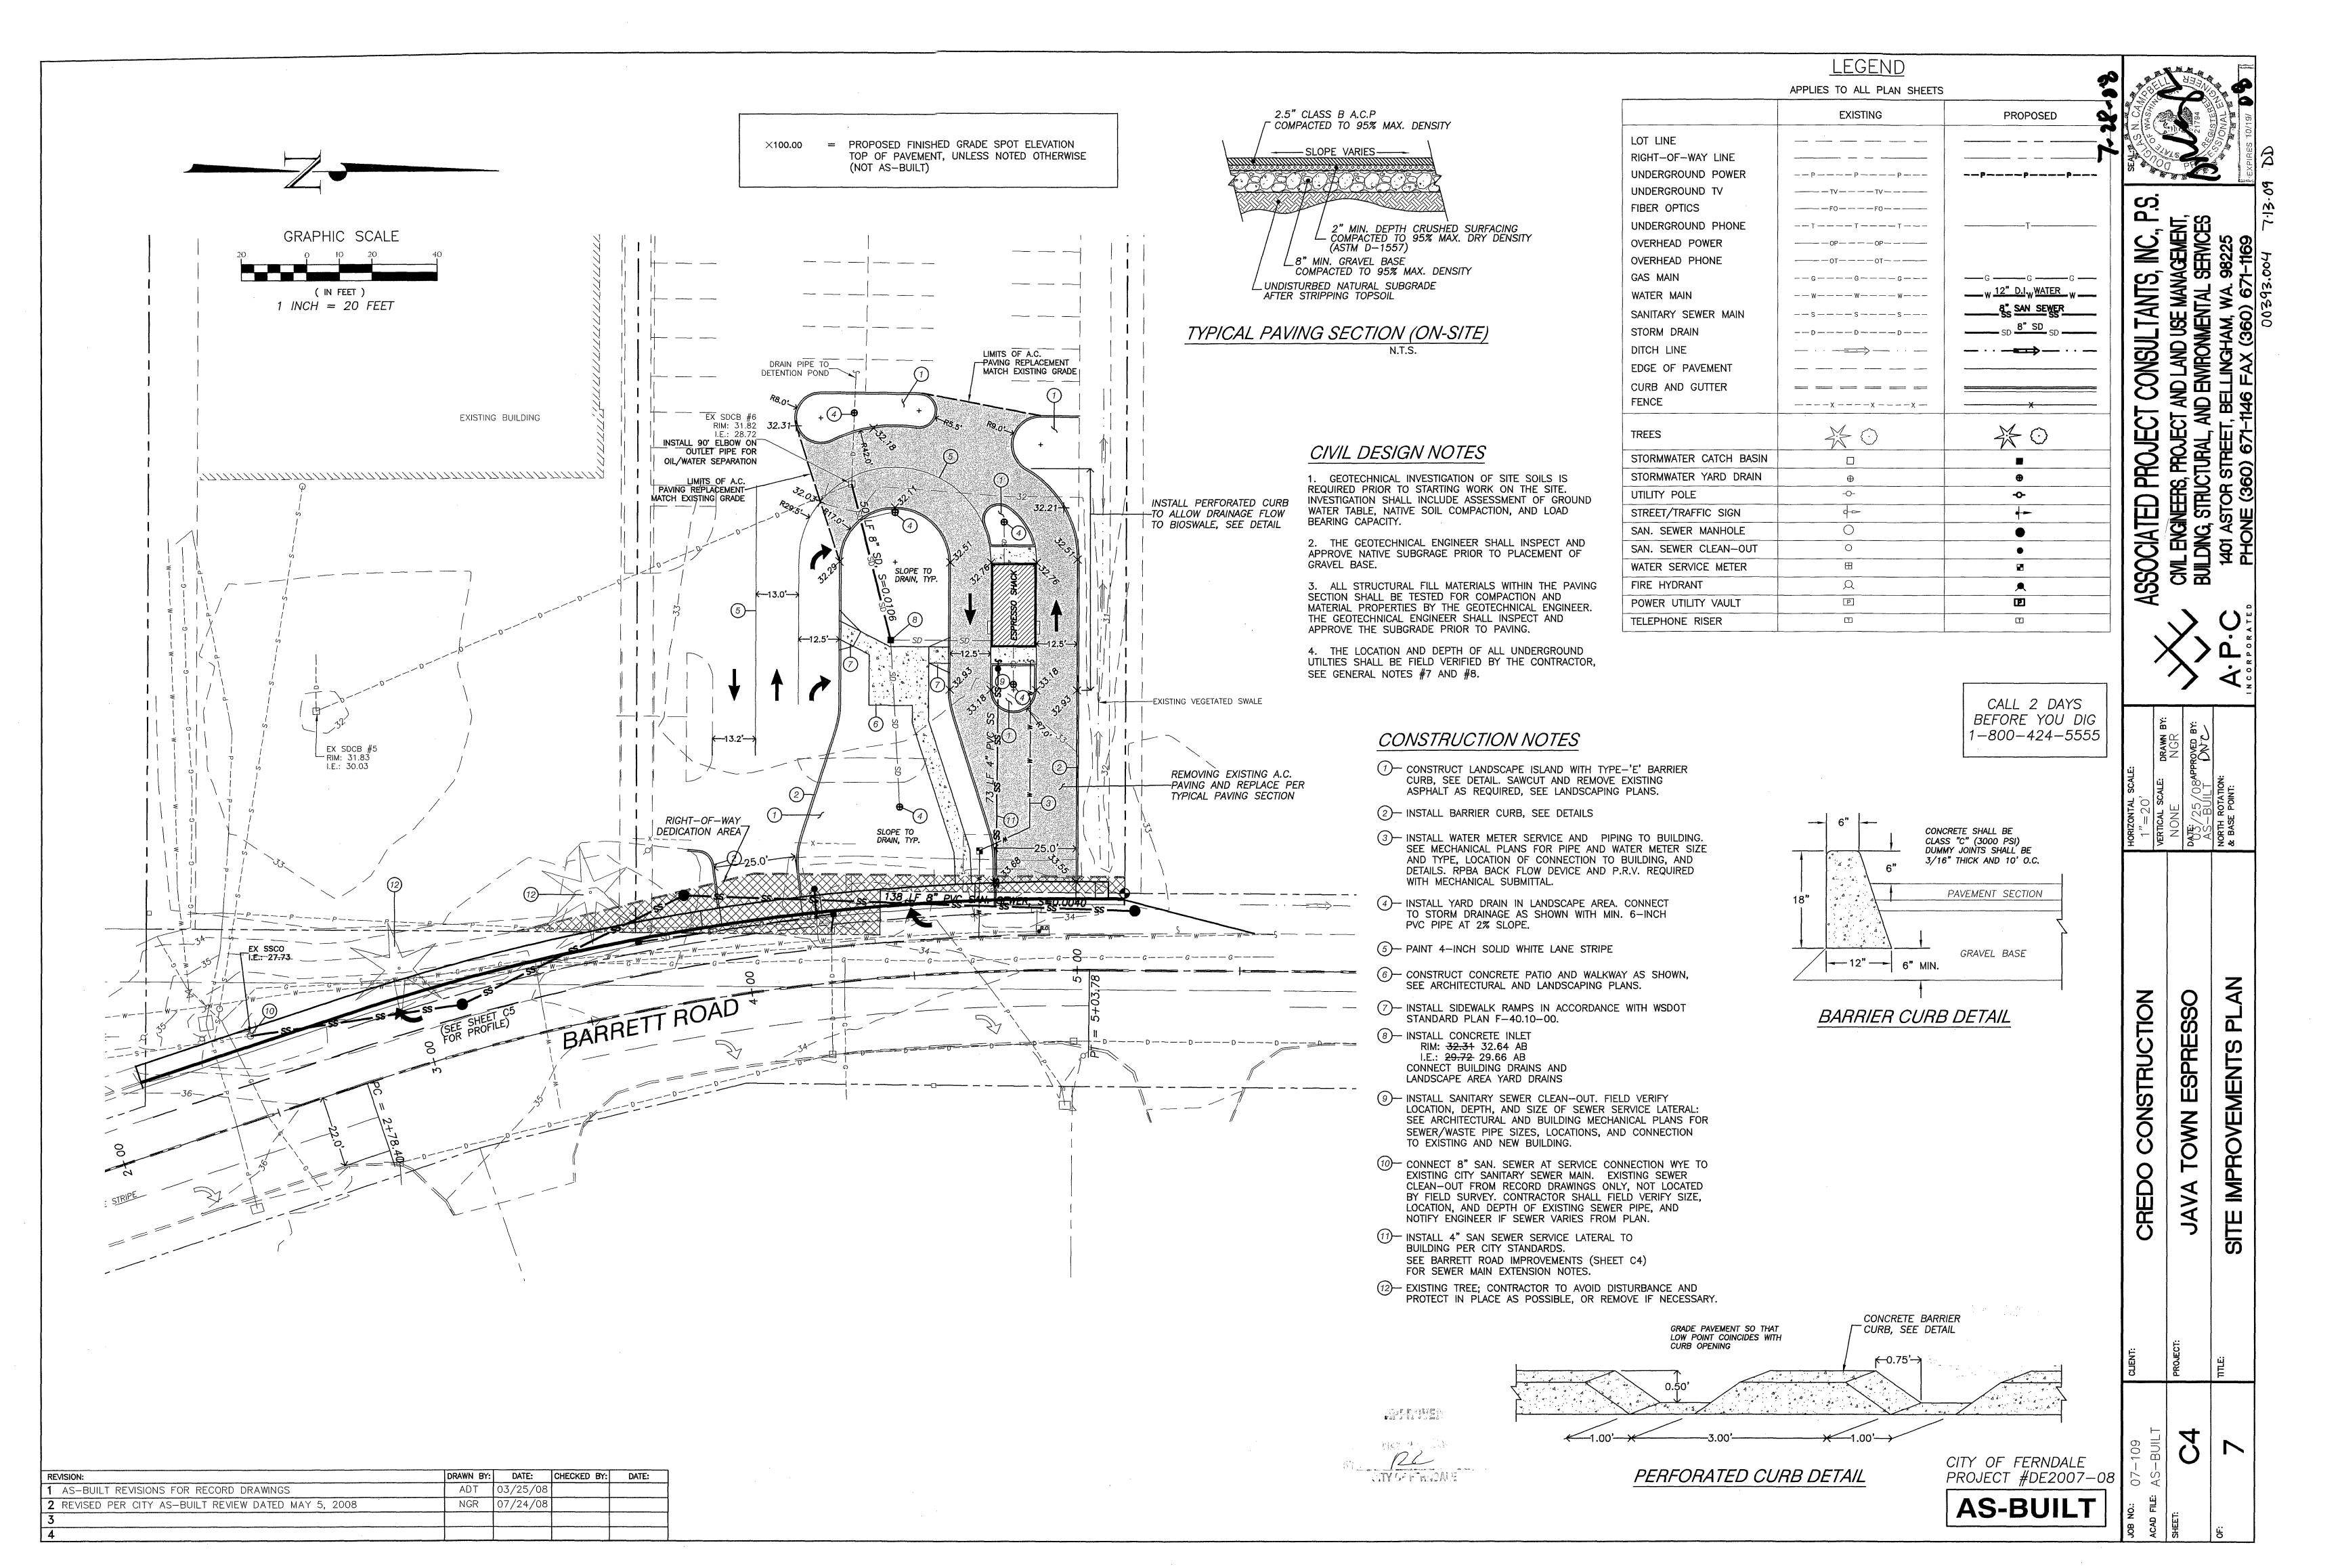
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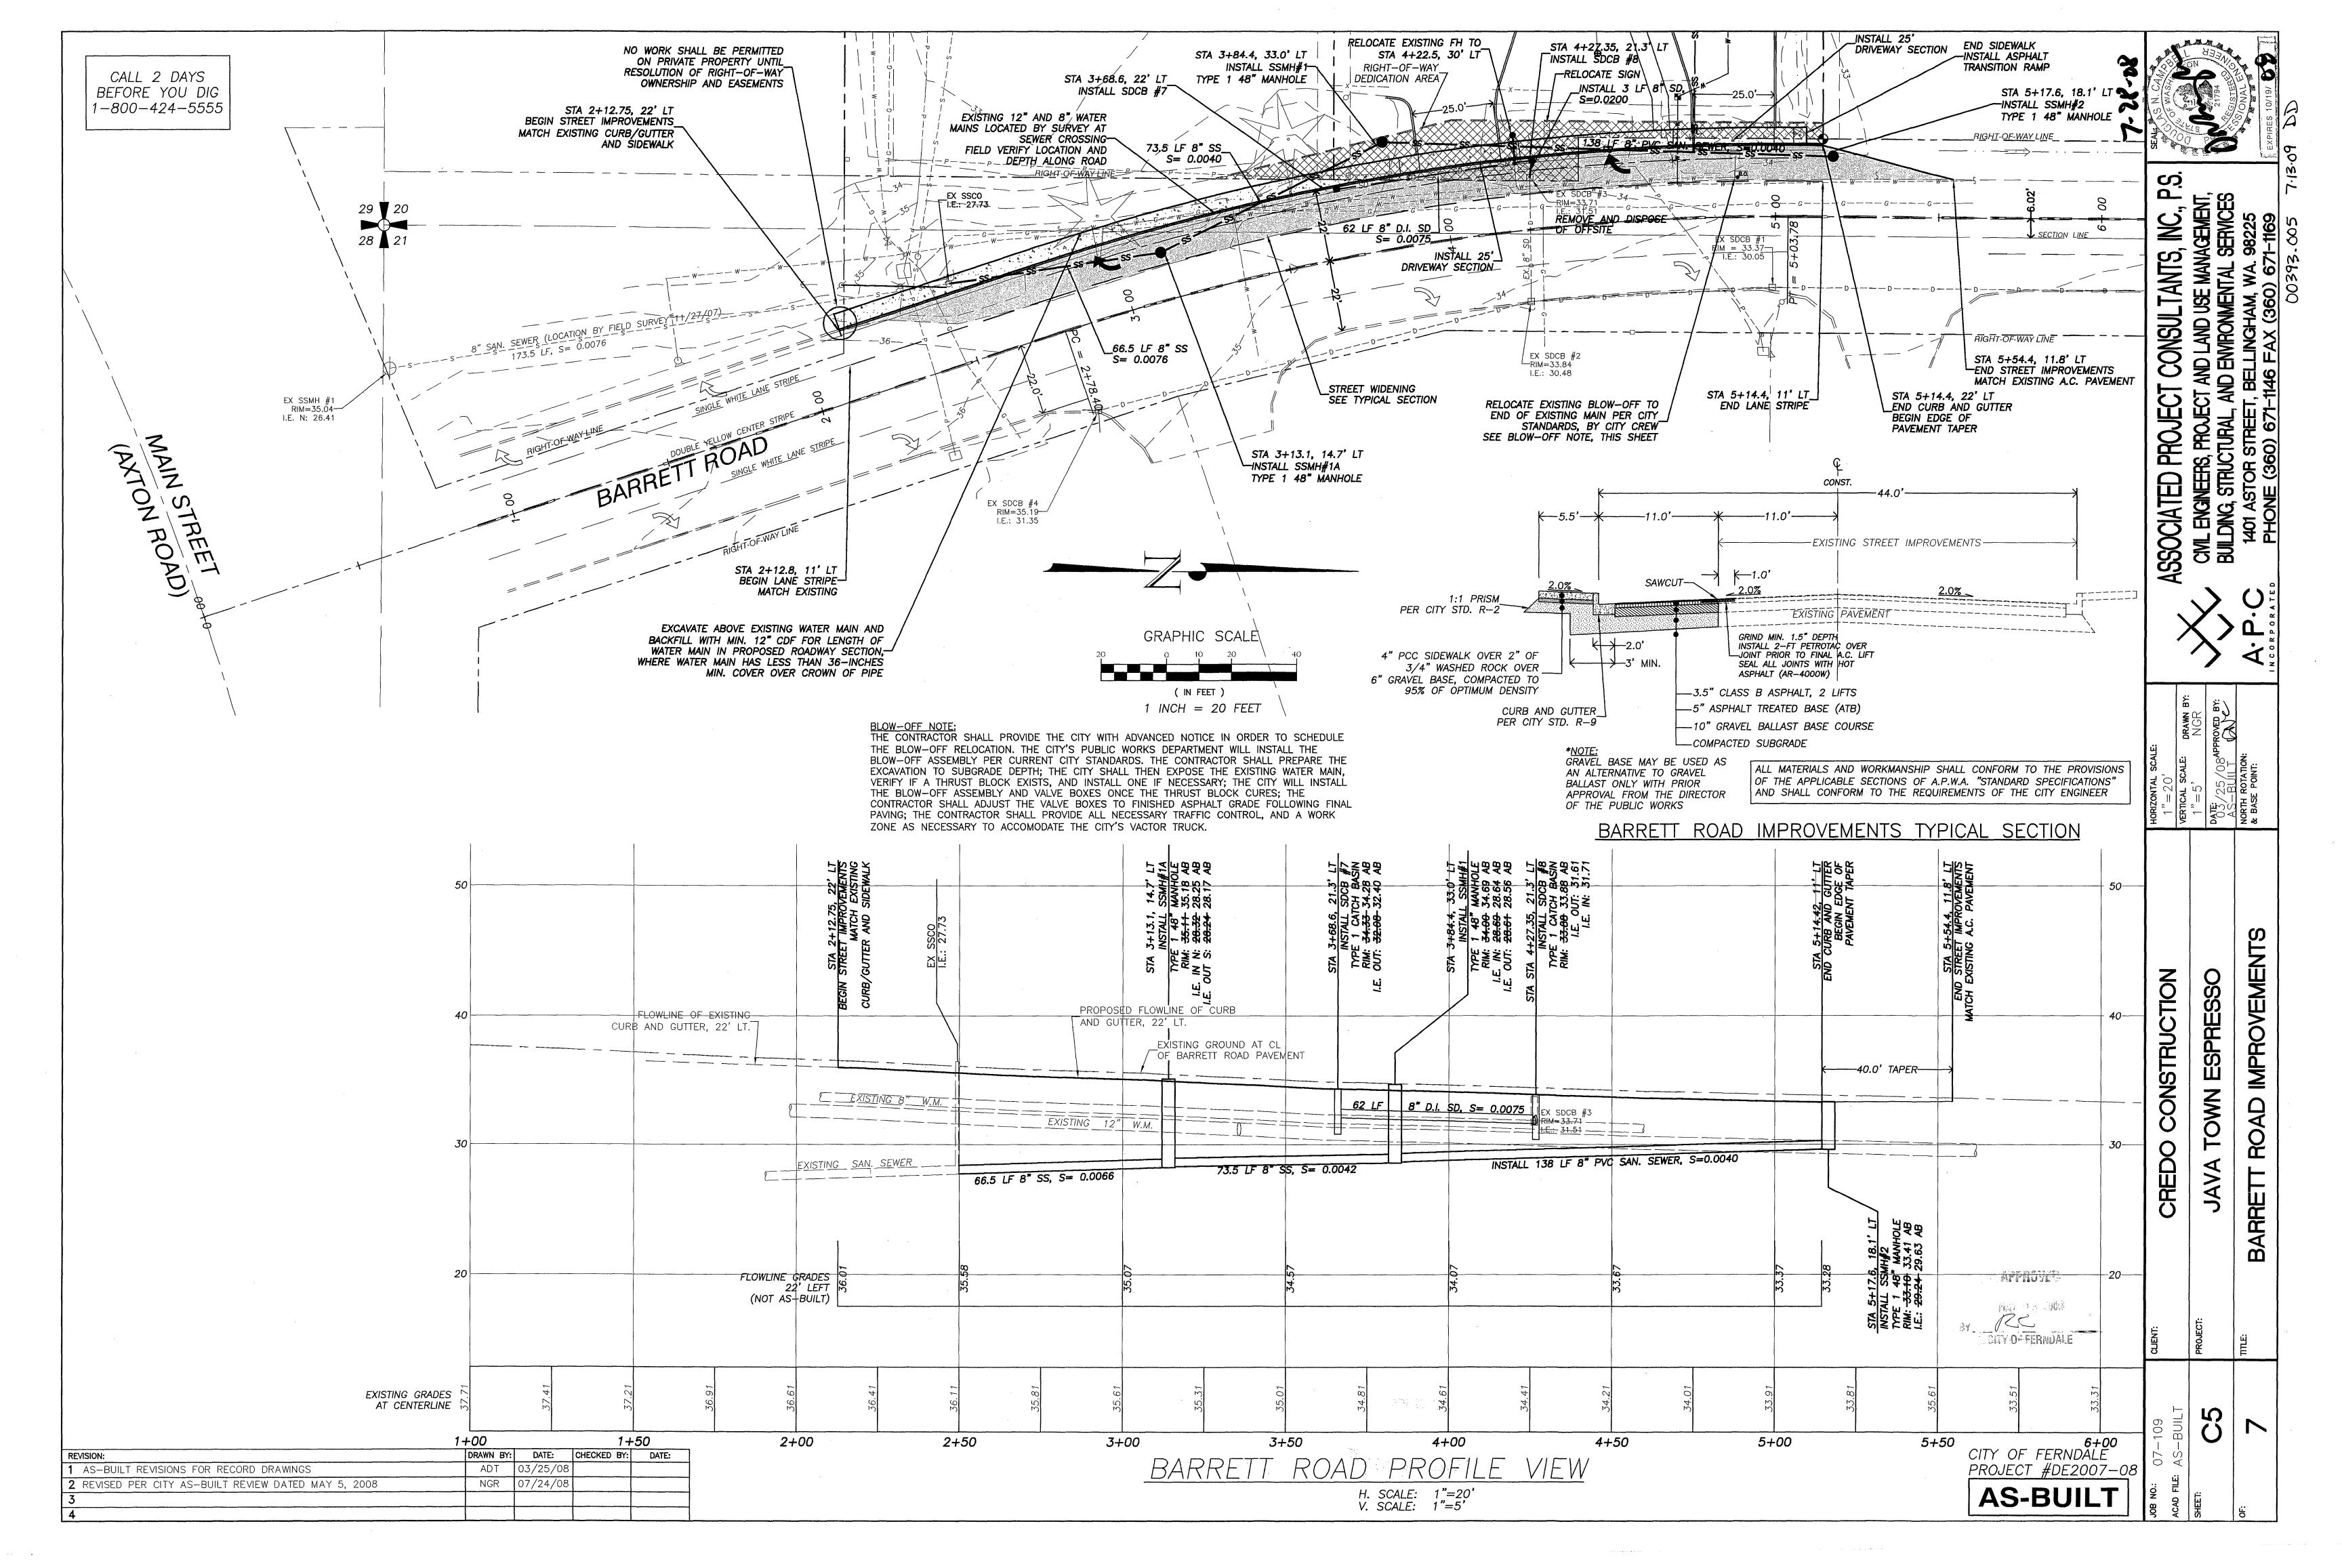
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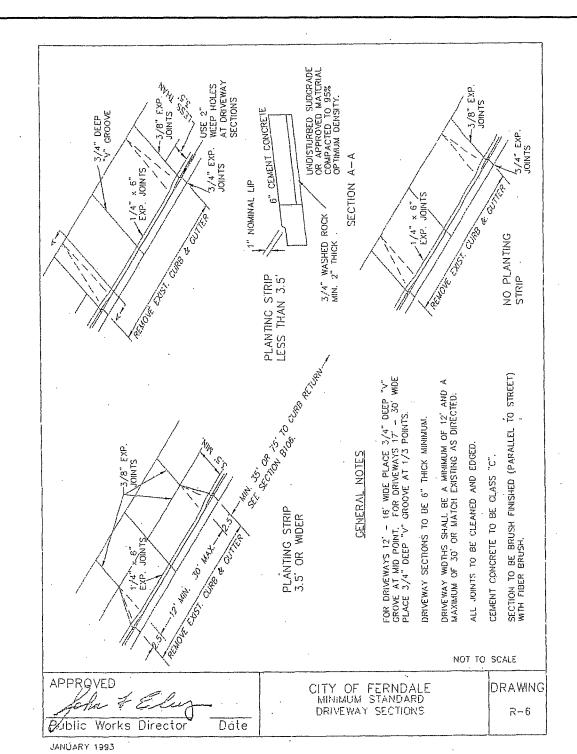
JAVA










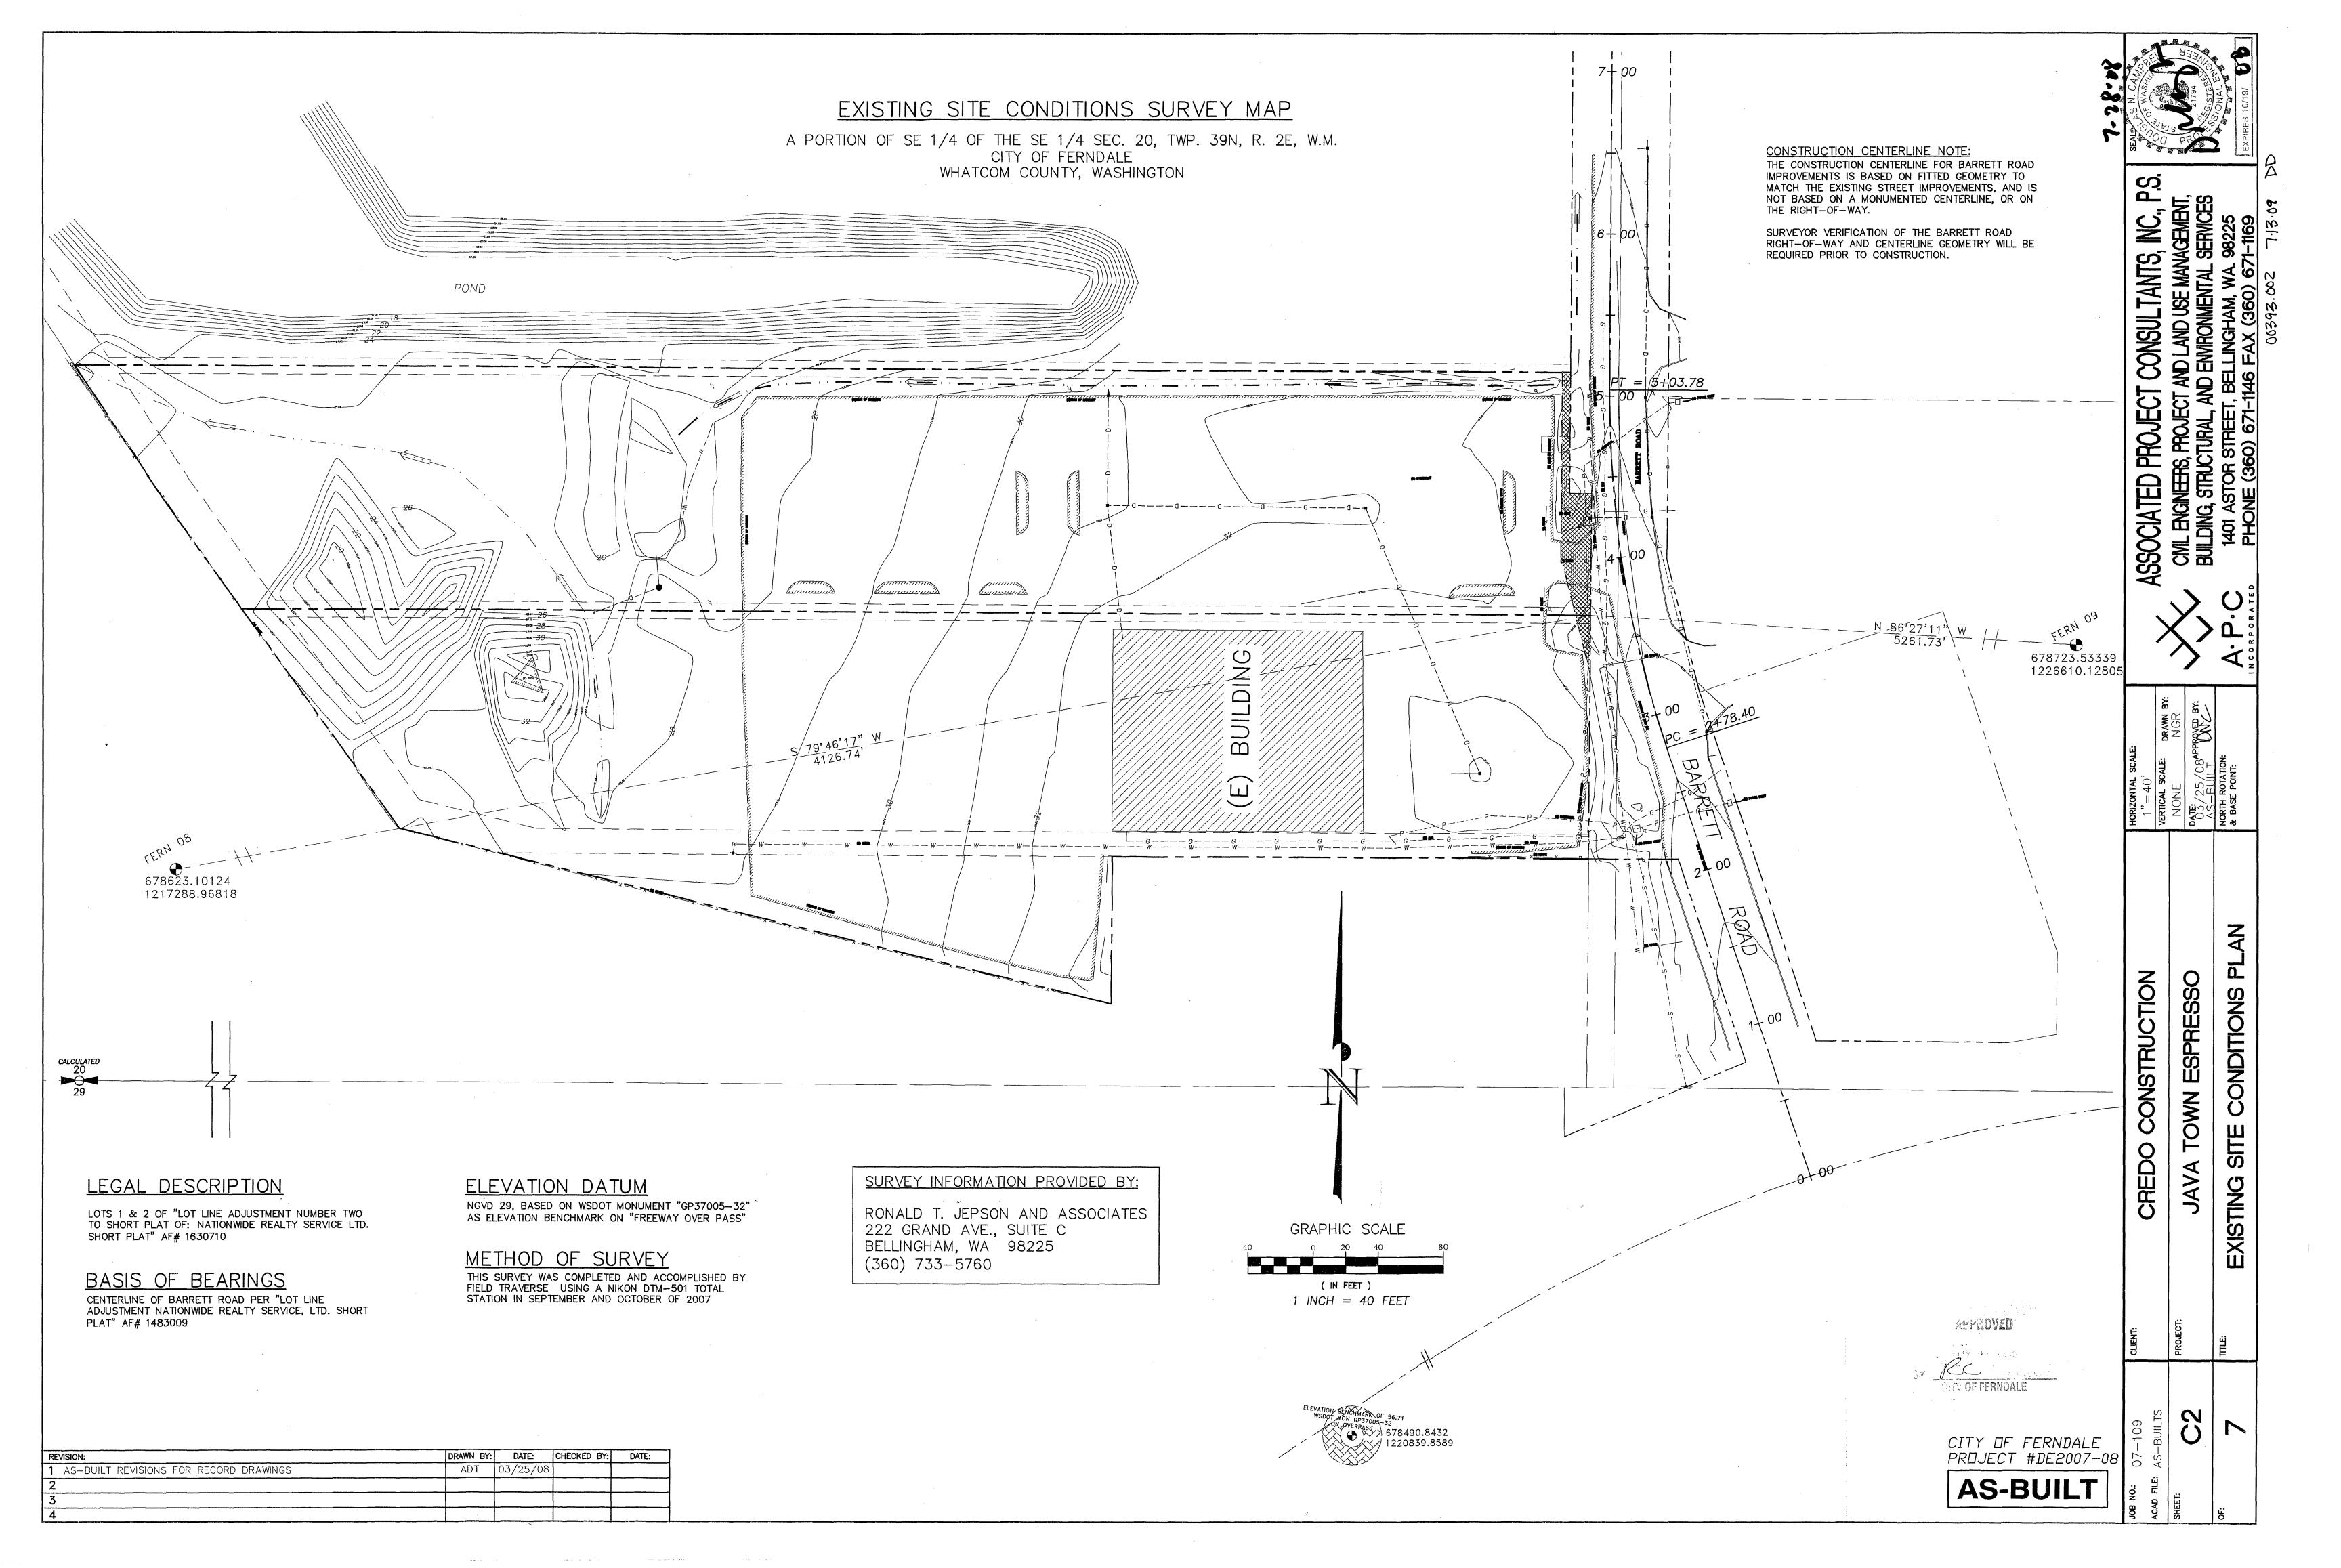


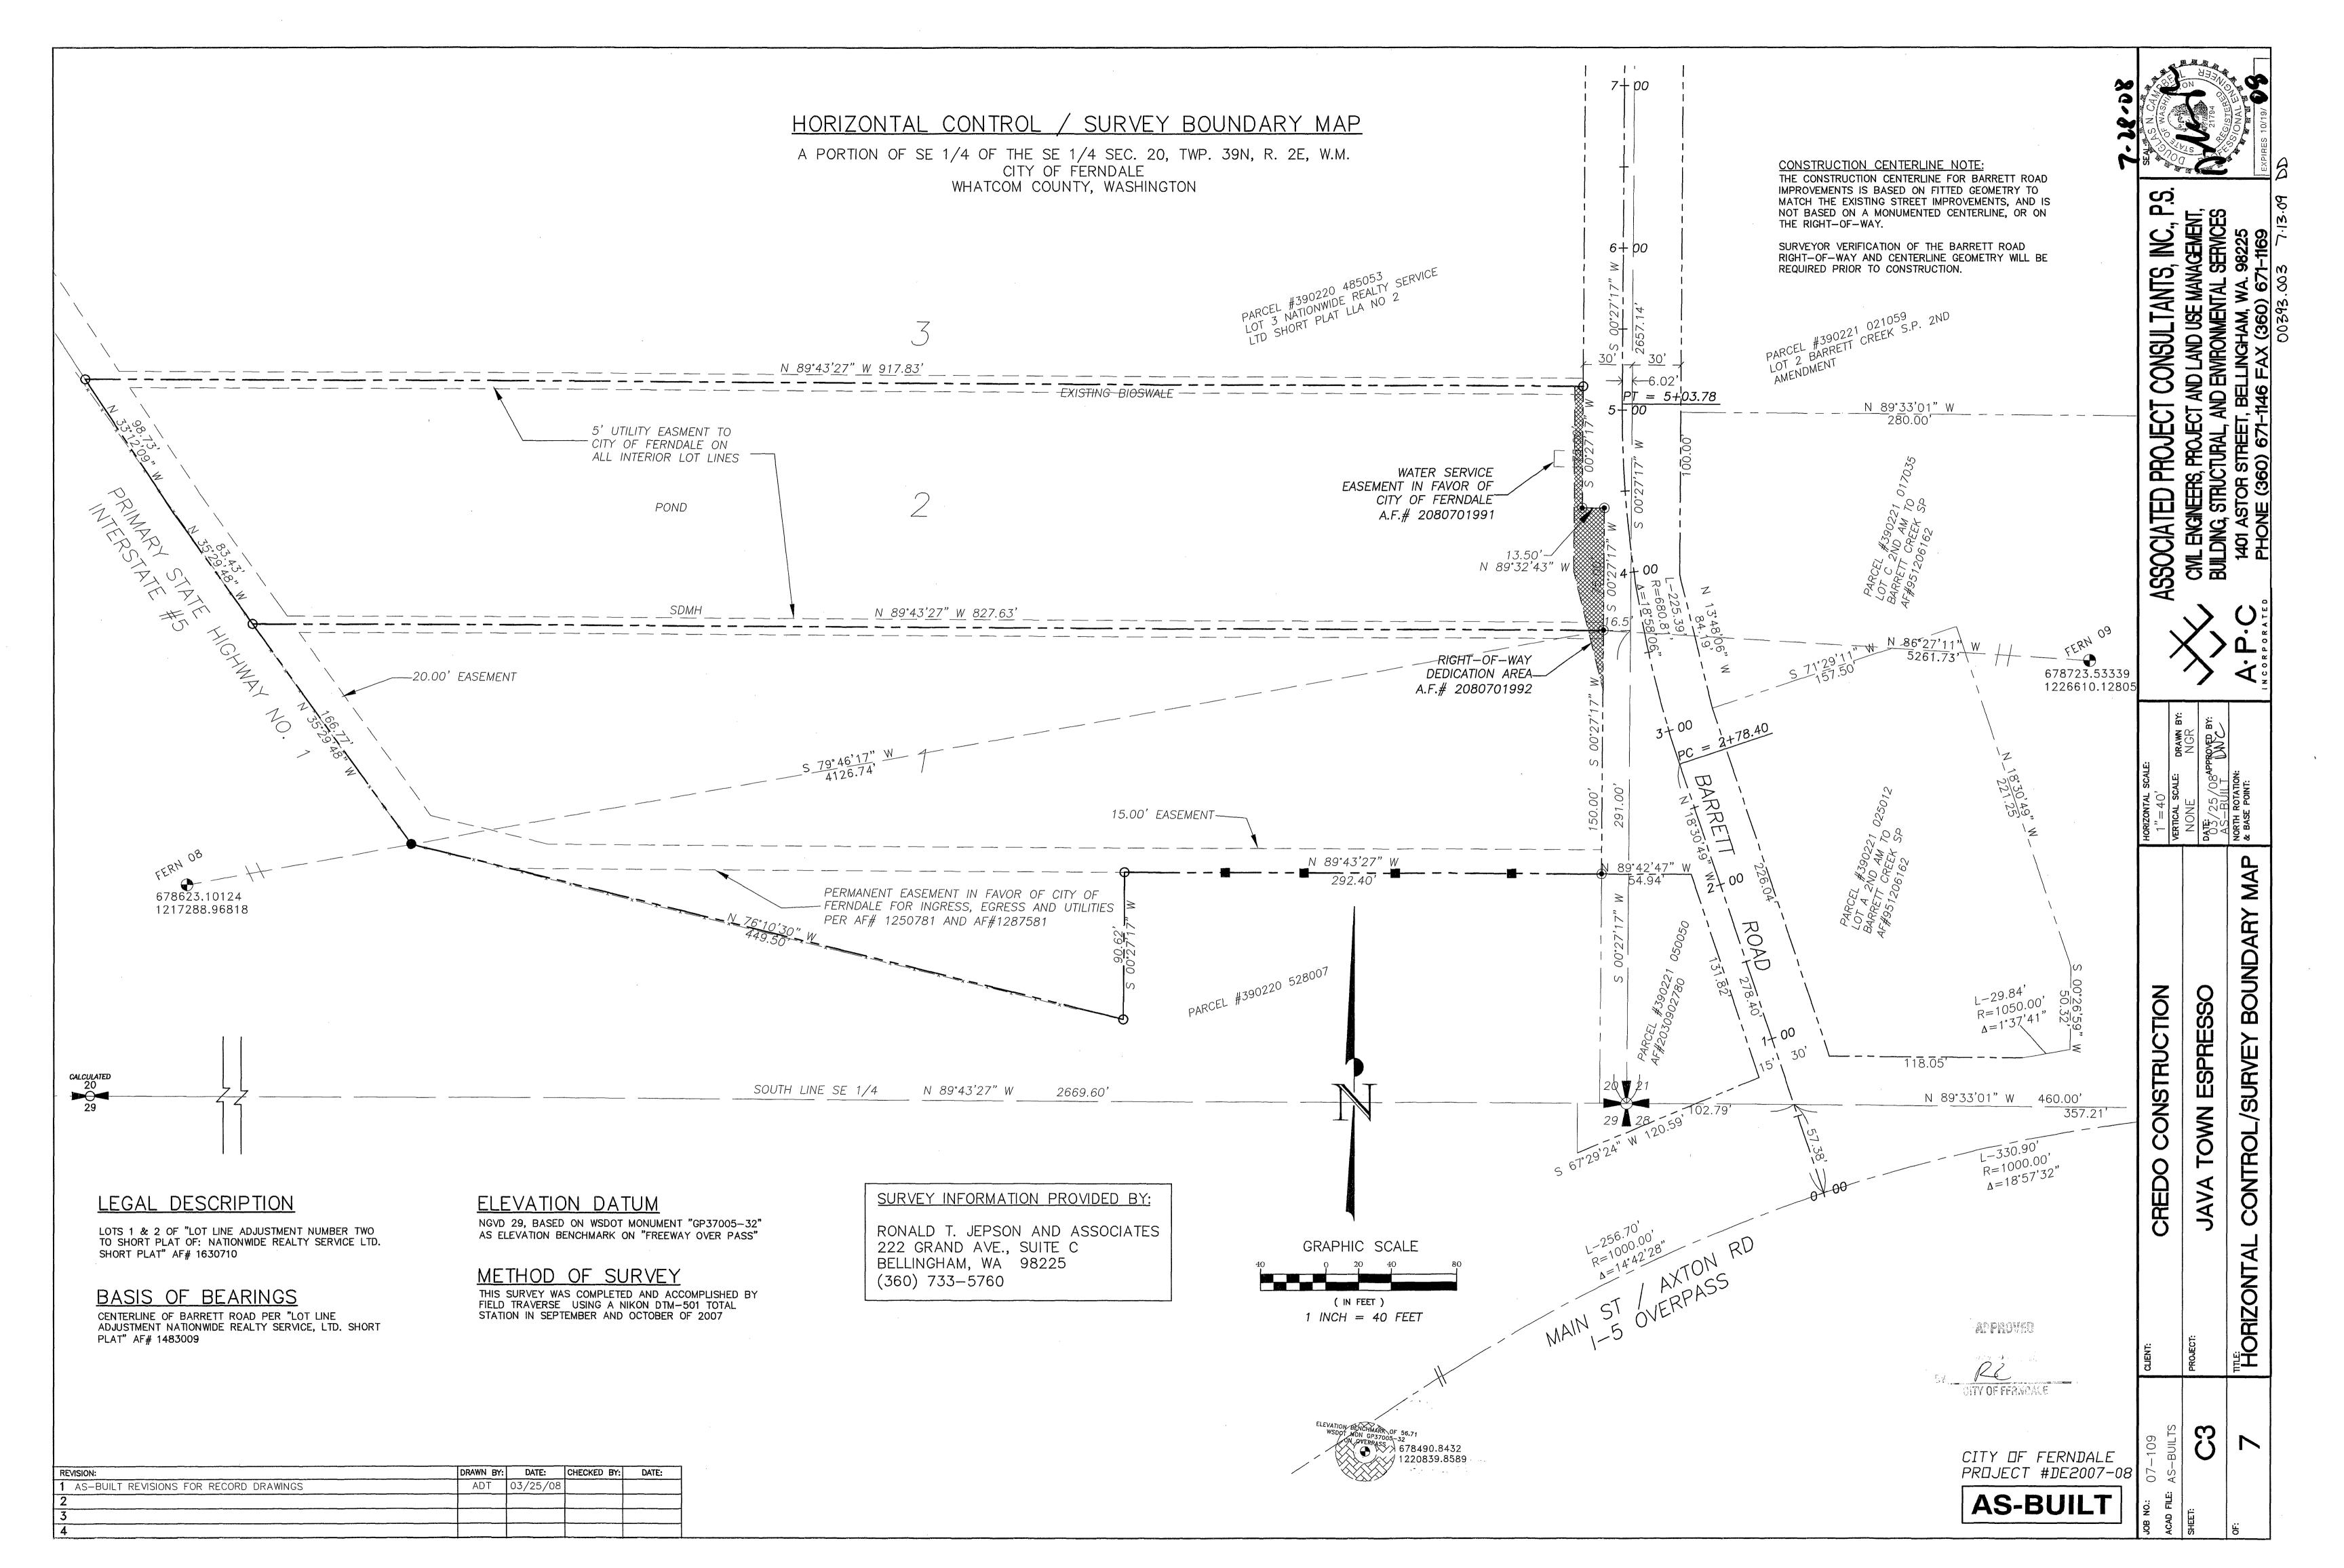

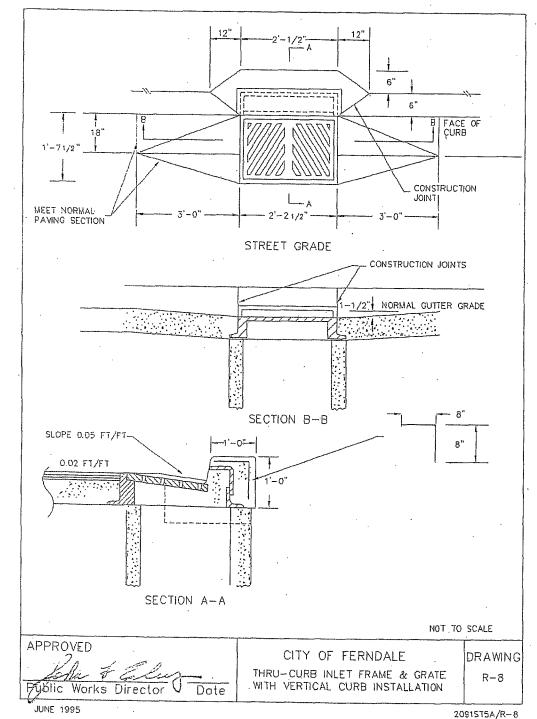

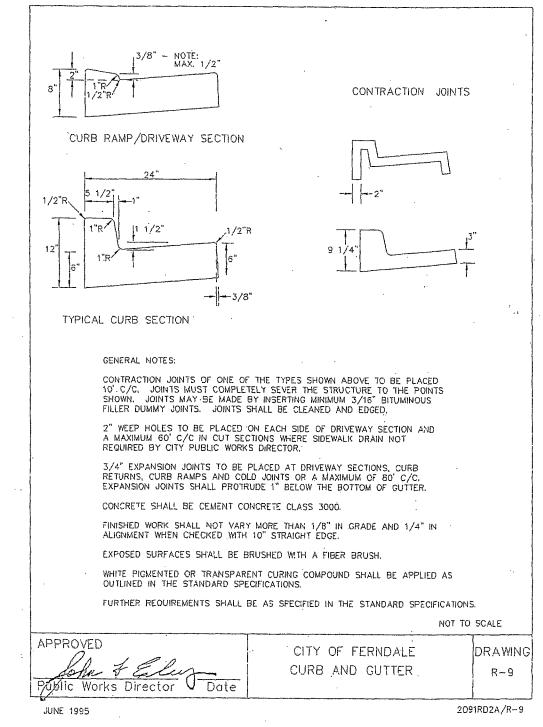

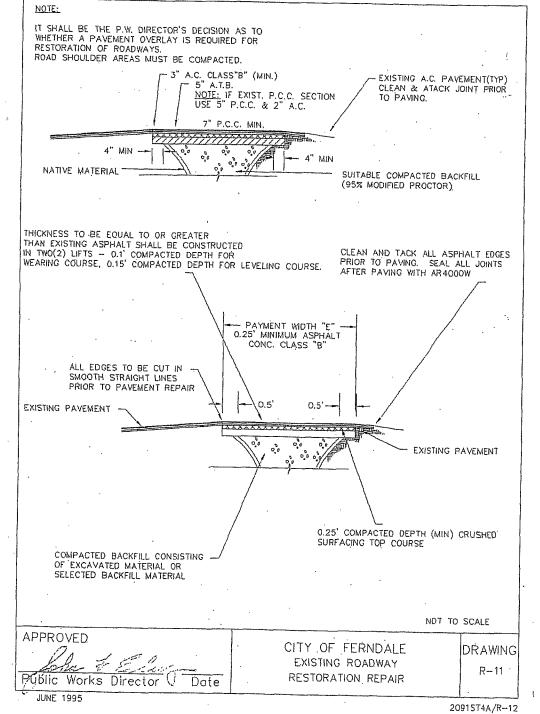

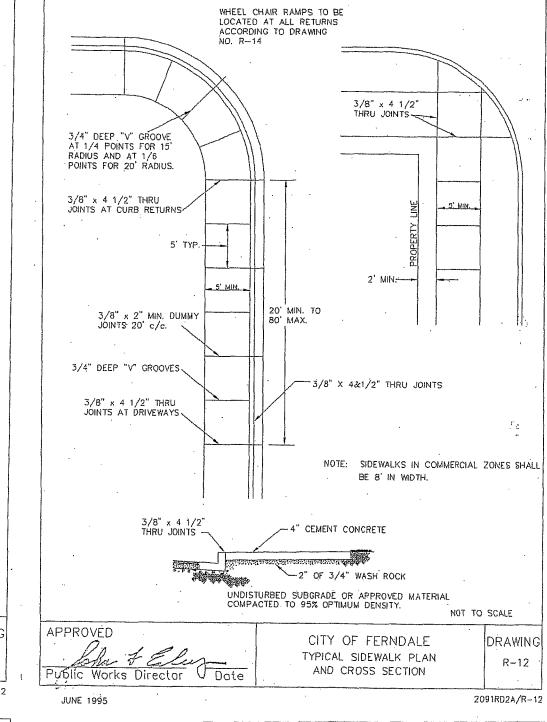

CONSULTANTS

**PROVECT** 

LAND USE MAN

II | B | D | Z &

CONSTRUCTION


CREDO


TOWN ESPRESSO


JAVA


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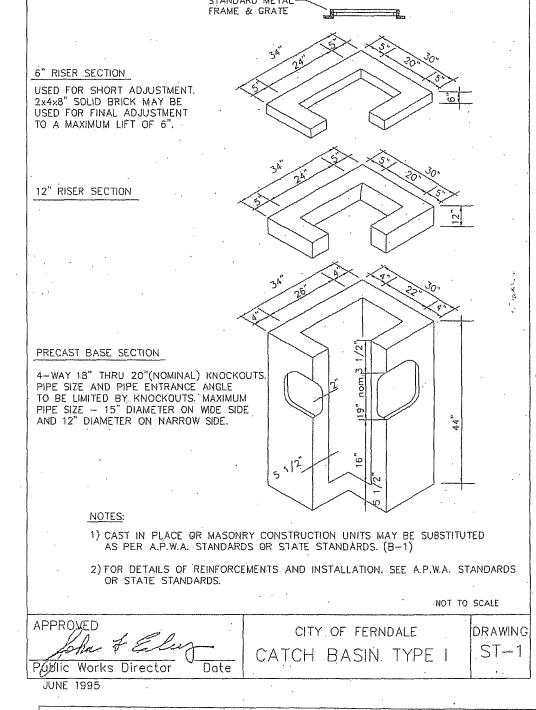
**DETAILS** 




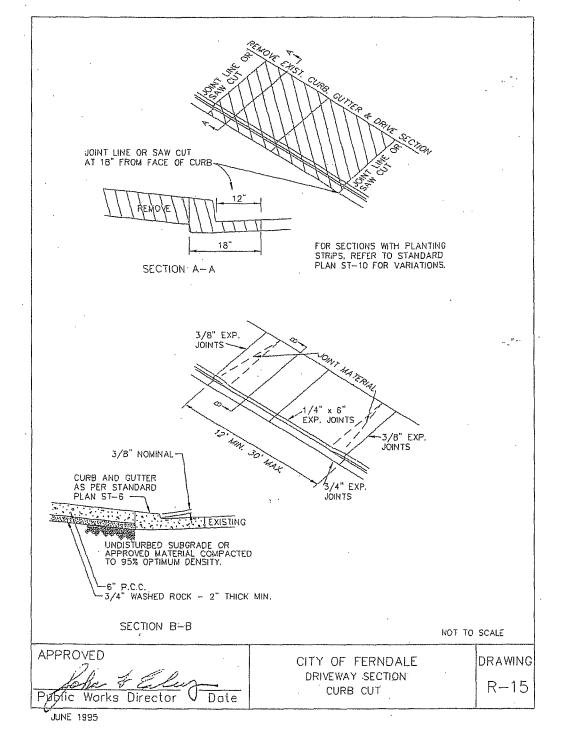

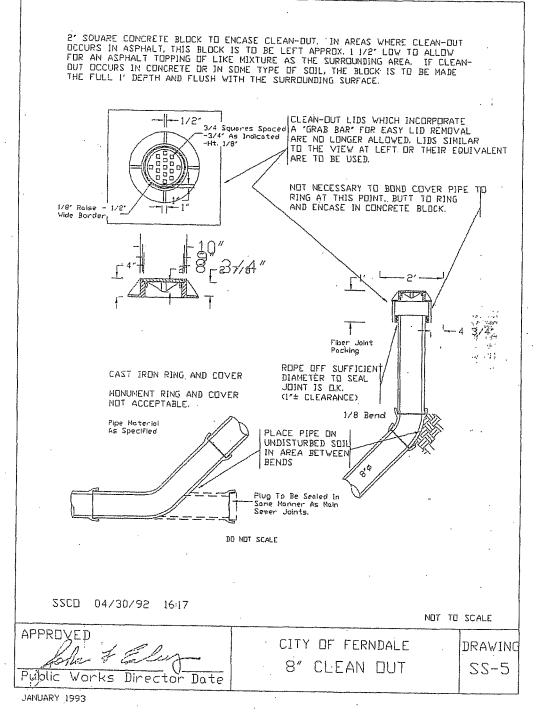

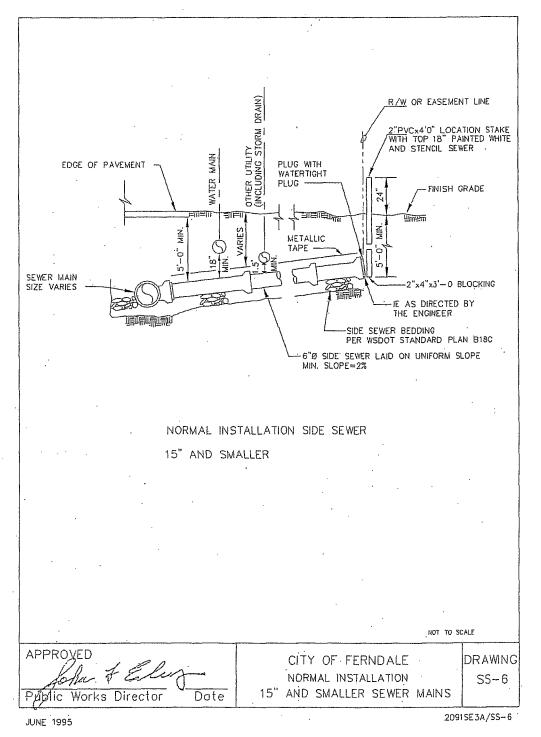

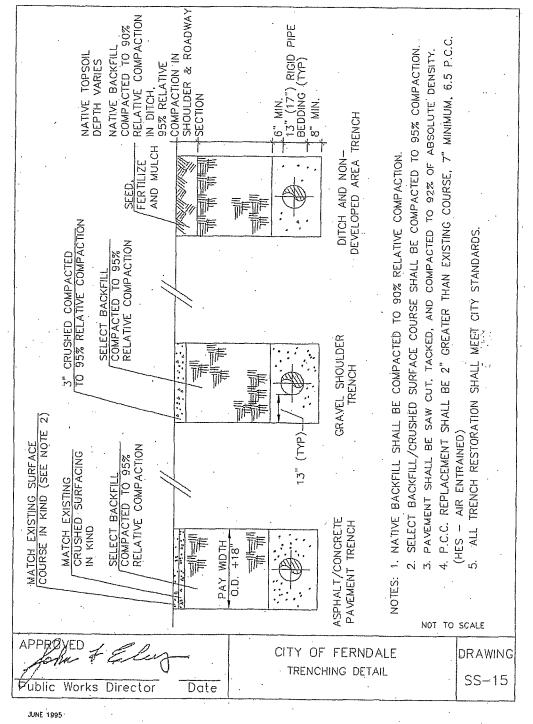

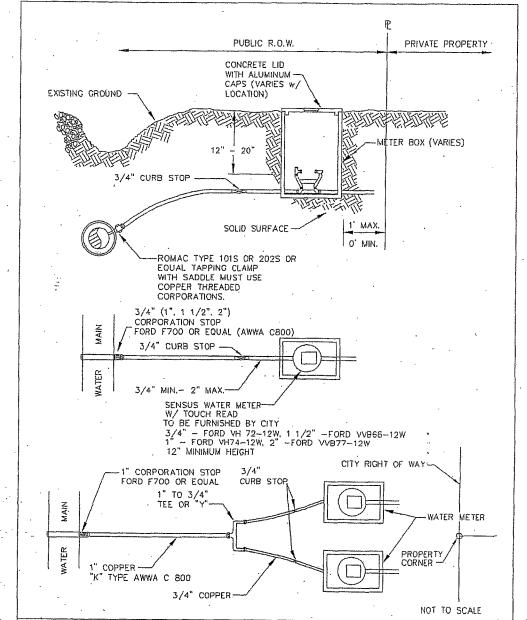

DRAWING


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REVISION:	DRAWN BY:	DATE:	CHECKED BY:	DATE:
1 AS-BUILT REVISIONS FOR RECORD DRAWINGS	ADT	03/25/08		
2 REVISED PER CITY AS-BUILT REVIEW DATED MAY 5, 2008	NGR	07/24/08		
3				
4				







# **EROSION CONTROL NOTES:**

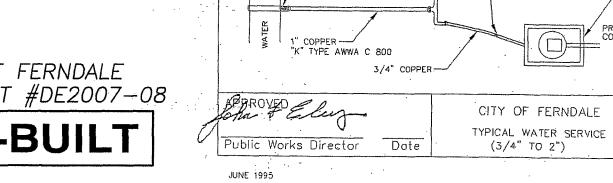EXISTING BUILDING

\_INSTALL CATCH

BASIN INSERT

ADAPTER SKIRT-TRIM TO WITHIN

GEOTEXTILE FABRIC -

PLACEMENT OF A NEW CATCH BASIN.

17/24/08

NGR

USE STAPLES OR WIRE RINGS TO ATTACH FABRIC TO WIRE FILTER FABRIC MATERIAL 60" WIDE ROLLS

2"x4" WOOD POSTS, STANDARD OR BETTER OR EQUAL ALTERNATE: STEEL FENCE POSTS.

CITY OF FERNDALE

SILT FENCE DETAIL

NOT TO SCALE

DRAWING

ST-10

MATERIAL

PROVIDE 3/4"-1 1/2"
WASHED GRAVEL BACKFILL
IN TRENCH AND ON BOTH SIDES
OF FILTER FENCE FABRIC ON
THE SURFACE

2" BY 4" WOOD POST

Public Works Director

1 AS-BUILT REVISIONS FOR RECORD DRAWINGS

2 REVISED PER CITY AS-BUILT REVIEW DATED MAY 5, 2008

INSTALL CATCH

INSTALL CATCH

GRAPHIC SCALE

1 INCH = 20 FEET

DRIVEWAY RAMP OR PAVED SURFACE

\_GEOTEXTILE BENEATH

4" TO 6" QUARRY SPALLS

PAD SHALL BE REMOVED AND REPLACED WHEN SOIL IS EVIDENT ON THE SURFACE OF THE PAD OR AS DIRECTED BY THE CITY.

3. PAD THICKNESS SHALL BE INCREASED IF SOIL CONDITIONS DICTATE OR PER THE DIRECTION OF THE CITY.

4. MINIMUM DIMENSIONS MAY BE MODIFIED AS REQUIRED BY SITE CONDITIONS UPON APPROVAL OF THE CITY.

CONSTRUCTION ENTRANCE/EXIT

2. PAD SHALL BE INSTALLED IN PLANTING STRIP AS APPROPRIATE.

\_B`ASIN\_INSERT-

SPILLWAY LOWER THAN-OUTER EDGE OF DAM

---CHECK DAM

NO DISTURBANCE TO

EXISTING SWALE ALLOWED

SAND OR GRAVEL
FILLED BAGS. EDGE OF DITCH

— SAND OR GRAVEL FILLED BAGS,

DITCH C/L

~SPILLWAY

DITCH C/L

SECTION A-A

TYPICAL CHECK DAM

CHECK DAM

-BASIN INSERT

LIMIT OF ON-SITE

DISTURBANCE

INSTALL DROP INLET

CONSTRUCTION

ENTRANCE/EXIT,-

INSTALL CATCH

BASIN INSERT

RETRIEVAL STRAP

OVERFLOW BYPASS FOR PEAK STORM VOLUMES

SEDIMENT ACCUMULATION

1. INSERT SHALL BE INSTALLED PRIOR TO CLEARING AND GRADING ACTIVITY, OR UPON

3. SEDIMENT REMOVAL SHALL BE ACCOMPLISHED BY REMOVING THE INSERT, EMPTYING, AND RE-INSERTING IT INTO THE CATCH BASIN.

CATCH BASIN INSERT

DATE: CHECKED BY: DATE:

2. SEDIMENT SHALL BE REMOVED FROM THE UNIT WHEN IT BECOMES HALF FULL.

SEE DETAIL

SEDIMENT POOL,-

SEE DETAIL

1. THE IMPLEMENTATION OF THE APPROVED STORMWATER POLLUTION PREVENTION PLANS (SWPPP) INCLUDING THIS TEMPORARY EROSION AND SEDIMENTATION CONTROL PLAN (TESCP), AND THE CONSTRUCTION, MAINTENANCE, REPLACEMENT, AND UPGRADING OF EROSION CONTROL FACILITIES AND POLLUTION PREVENTION BMP'S IS THE RESPONSIBILITY OF THE CONTRACTOR UNTIL ALL CONSTRUCTION IS COMPLETED AND APPROVED AND VEGETATION IS ESTABLISHED.

2. THE EROSION CONTROL FACILITIES AND MEASURES SHOWN ON THIS PLAN AND DESCRIBED IN THE SWPPP MUST BE CONSTRUCTED AND CARRIED OUT IN CONJUNCTION WITH ALL LAND DISTURBING ACTIVITIES, AND IN SUCH A MANNER AS TO ENSURE THAT SEDIMENT AND SEDIMENT LADEN WATER DO NOT ENTER THE DRAINAGE SYSTEM ROADWAYS, OR VIOLATE APPLICABLE WATER STANDARDS. THE EROSION CONTROL FACILITIES SHOWN ON THIS PLAN ARE THE MINIMUM REQUIREMENTS FOR ANTICIPATED SITE CONDITIONS, DURING THE CONSTRUCTION PERIOD, THESE EROSION CONTROL FACILITIES SHALL BE UPGRADED AS NEEDED FOR UNEXPECTED STORM EVENTS AND TO ENSURE THAT SEDIMENT AND SEDIMENT LADEN WATER DO NOT LEAVE THE SITE.

3. THE EROSION CONTROL FACILITIES SHALL BE INSPECTED DAILY BY THE CONTRACTOR AND MAINTAINED AS NECESSARY TO ENSURE THEIR CONTINUED FUNCTIONING. THE EROSION CONTROL FACILITIES ON INACTIVE PORTIONS OF THE SITE SHALL BE INSPECTED AND MAINTAINED A MINIMUM OF ONCE PER MONTH OR WITHIN 48 HOURS FOLLOWING A MAJOR STORM EVENT. IF AT ANY TIME IT IS DETERMINED THAT THE OBJECTIVES OF THE TEMPORARY EROSION AND SEDIMENTATION CONTROL PLAN ARE NOT BEING MET, ADDITIONAL DEPARTMENT OF ECOLOGY BEST MANAGEMENT PRACTICES MAY BE REQUIRED.

4. ALL STRUCTURAL EROSION CONTROL MEASURES AND FACILITIES ARE TO BE IN PLACE PRIOR TO THE COMMENCEMENT OF CONSTRUCTION.

5. ALL DISTURBED AREAS OR EXPOSED SOILS SHALL BE COVERED WITH MULCH OR WOOD CHIPS IF SOILS ARE TO REMAIN UNWORKED FOR MORE THAN 2 DAYS, OCTOBER 1 THROUGH APRIL 30, OR 7 DAYS, MAY 1 THROUGH SEPTEMBER 30. UPON COMPLETION OF CONSTRUCTION, ALL DISTURBED AREAS AND CUT/FILL SLOPES ARE TO BE SEEDED WITH THE FOLLOWING EROSION CONTROL SEED MIXTURE:

75-80% TALL FESCUE 10-15% SEASIDE/COLONIAL BENTGRASS 5-10% REDTOP

CONTRACTOR SHALL BE RESPONSIBLE FOR VEGETATION UNTIL IT IS FULLY ESTABLISHED, AS APPROVED BY THE ENGINEER.

6. ANY TEMPORARY DITCHES OR DIVERSIONS OF WATER SHALL BE ROUTED THROUGH STILLING POOLS AND PROVIDED WITH PEA GRAVEL OR STRAW BALE CHECK DAMS AT A MAXIMUM SPACING OF 50' O.C.

7. EXISTING CATCH BASINS ACCEPTING RUNOFF FROM THE SITE AND DRAINAGE INLETS PLACED INTO SERVICE PRIOR TO FULL SITE STABILIZATION SHALL BE PROTECTED WITH CATCH BASIN INSERTS PER CITY OF BELLINGHAM STANDARD PLAN EC-620.

8. ALL SAWCUTTING AND SURFACING SHALL BE PERFORMED IN ACCORDANCE WITH DEPARTMENT OF ECOLOGY BMP C152. SLURRY AND CUTTINGS SHALL BE VACUUMED DURING DURING SAWCUTTING OPERATIONS, SHALL NOT REMAIN ON PERMANENT PAVEMENT OVERNIGHT, SHALL NOT DRAIN TO ANY NATURAL OR CONSTRUCTED DRAINAGE CONVEYANCE, AND SHALL BE DISPOSED OF IN A MANNER THAT DOES NOT VIOLATE GROUNDWATER OR SURFACE WATER QUALITY STANDARDS.

ALL CONCRETE WORK SHALL BE PERFORMED IN ACCORDANCE WITH DEPARTMENT OF ECOLOGY BMP C151. CONCRETE TRUCK CHUTES, PUMPS, AND INTERNALS SHALL BE WASHED OUT ONLY INTO FORMED AREAS AWAITING INSTALLATION OF CONCRETE OR UNUSED CONCRETE REMAINING IN THE TRUCK AND PUMP SHALL BE RETURNED TO THE ORIGINATING BATCH PLANT FOR RECYCLING. HAND TOOLS SHALL BE WASHED OFF ONLY INTO FORMED AREAS AWAITING INSTALLATION OF CONCRETE OR ASPHALT. WASHDOWN FROM ANY AREAS SHALL NOT DRAIN DIRECTLY TO NATURAL OR CONSTRUCTE STORMWATER CONVEYANCES. WHEN NO FORMED AREAS ARE AVAILABLE, WASHWATER AND LEFTOVER PRODUCT SHALL BE CONTAINED IN A LINED CONTAINER AND DISPOSED OF IN A MANNER THAT DOES NOT VIOLATE GROUNDWATER OR SURFACE WATER QUALITY STANDARDS.

-BOTTOM WITH 6" INSTALL CATCH BASIN AND SD PIPE WITH INVERTS PER CONSTRUCTION INSTALL FILTER FABRIC LINER PLANS, LEAVE CB RIMS LOW FOR

DROP INLET SEDIMENT POOL DETAIL

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**EROSION CONTROL NOT** AS-BUILT

STORM WATER FACILITIES AS-BUILT